

KALAMA CREEK HATCHERY



PHASE 2



NATURAL RESOURCES DEPARTMENT

NISQUALLY INDIAN TRIBE

EDA AWARD NUMBER 07-79-07880

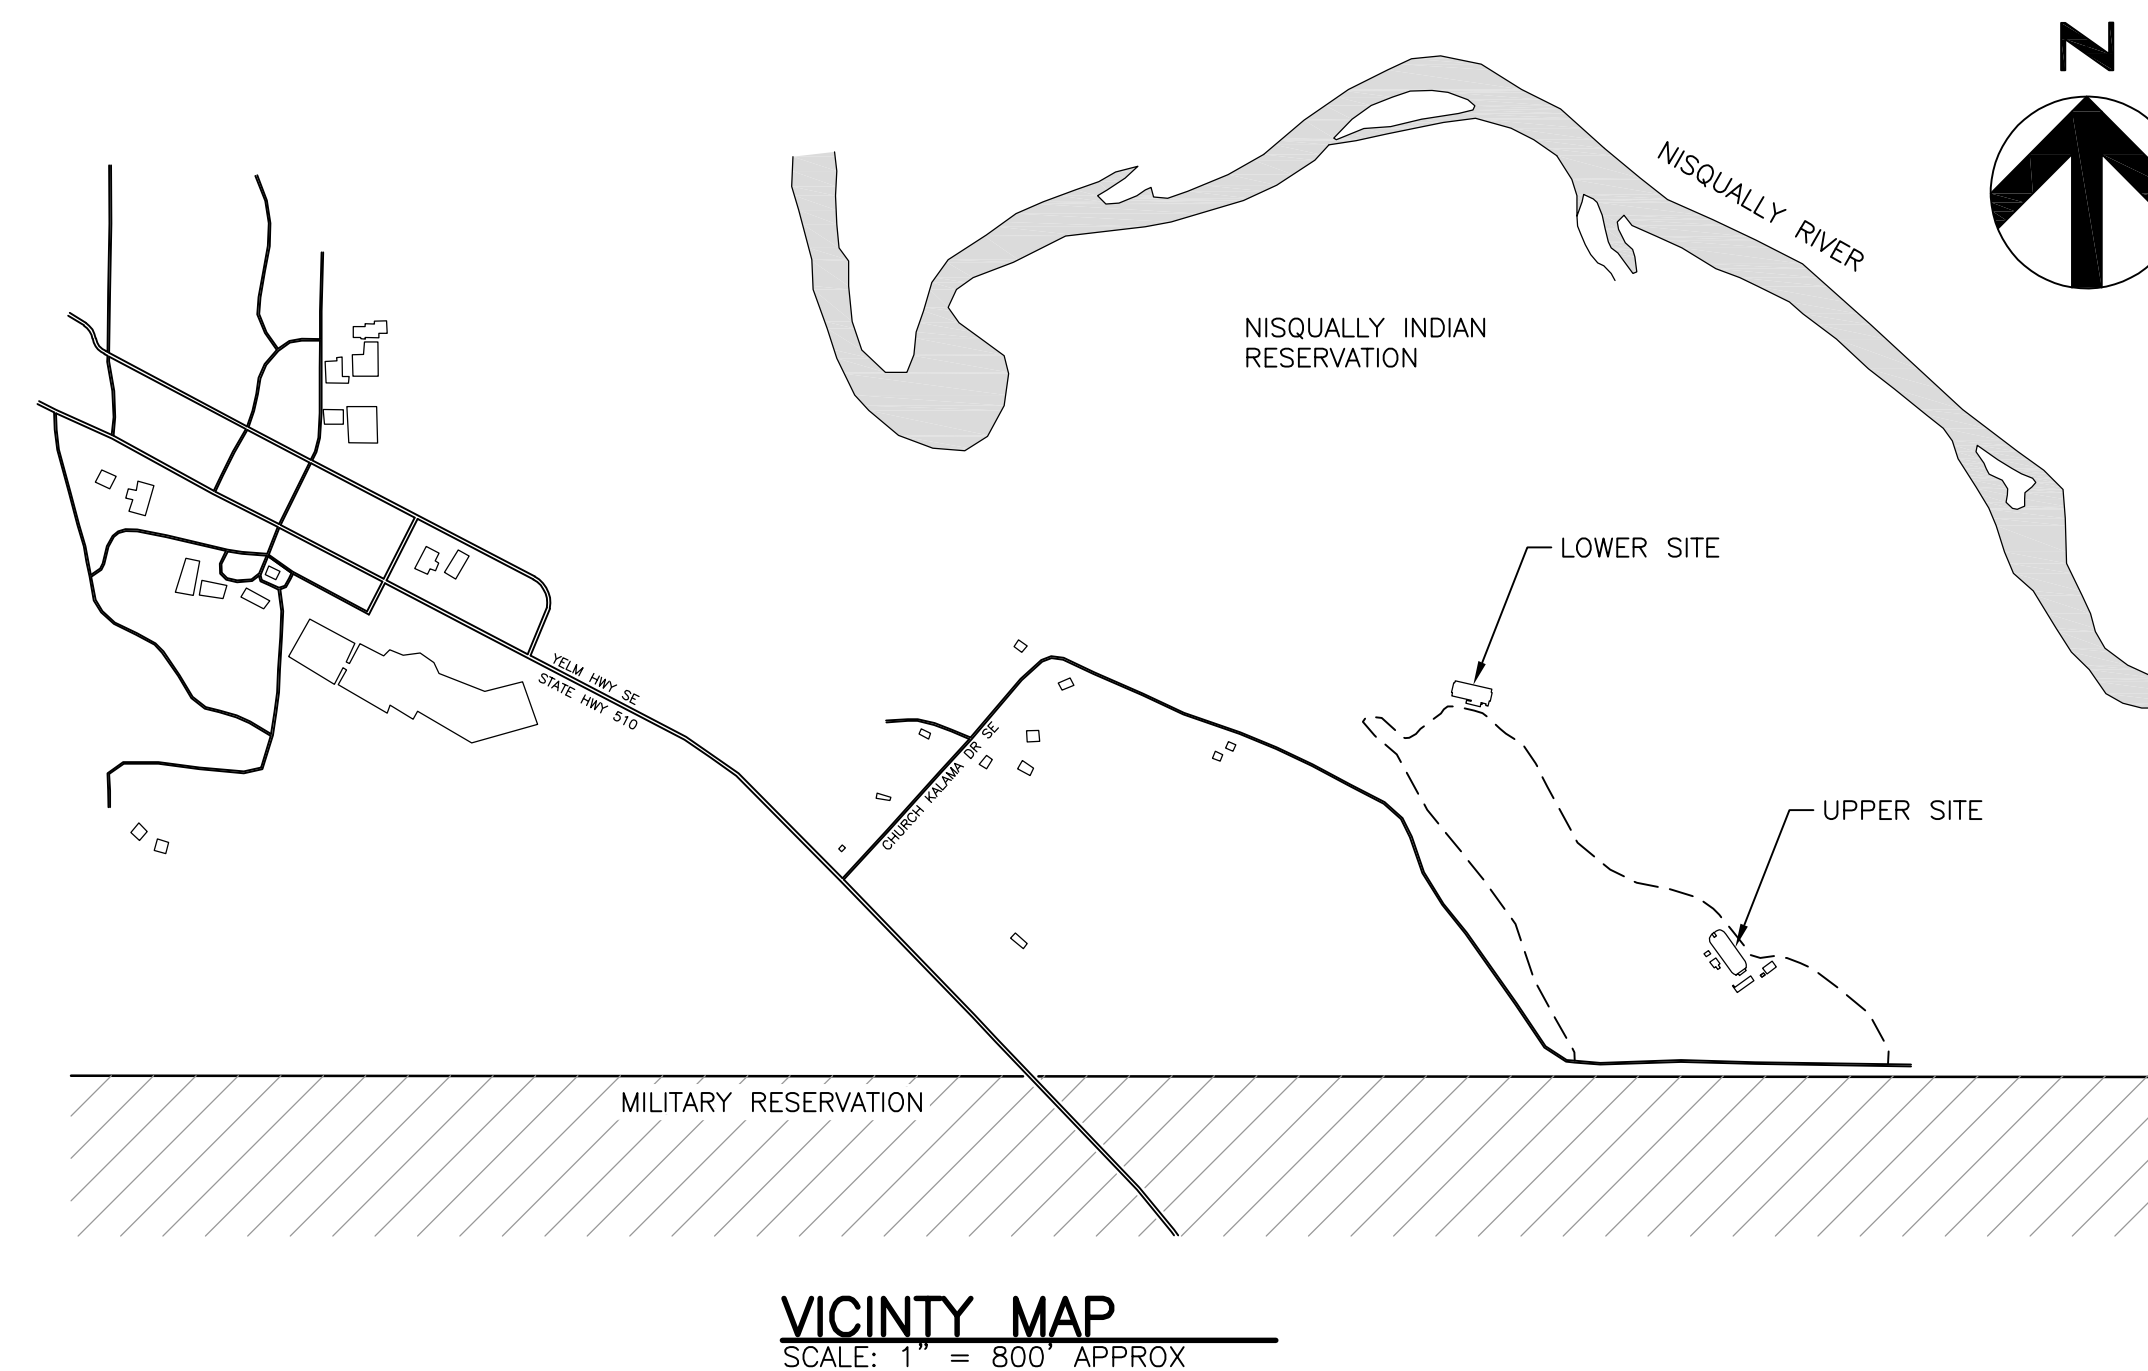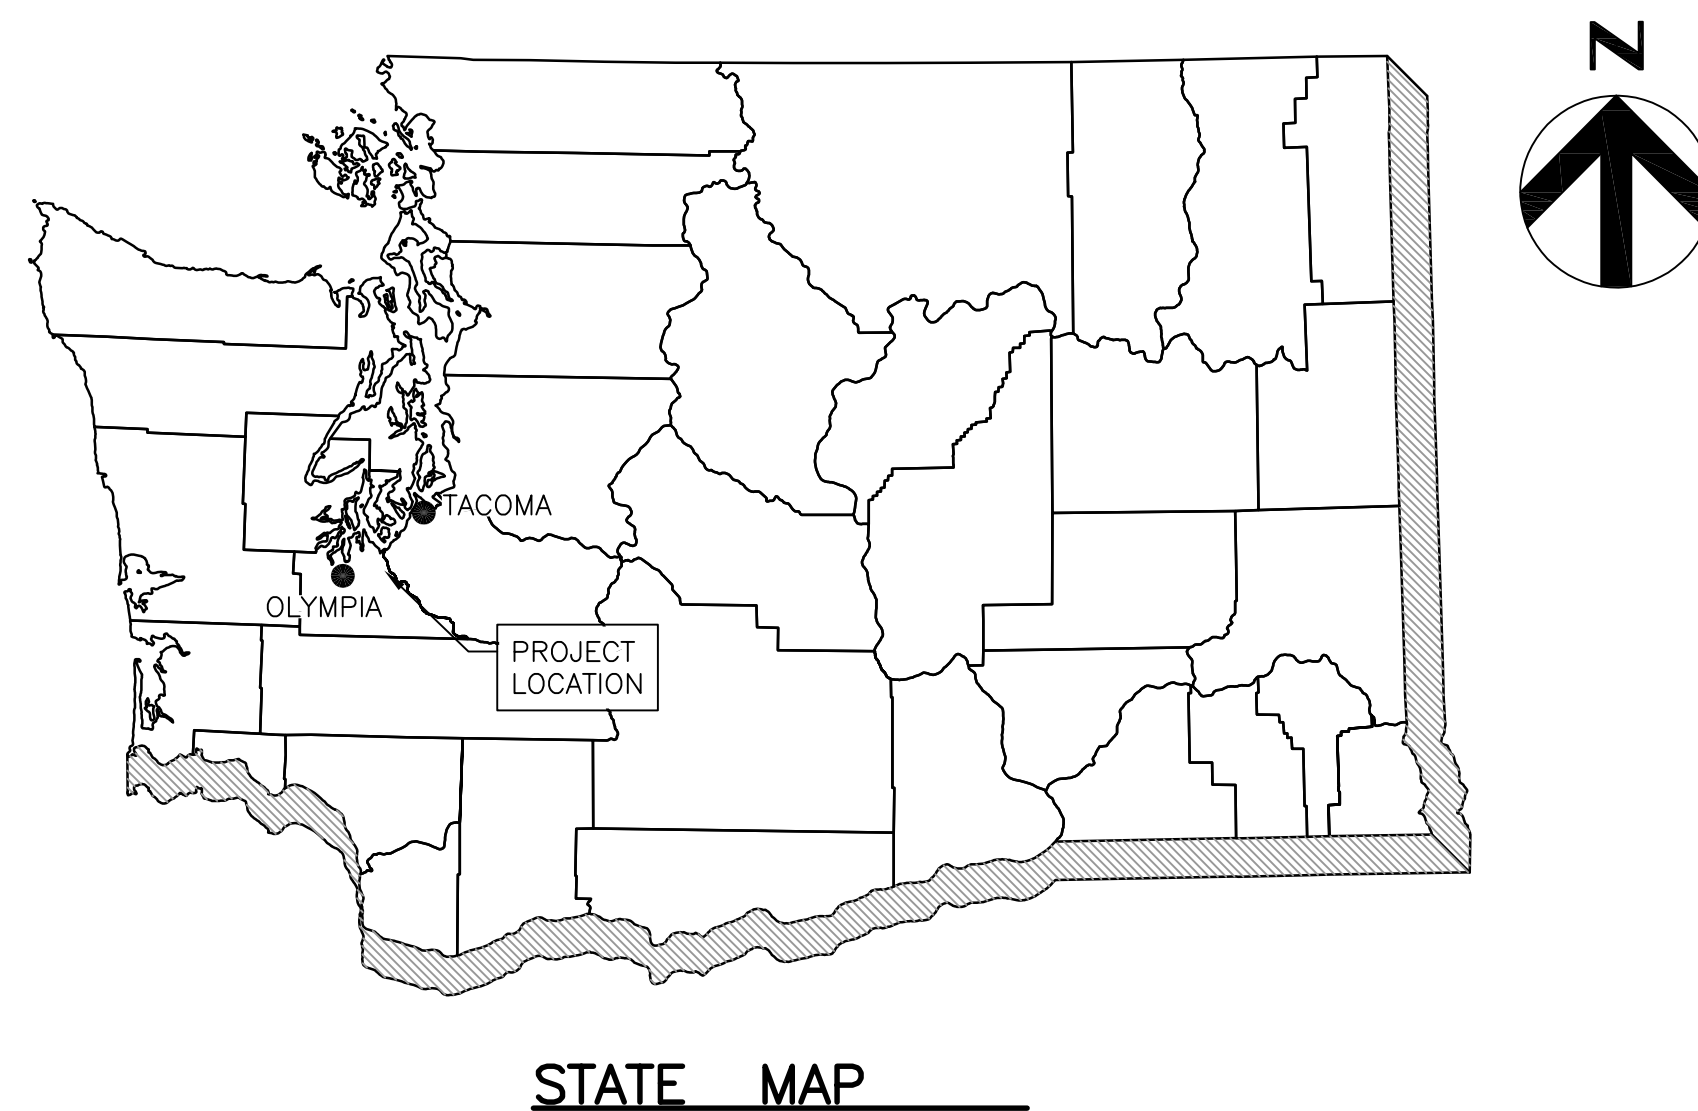


THE GOALS OF THE PROJECT ARE TO INCREASE FISH REARING CAPACITY, BIO-SECURITY, WATER QUALITY, INCREASE WATER RE-USE CAPACITY, AND INCREASE THE NUMBER OF REARING UNITS AVAILABLE TO ADD FLEXIBILITY TO THE SALMON ENHANCEMENT PROGRAM IN ANTICIPATION OF CURRENT AND FUTURE HATCHERY PROGRAMS.



Project No. 10176455
May 18, 2023

GENERAL SYMBOLOGY

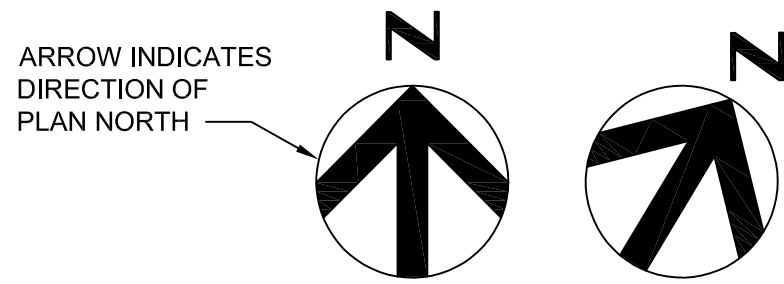


NORTH ARROW


TITLE

SCALE: 1" = 1'-0"


PLAN TITLE

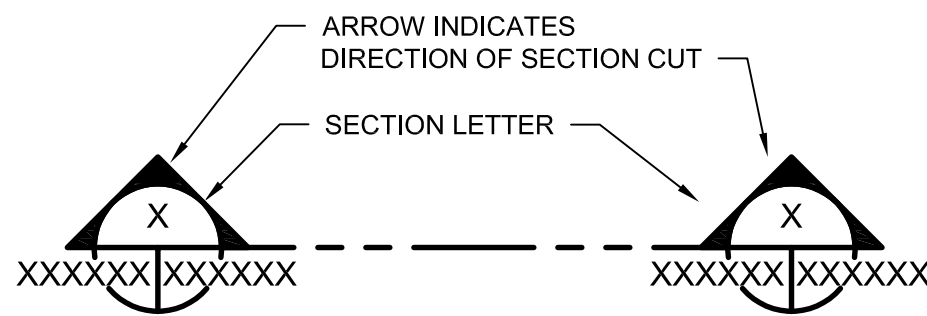


FULL BUILDING SECTION CUT MARKER

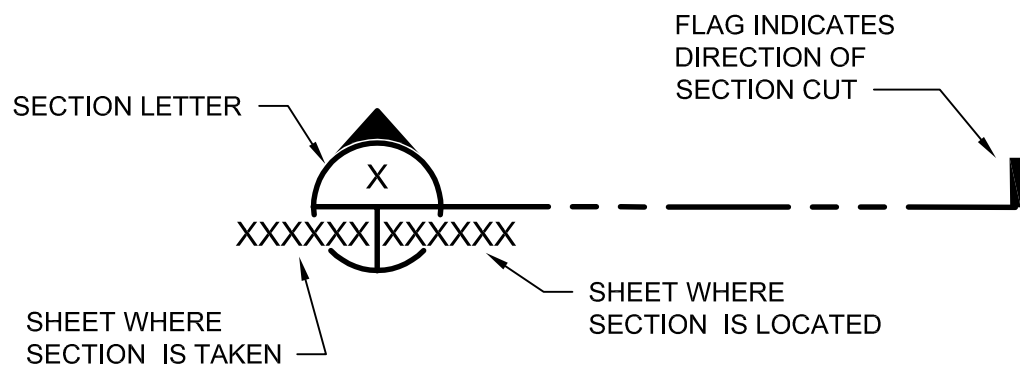


SECTION CUT MARKER

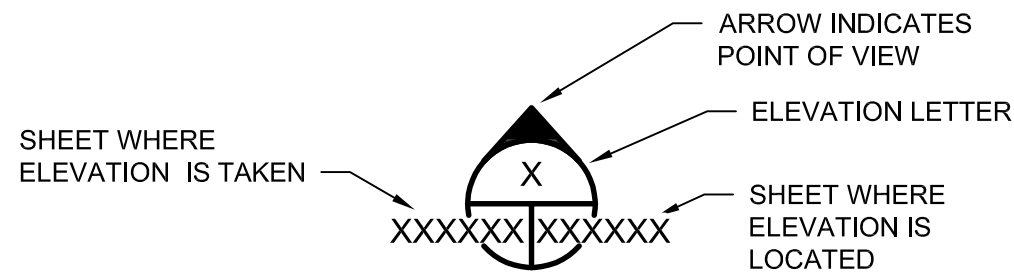

ELEVATION

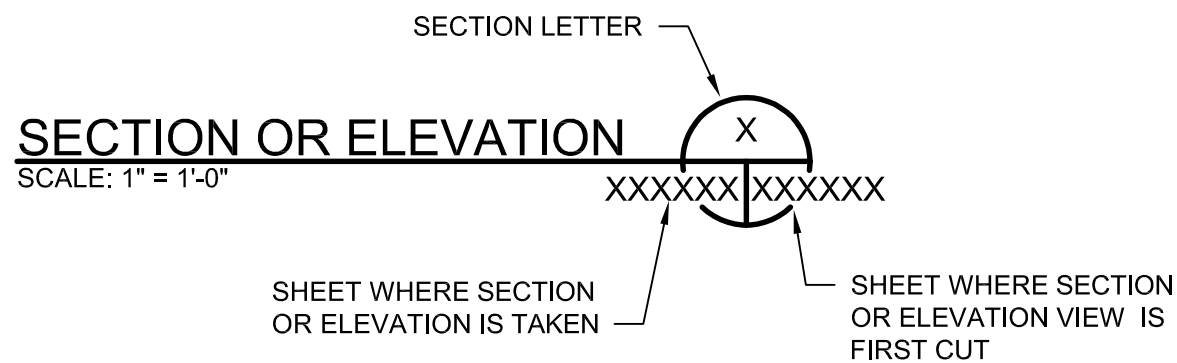

SECTION OR ELEVATION TITLE

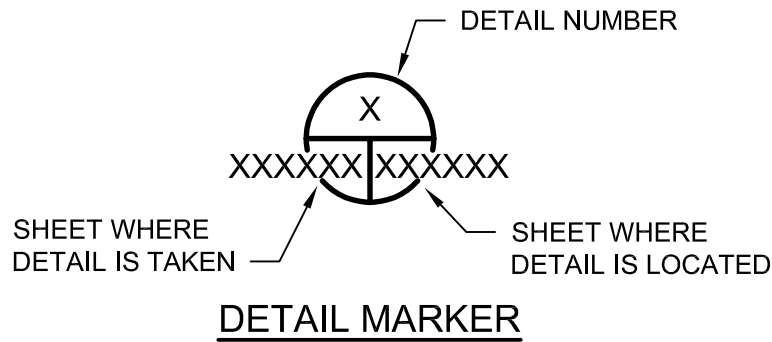

DETAIL MARKER


DETAIL

SCALE: 1" = 1'-0"



DETAIL TITLE

KEY NOTE DESIGNATION

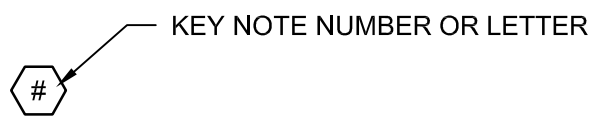

AREA/BUILDING/SECTION DESIGNATION

- 00 GENERAL
- 01 STANDARDS
- 02 DEMOLITION
- 03 UPPER SITE
- 04 LOWER SITE
- 05 EXISTING BUILDINGS (UPPER SITE)
- 06 HATCHERY BUILDING
- 07 POLLUTION ABATEMENT POND (UPPER SITE)
- 08 ASPHALT POND (EXISTING)
- 09 CONTAINER FILTER
- 10 HEADTANK (EXISTING)
- 11 ---
- 12 ---
- 13 ADULT HANDLING BUILDING
- 14 ---
- 15 CIRCULAR TANK BUILDING
- 16 POLLUTION ABATEMENT POND (LOWER SITE)

DISCIPLINE DESIGNATOR & DISCIPLINE ORDER

- G GENERAL
- C CIVIL
- A ARCHITECTURAL
- S STRUCTURAL
- D PROCESS
- M MECHANICAL
- P PLUMBING
- E ELECTRICAL
- L LANDSCAPING

DRAWING TYPE DESIGNATOR

- 0 GENERAL
- 1 PLANS (INCLUDES PLAN AND PROFILES SHEETS)
- 2 ELEVATIONS / ISOMETRICS
- 3 PARTIAL PLANS
- 4 SECTIONS AND DETAILS
- 5 SCHEDULES AND DIAGRAMS

EXAMPLE

ARCHITECTURAL SECTIONS AND DETAILS SHEET

0 5 HATCHERY BUILDING

AREA DESIGNATION

A ARCHITECTURAL DISCIPLINE

DISCIPLINE DESIGNATOR

4 SECTIONS AND DETAILS

DRAWING TYPE

0 1 NUMBER 01

ORDER NUMBER

0 5 A 4 0 1

SAMPLE SHEET NUMBER




ISSUE	DATE	DESCRIPTION

PROJECT MANAGER ERIC ORTON P.E.

DESIGN BY	ACB
DESIGN BY	
CHECKED BY	
DRAWN BY	ACB
PLOT DATE	May 18, 2023
PROJECT NUMBER	10176455




KALAMA CREEK HATCHERY
PHASE 2
NATURAL RESOURCES DEPARTMENT
NISQUALLY INDIAN TRIBE
EDA AWARD NUMBER 07-79-07880

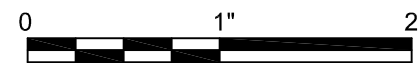

GENERAL
DRAWING SYMBOLOGY

FILENAME 00G003.DWG
SCALE AS NOTED

SHEET
00G003

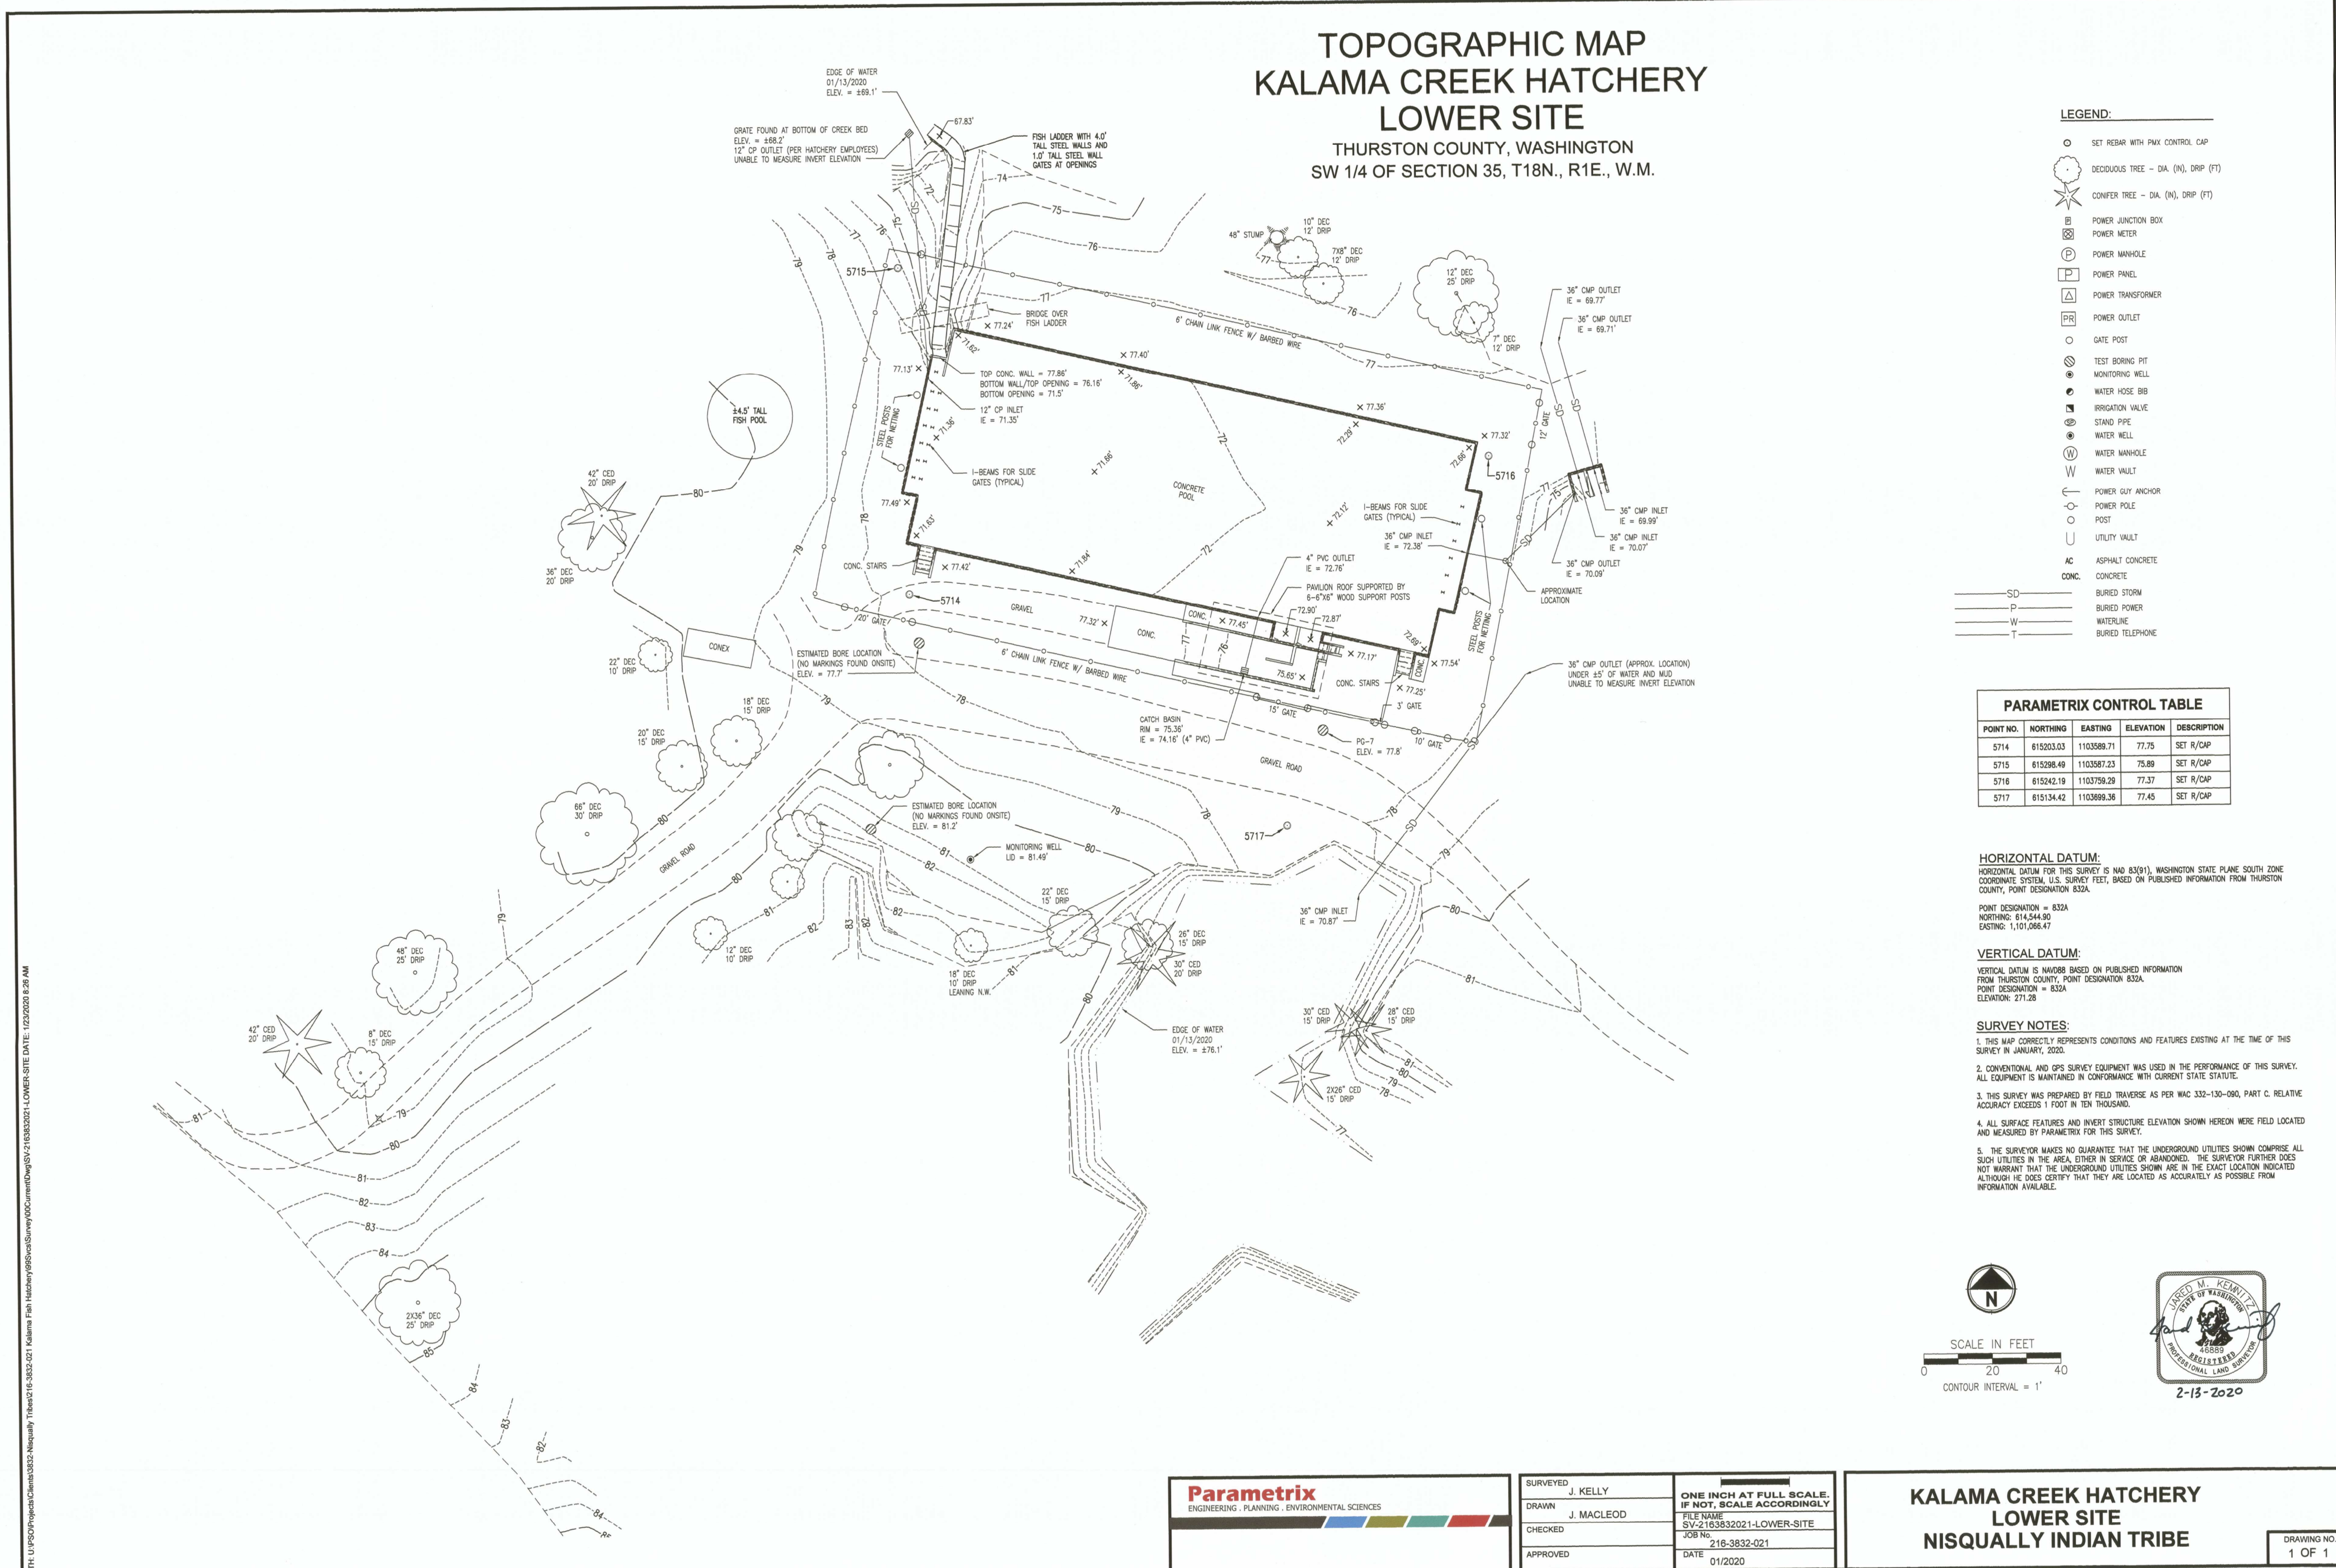

ISSUE	DATE	DESCRIPTION

PROJECT MANAGER	ERIC ORTON, P.E.
DESIGN BY	
DESIGN BY	
CHECKED BY	
DRAWN BY	ACB
PLOT DATE	May 18, 2023
PROJECT NUMBER	10176455



**KALAMA CREEK HATCHERY
PHASE 2**
**NATURAL RESOURCES DEPARTMENT
NISQUALLY INDIAN TRIBE**
EDA AWARD NUMBER 07-79-07880

GENERAL
**EXISTING LOWER SITE
TOPOGRAPHIC SURVEY**
FILENAME 00C102.DWG
SCALE AS NOTED



SHEET
00C102

HEET
01C402

HEET
01C404

THRUST BLOCK NOTES:

BEARING AREA OF CONCRETE THRUST BLOCK BASED ON 200 PSI PRESSURE AND SAFE SOIL BEARING LOAD OF 2,000 PONDS PER SQUARE FOOT.





AREAS MUST BE ADJUSTED FOR OTHER PIPE SIZE, PRESSURES AND SOIL CONDITIONS.

CONCRETE BLOCKING SHALL BE CAST IN PLACE AND HAVE A MINIMUM OF 1/4 SQUARE FOOT BEARING AGAINST THE FITTING.

BLOCK SHALL BEAR AGAINST FITTINGS ONLY AND SHALL BE CLEAR OF JOINTS TO PERMIT TAKING UP OR DISMANTLING OF JOINT.


CONTRACTOR SHALL INSTALL ADEQUATE BLOCKING TO WITHSTAND FULL TEST PRESSURE AS WELL AS TO CONTINUOUSLY WITHSTAND AND OPERATION PRESSURE UNDER ALL CONDITIONS OF SERVICE.

THRUST BLOCK - TABLE						
BEARING AREA AGAINST UNDISTURBED SOIL						
SQUARE FEET						
PIPE SIZE	A (ft.) ²	B (ft.) ²	C (ft.) ²	D (ft.) ²	E (ft.) ²	X (ft.) ²
4"	3	1	1	1	1	NONE
6"	4	4	2	1	1	NONE
8"	7	6	4	2	1	4
10"	11	10	6	3	2	6
12"	16	14	9	5	3	9
14"	22	19	12	6	3	12
16"	29	25	16	8	4	16
18"	36	31	20	10	5	20
20"	45	39	24	13	6	24
22"	54	47	29	15	8	29
24"	64	56	35	18	9	35
28"	87	76	48	24	12	48
30"	101	87	55	28	14	55
36"	145	125	78	40	20	78
42"	197	171	107	55	27	107
48"	257	223	140	71	36	140

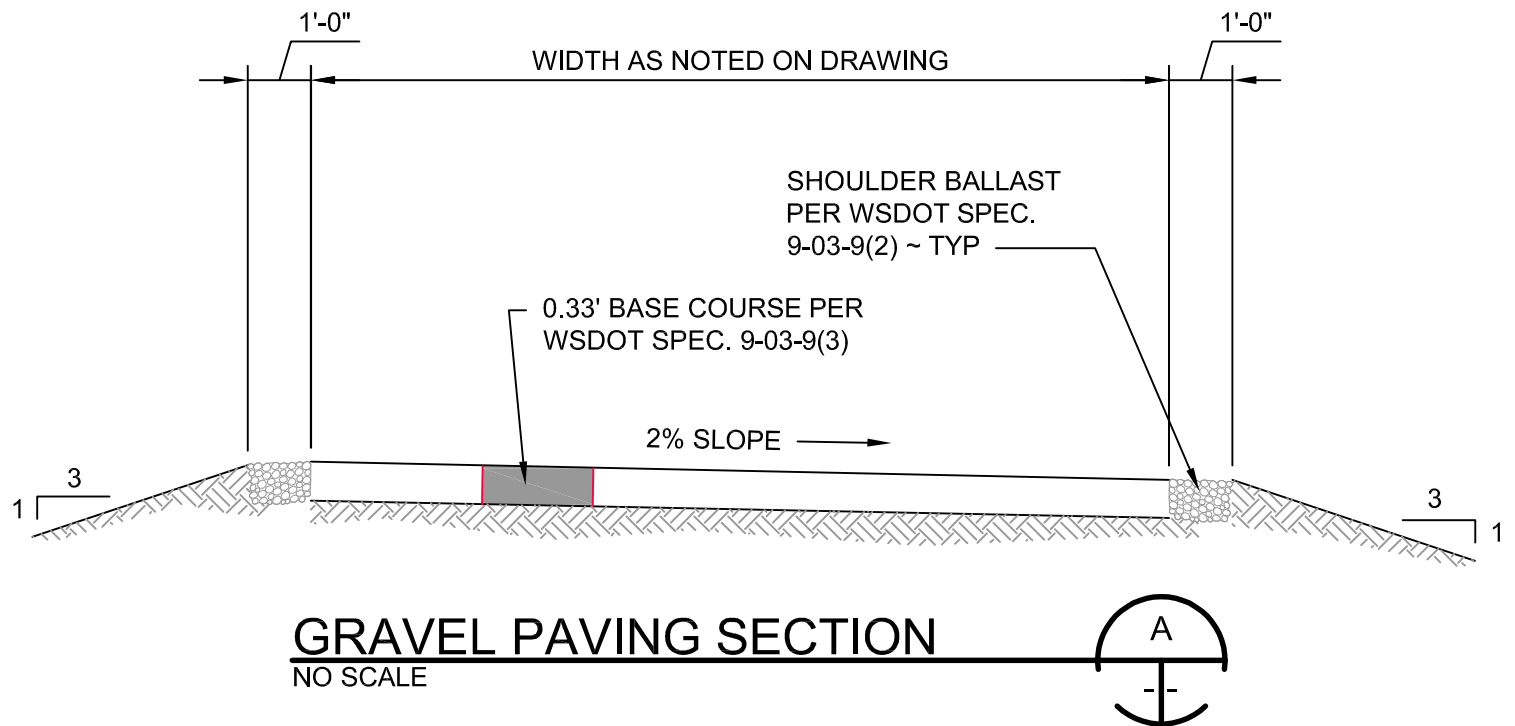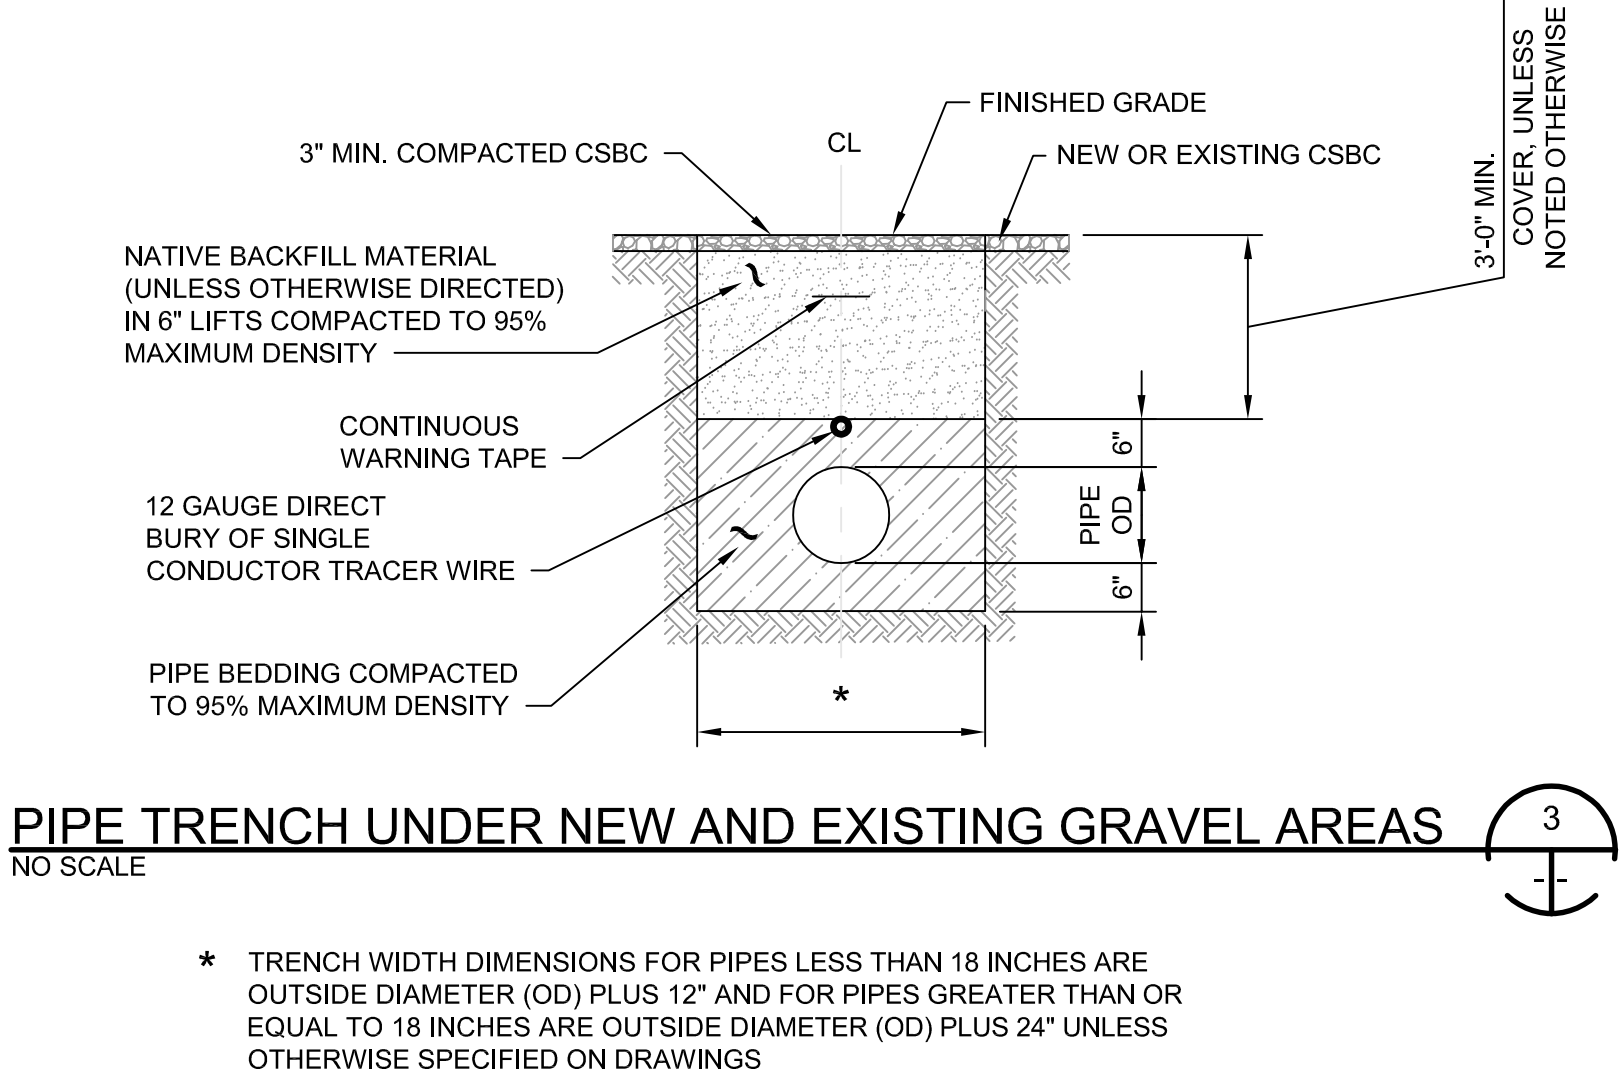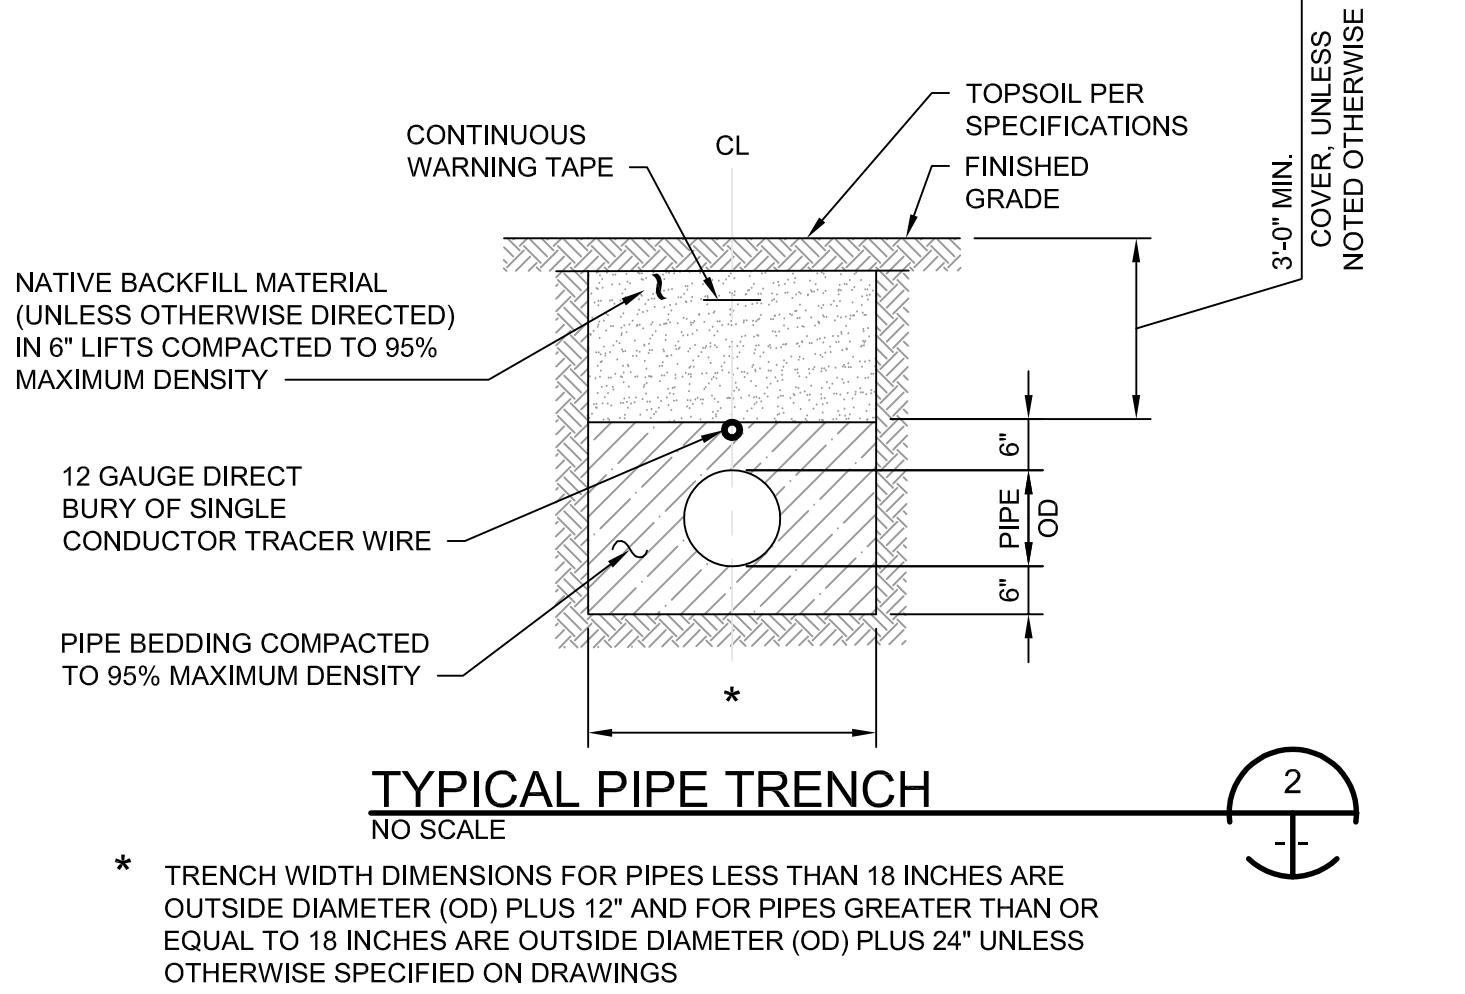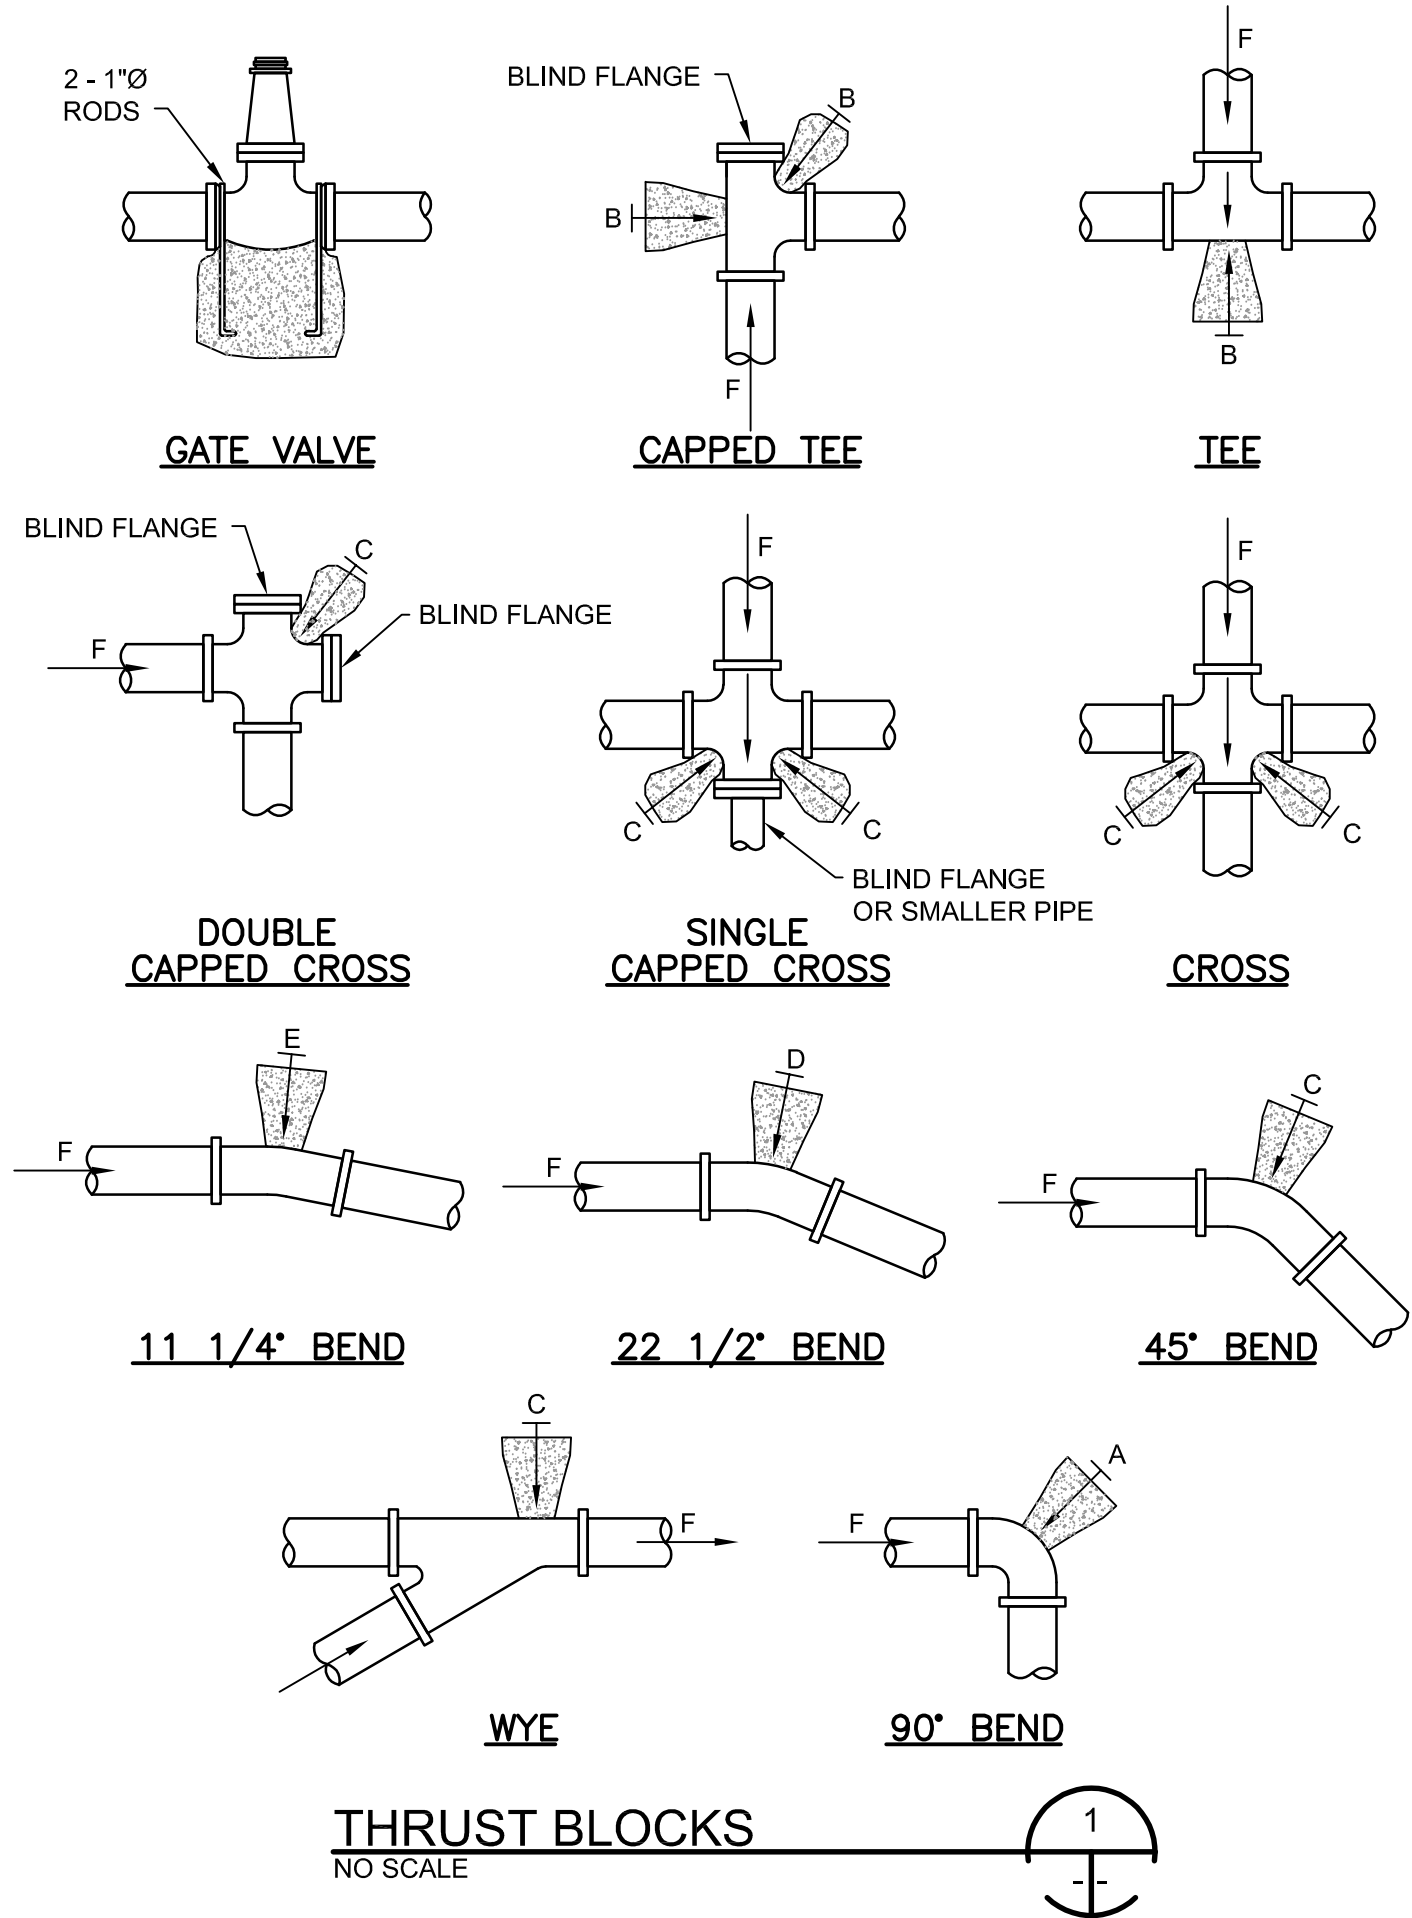


ISSUE	DATE	DESCRIPTION

PROJECT MANAGER	ERIC ORTON P.E.
DESIGN BY	JDN
DESIGN BY	
CHECKED BY	
DRAWN BY	JLC
PLOT DATE	May 18, 2023
PROJECT NUMBER	10176455

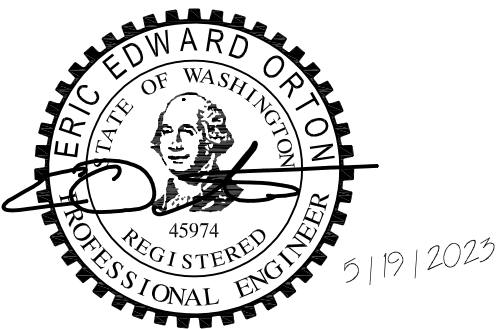




KALAMA CREEK HATCHERY
PHASE 2
NATURAL RESOURCES DEPARTMENT
NISQUALLY INDIAN TRIBE
EDA AWARD NUMBER 07-79-07880

STANDARDS
DETAILS

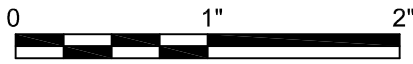

FILENAME	01C405.DWG
SCALE	AS NOTED

SHEET
01C405

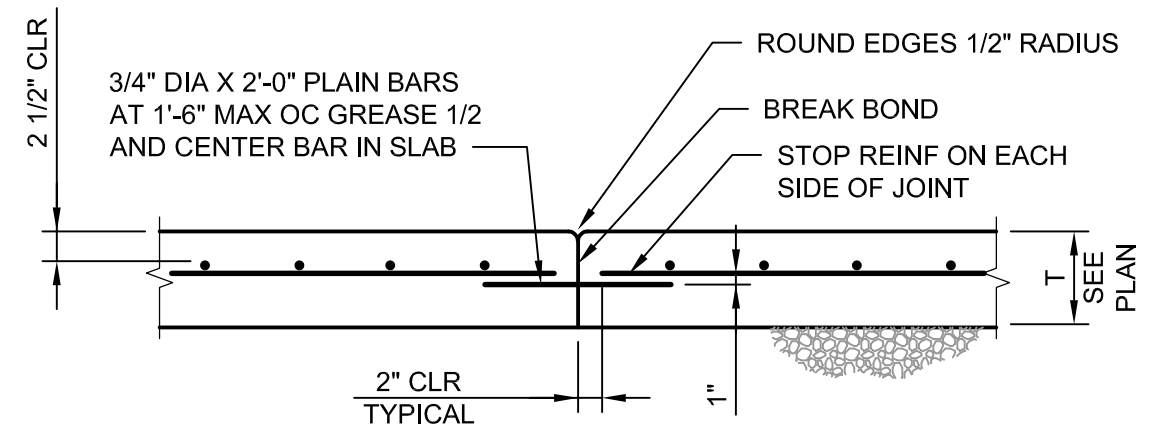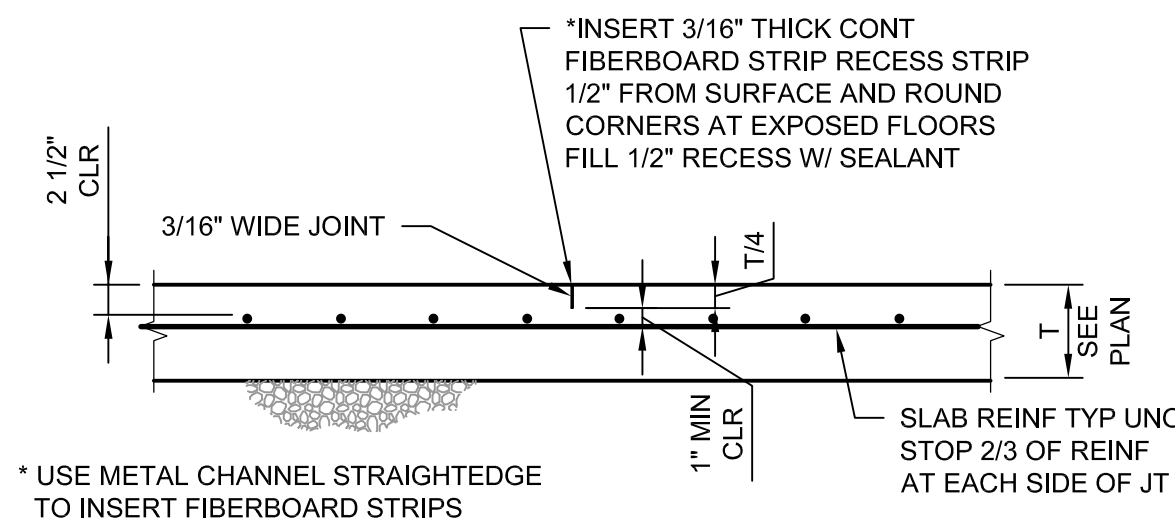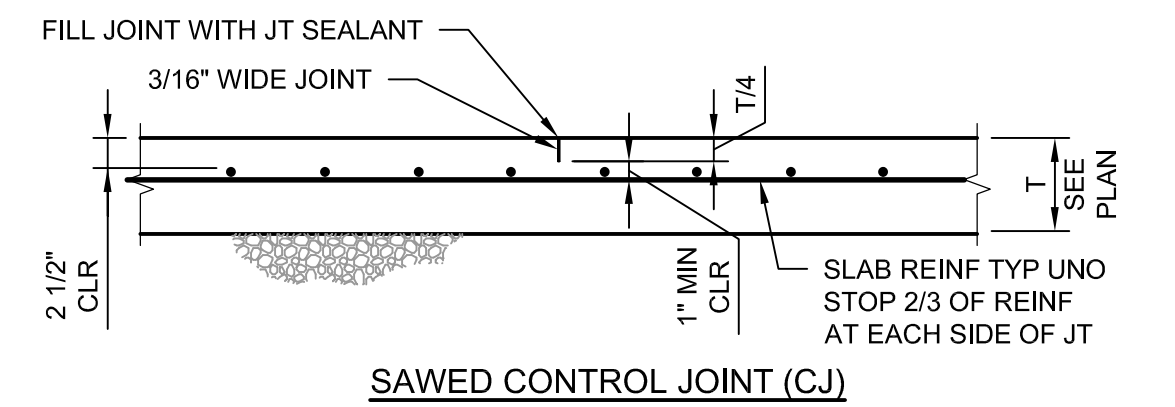


NOTES:

- ANY ONE OF THE "CJ" DETAILS ABOVE MAY BE USED AT LOCATIONS INDICATED ON DRAWINGS AS "CJ," AT CONTRACTOR'S OPTION.
- WHERE "DSJ" IS INDICATED ON PLAN, THE "DSJ" SHALL BE USED.

SLAB ON GRADE JOINT

NOT TO SCALE

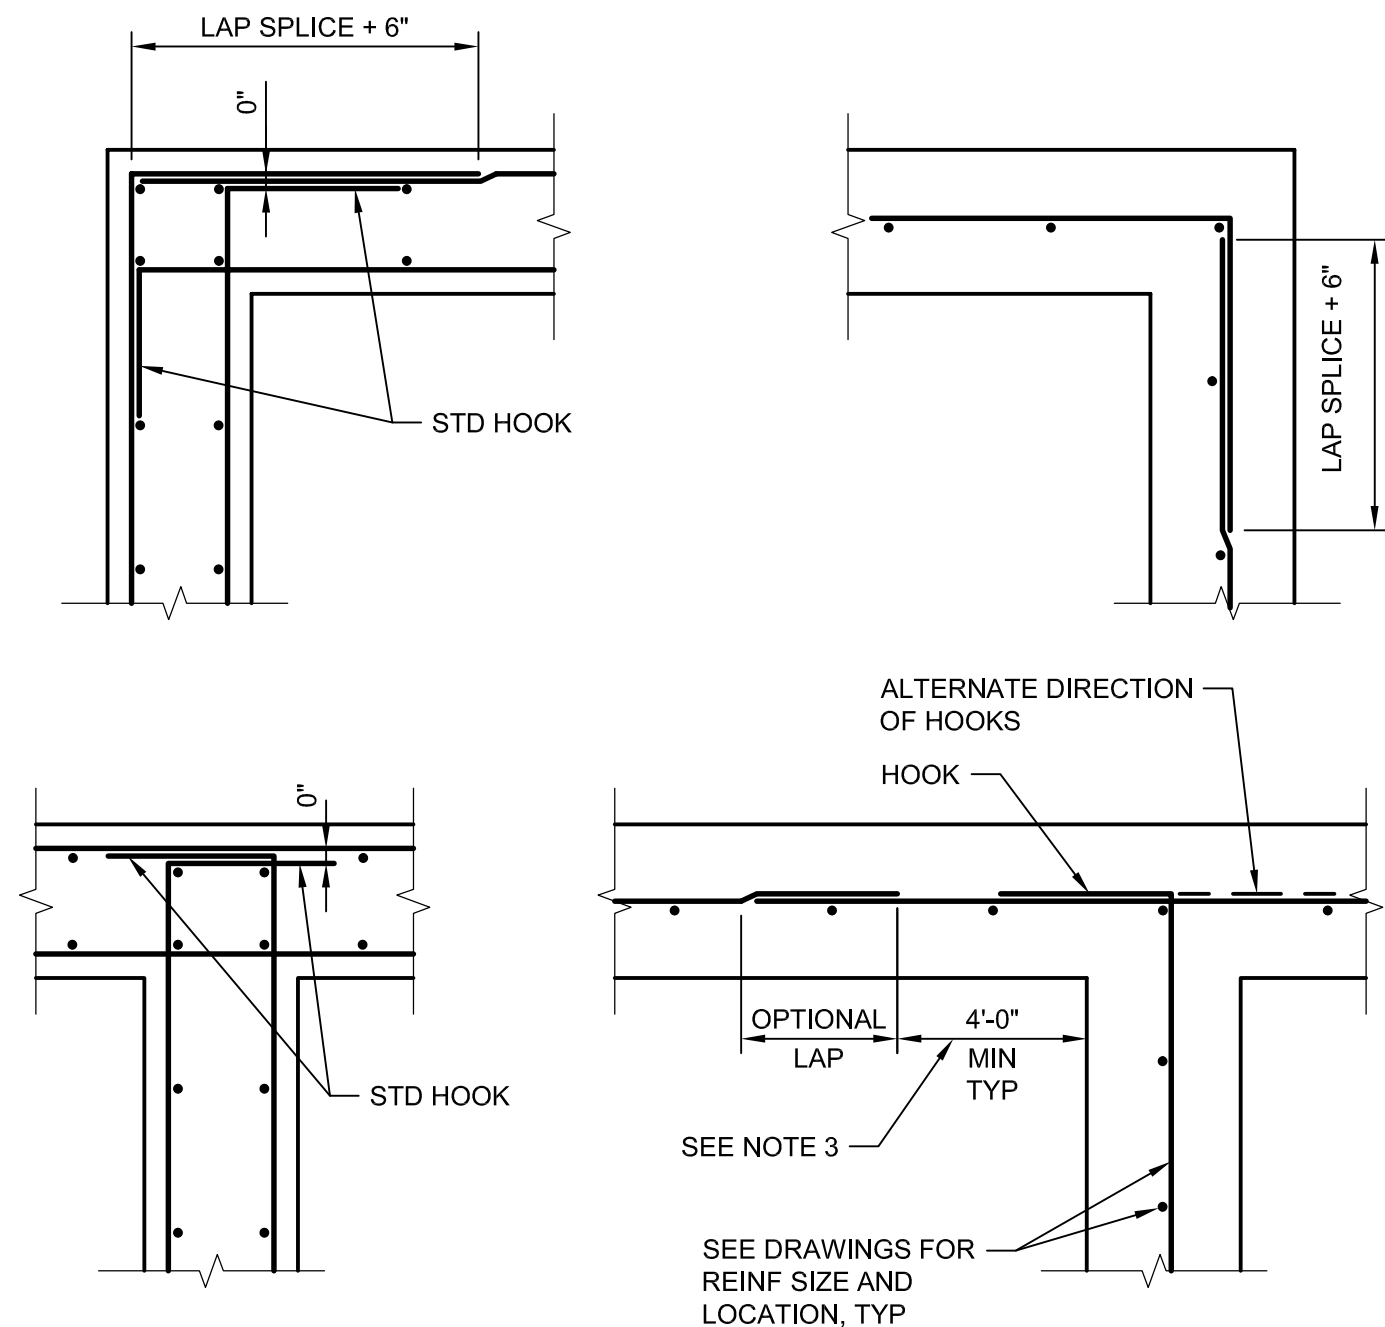

NOTES:


- ALL HOOKS SHALL BE STD 90 DEGREE HOOKS.
- SEE DRAWINGS FOR ADDITIONAL HORIZONTAL BARS. STAGGER BETWEEN TYPICAL REINF SPACING, EXTEND TO 1/5 OF DISTANCE TO NEAREST ADJACENT WALL IN EACH DIRECTION, UNO.
- OPTIONAL LAP LOCATION. APPLIES TO BOTH DOUBLE AND SINGLE LAYER CONDITIONS TYP.

WALL REINFORCEMENT AT CORNERS AND INTERSECTIONS

NOT TO SCALE


BAR SIZE	HL	HW	TL	D	f'c=4.0 OR 4.5 KSI
#3	6"	3"	3"	2 1/4"	6"
#4	8"	4"	4 1/2"	3"	7"
#5	10"	5"	5"	3 3/4"	9"
#6	1'-0"	6"	6"	4 1/2"	10"
#7	1'-2"	7"	7"	5 1/4"	12"
#8	1'-4"	8"	8"	6"	14"
#9	1'-7"	11 3/4"	10 1/2"	9 1/2"	15"
#10	1'-10"	1'-1 1/4"	11 1/2"	10 3/4"	17"
#11	2'-0"	1'-2 3/4"	1'-1"	12"	19"

* COMPLYING WITH MINIMUM COVER REQUIREMENTS OF ACI 318, 12.5.3. OTHERWISE Ldh MUST BE RE-CALCULATED.

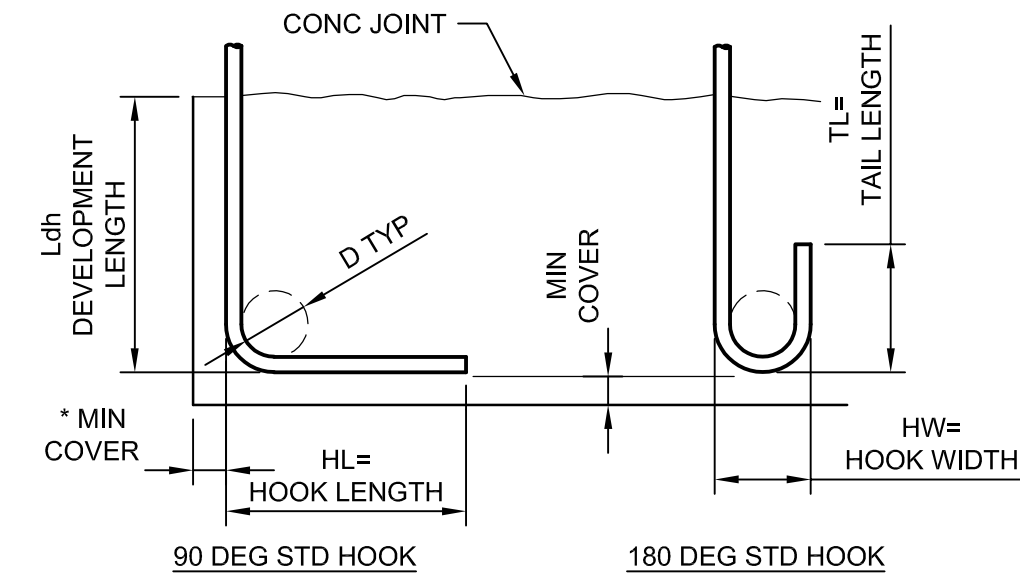


REINFORCING HOOK SCHEDULE

NOT TO SCALE

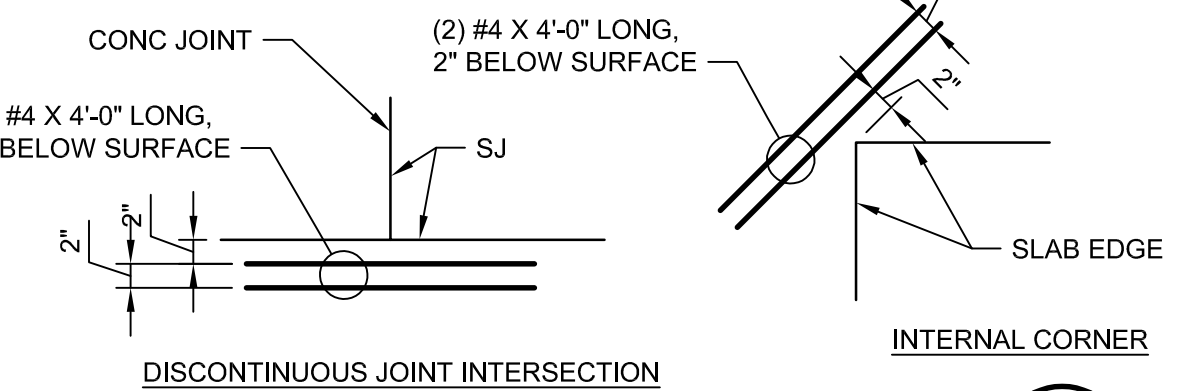

ADDITIONAL SLAB REINFORCING

NOT TO SCALE

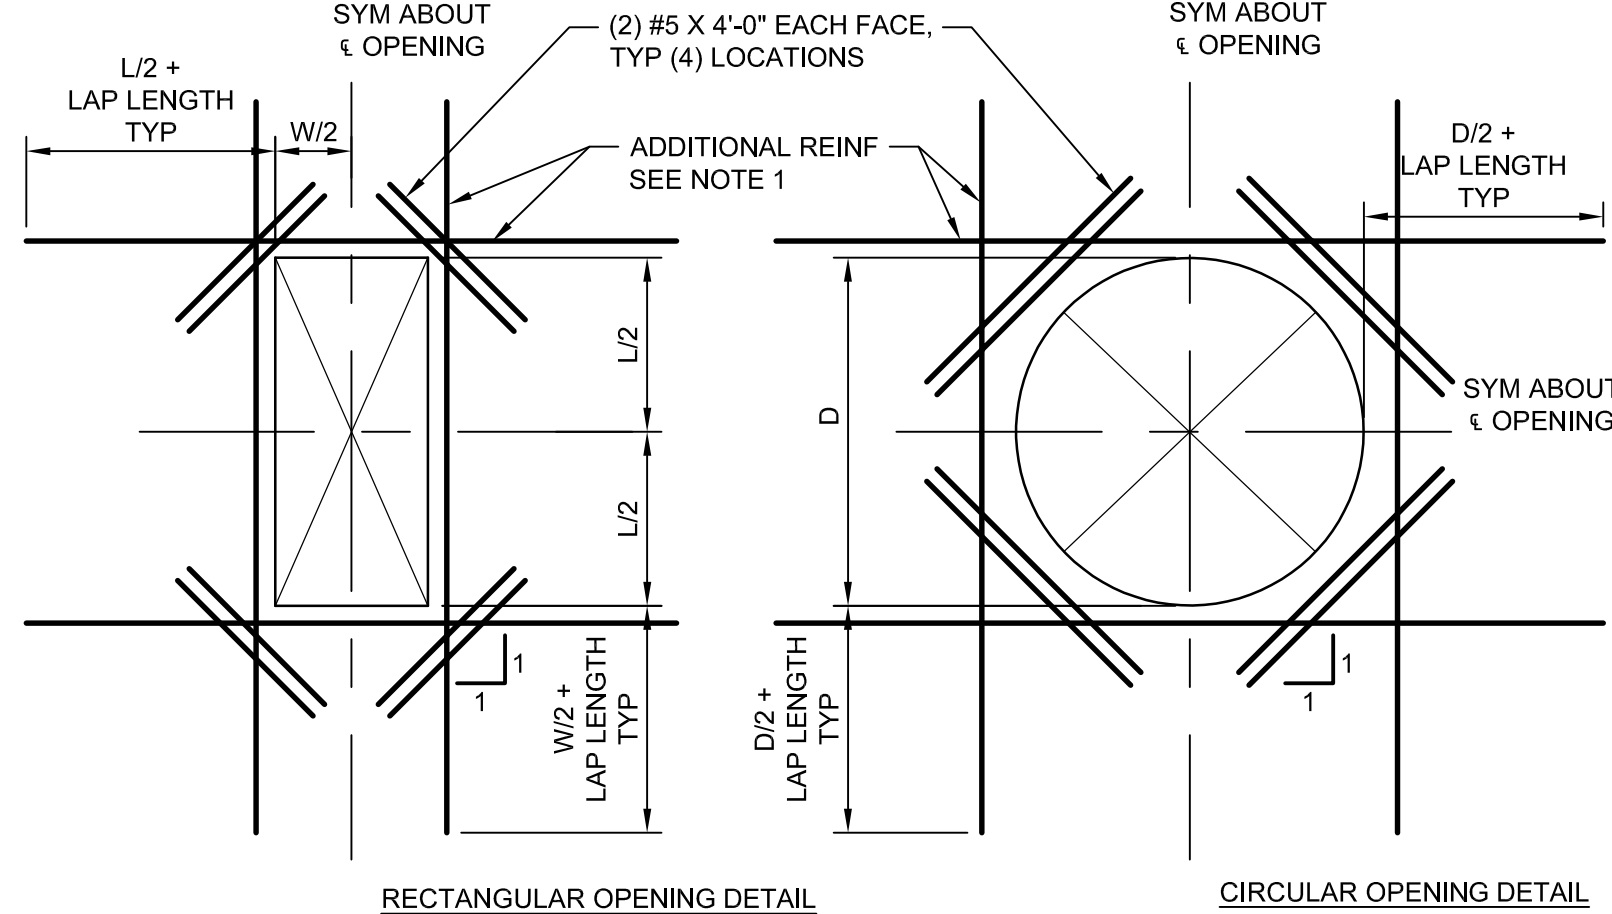


NOTES:

- PROVIDE ADDITIONAL REINFORCING THE SAME SIZE AS DISCONTINUOUS REINFORCEMENT AT OPENING. QUANTITY OF REINFORCING IN EACH DIRECTION SHALL BE EQUAL TO OR ONE GREATER THAN THE NUMBER OF DISCONTINUOUS BARS. PLACE 1/2 OF ADDITIONAL REINFORCING BARS EACH SIDE OF OPENING. PLACE ADDITIONAL REINFORCEMENT AT 3" OC (TYPICAL BOTH DIRECTIONS AND ALL LAYERS OF REINFORCEMENT). START FIRST BAR 2" CLEAR TO OPENING.
- EXTEND ADDITIONAL REINFORCING BEYOND EDGE OF OPENING AS SHOWN ABOVE. ADDITIONAL BARS MAY TERMINATE AT THE END OF THE WALL WITH A STANDARD HOOK WHERE THE LENGTH OF THE WALL WILL NOT PERMIT BARS TO EXTEND AS SHOWN ABOVE.
- TYPICAL WALL OR SLAB REINFORCING NOT SHOWN FOR CLARITY. TERMINATE TYPICAL REINFORCING 2" CLEAR TO OPENING.
- OPENINGS 12" OR LESS IN SLABS AND OPENINGS 18" OR LESS IN WALLS, NO EXTRA REBARS ARE REQUIRED UNLESS SHOWN OTHERWISE. TYPICAL REINFORCING SHALL BE RESPACED (NOT CUT) TO ALLOW FOR OPENINGS TO BE MADE.
- UNLESS SHOWN OTHERWISE ON DRAWINGS, PROVIDE EXTRA REINFORCING AROUND OPENINGS AS SHOWN AND INDICATED ABOVE.
- PROVIDE ADDITIONAL DOWELS PER NOTE 1 ABOVE FOR ALL OPENINGS NEAR THE FLOOR SLAB, BASE SLAB, OR CORNERS.


EXTRA REINFORCING AT CORNERS

NOT TO SCALE

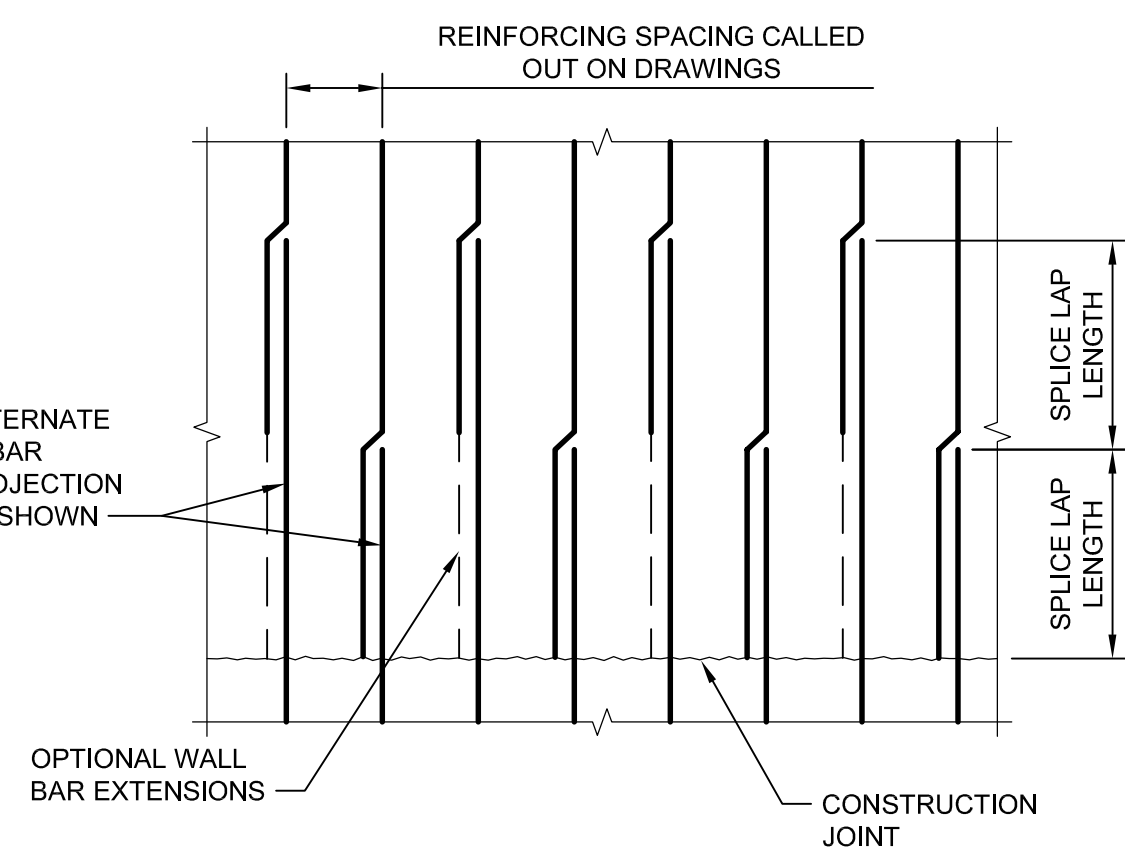

STAGGERED REINFORCING AT CONSTRUCTION JOINT

NOT TO SCALE

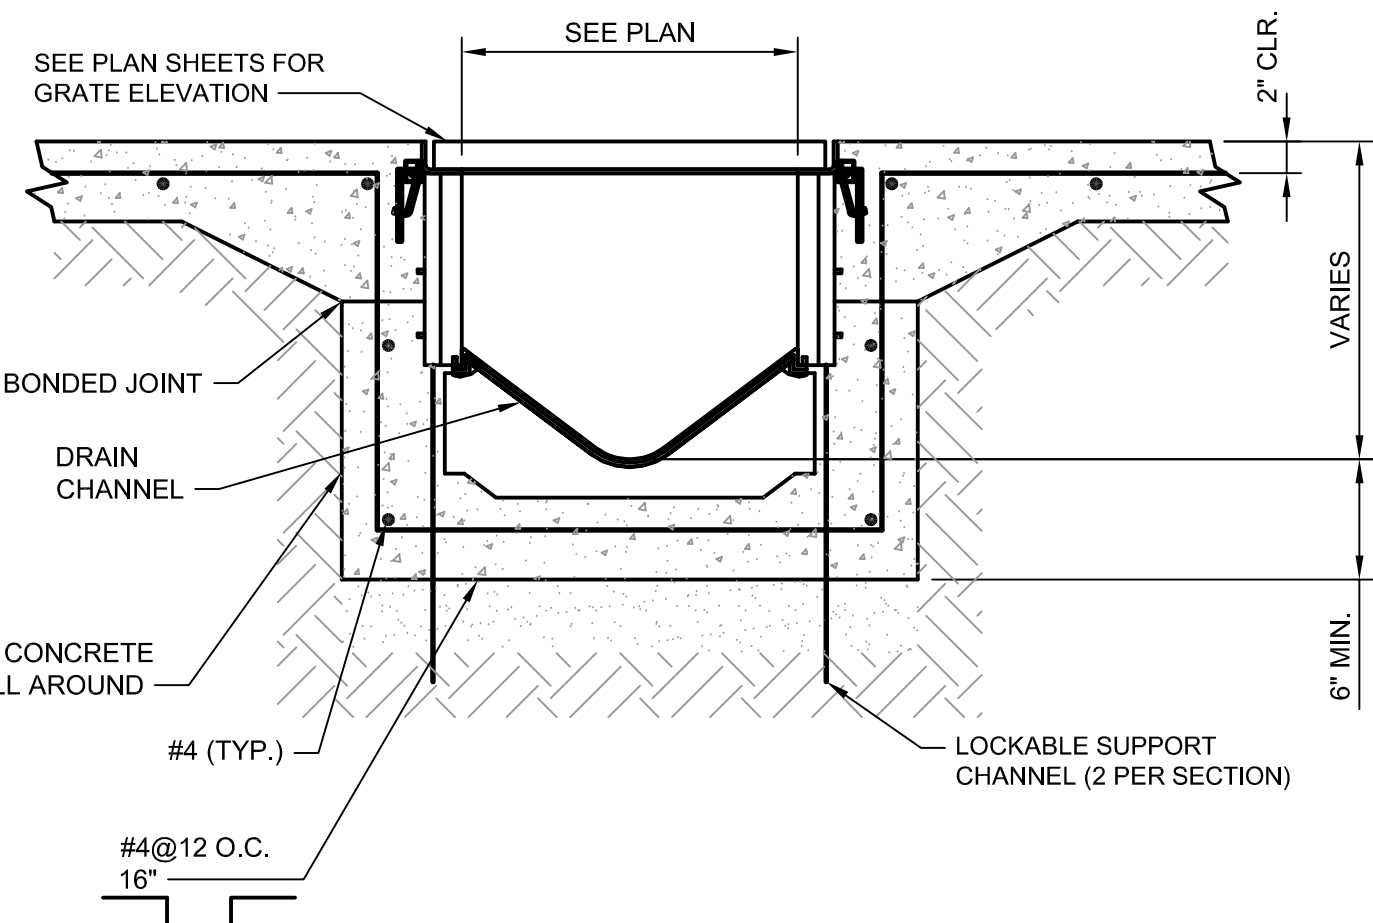

TYPICAL TRENCH DRAIN

NOT TO SCALE

LAP SPLICE AND EMBEDMENT LENGTHS		
f'c = 4.0 ksi fy = 60 ksi		
f'c = 4.5 ksi		
BAR	BARS SPACED GREATER THAN 4"	BARS SPACED LESS THAN OR EQUAL TO 4"
#3	14"	20"
#4	19"	32"
#5	29"	46"
#6	39"	62"
#7	55"	87"
#8	69"	107"
#9	76"	116"
#10	97"	140"
#11	120"	146"

NOTES:

- PROVIDE MINIMUM LAP SPLICE LENGTHS AND EMBEDMENTS PER TABLE UNLESS NOTED OTHERWISE. EMBEDMENT LENGTH EQUALS THE LAP SPLICE LENGTH UNLESS OTHERWISE NOTED.
- BAR SPACING AT LAP SPLICE IS THE MINIMUM CLEAR DISTANCE BETWEEN LAPPED BARS PLUS ONE BAR DIAMETER.
- ALL SPLICES TO BE CONTACT SPLICES AND WIRED TOGETHER UNLESS OTHERWISE APPROVED BY ENGINEER.

CONCRETE REINFORCING LAP AND EMBEDMENT SCHEDULE

NOT TO SCALE

4
-01S4013
-01S4018
-01S4019
-01S401

ISSUE	DATE	DESCRIPTION

PROJECT MANAGER ERIC ORTON P.E.

DESIGN BY JLH


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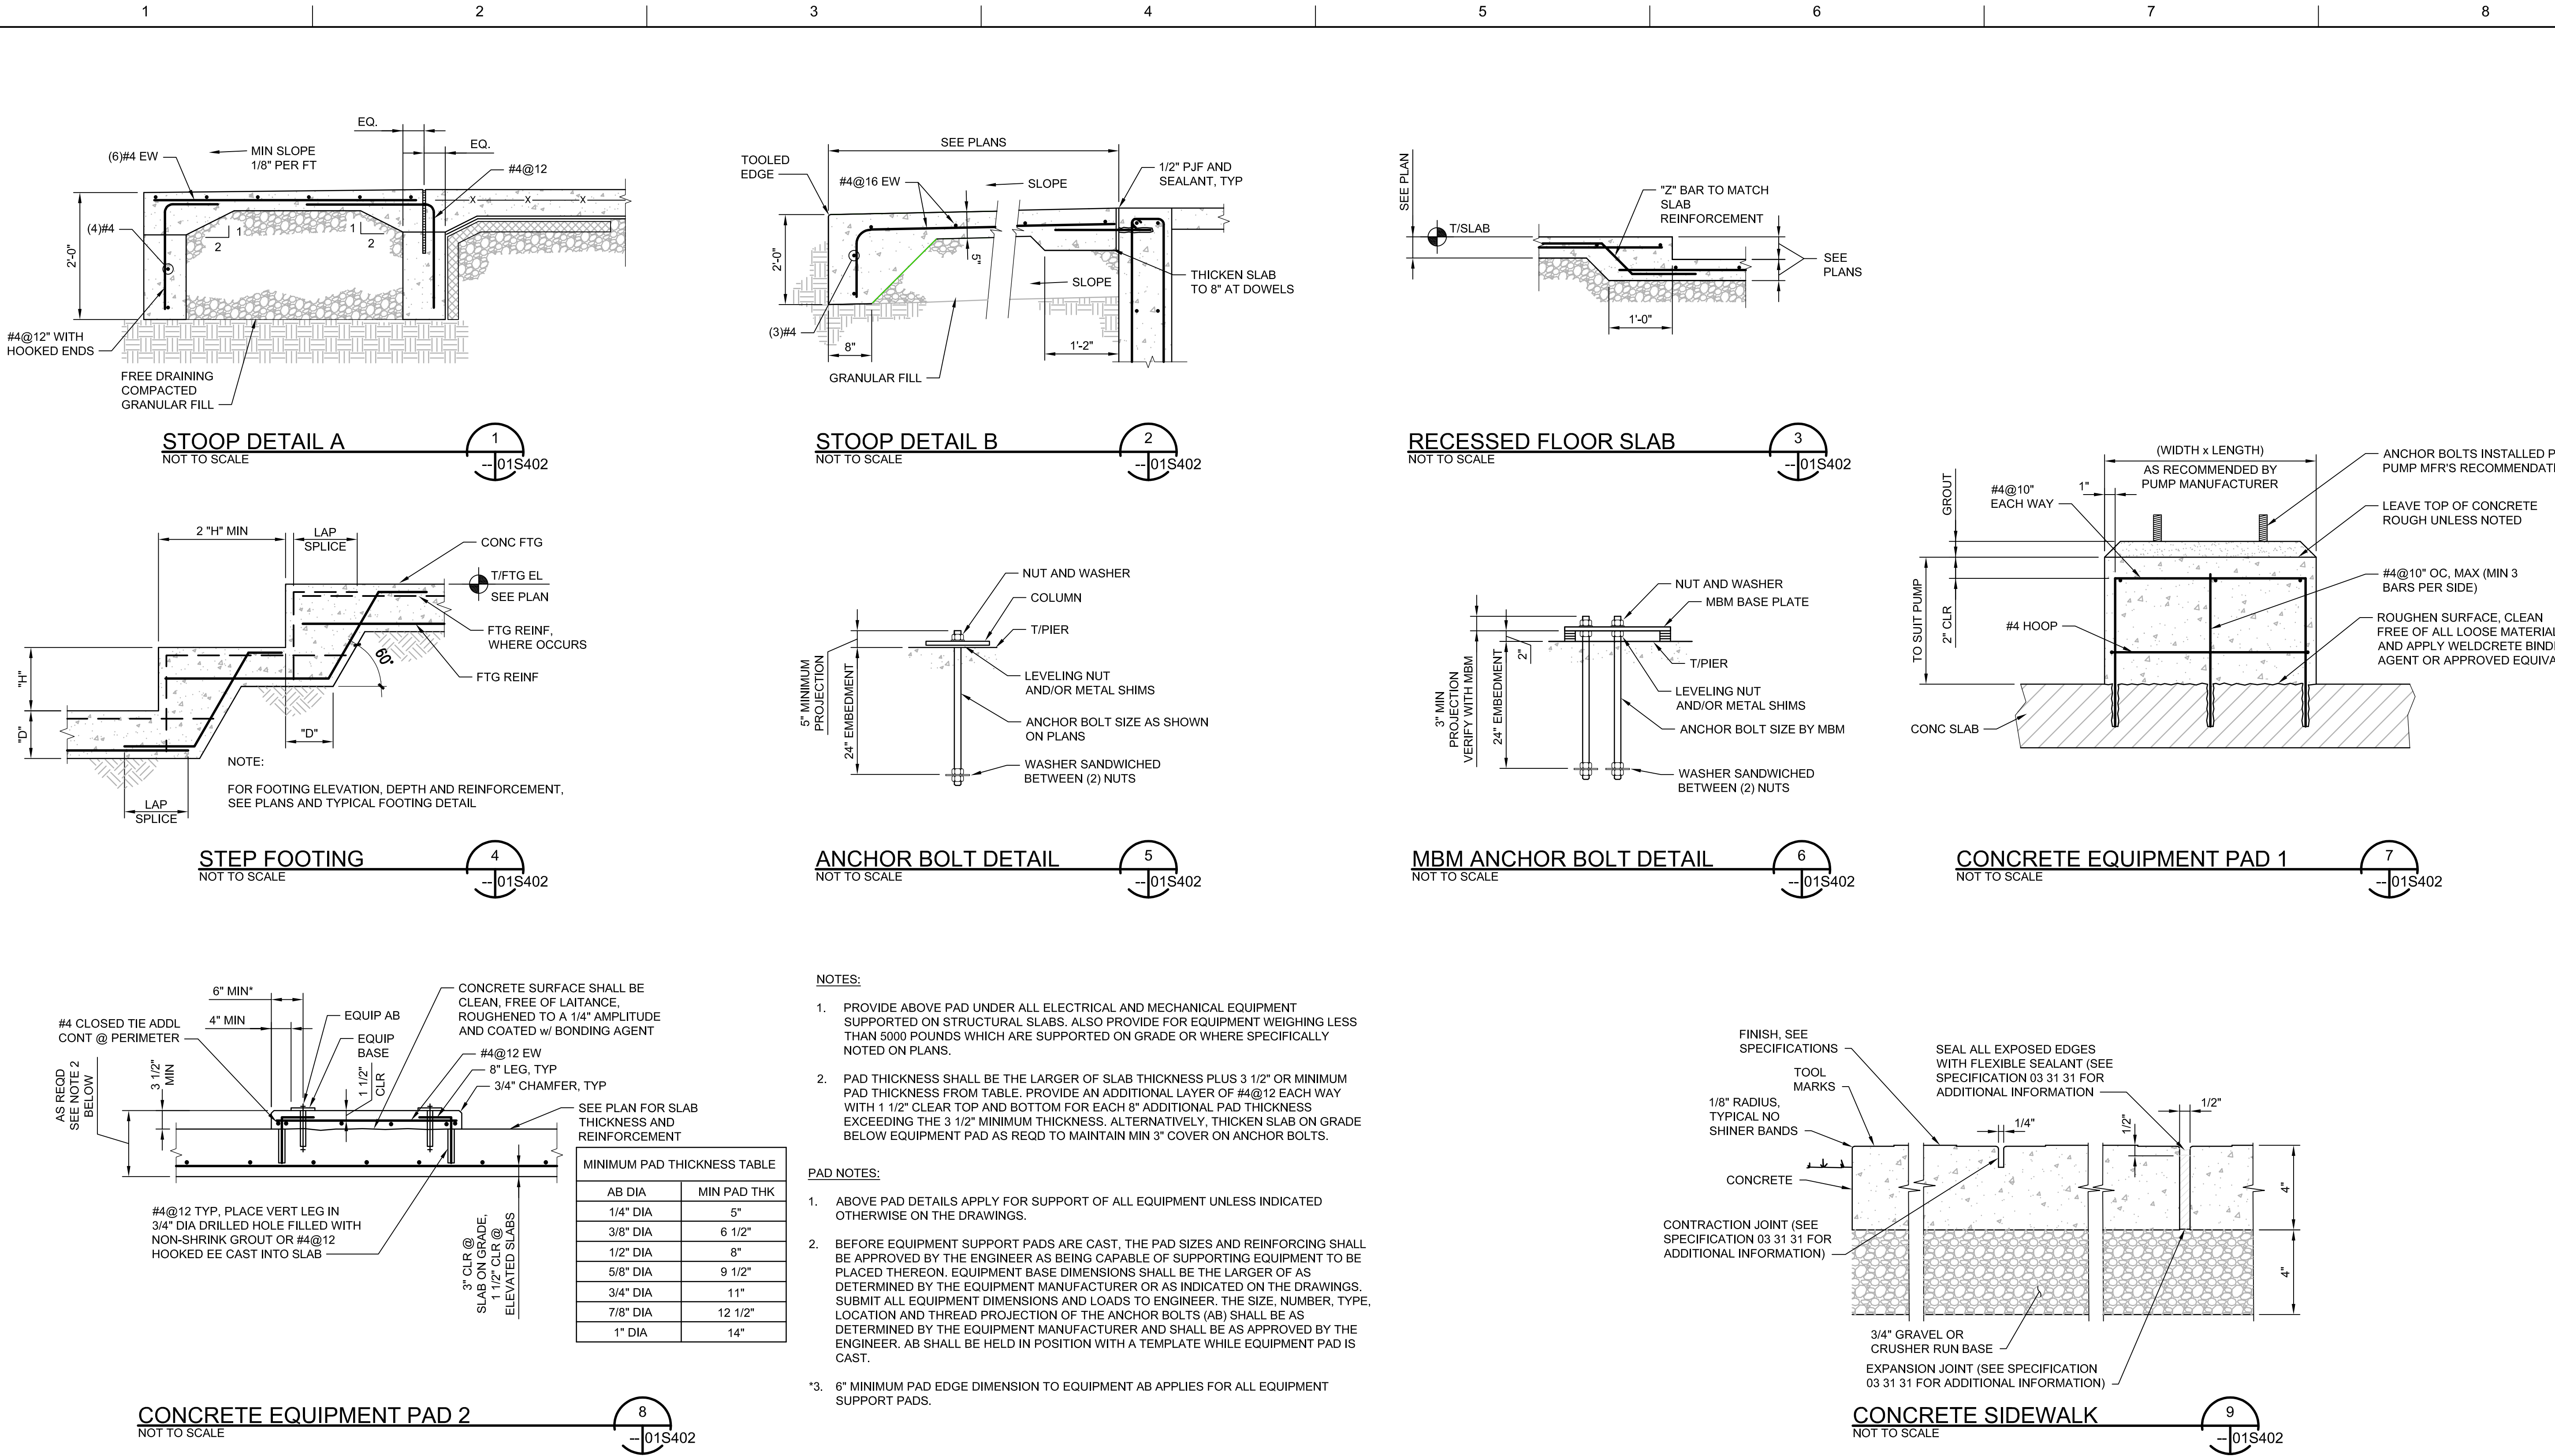
CHECKED BY

DRAWN BY ACB

PLOT DATE May 18, 2023

PROJECT NUMBER 10176455

KALAMA CREEK HATCHERY
PHASE 2NATURAL RESOURCES DEPARTMENT
NISQUALLY INDIAN TRIBE
EDA AWARD NUMBER 07-79-07880STANDARDS
STRUCTURAL
DETAILS 1FILENAME 01S401.DWG
SCALE AS NOTEDSHEET
01S401

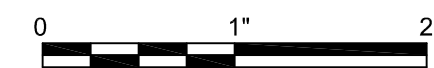

ISSUE	DATE	DESCRIPTION

PROJECT MANAGER ERIC ORTON P.E.	
DESIGN BY	JLH
DESIGN BY	
CHECKED BY	
DRAWN BY	JLC
PLOT DATE	May 18, 2023
PROJECT NUMBER	10176455



5-19-2023







**KALAMA CREEK HATCHERY
PHASE 2**
**NATURAL RESOURCES DEPARTMENT
NISQUALLY INDIAN TRIBE**
EDA AWARD NUMBER 07-79-07880

**STANDARDS
STRUCTURAL
DETAILS 2**



FILENAME 01S402.DWG
SCALE AS NOTED

SHEET
01S402

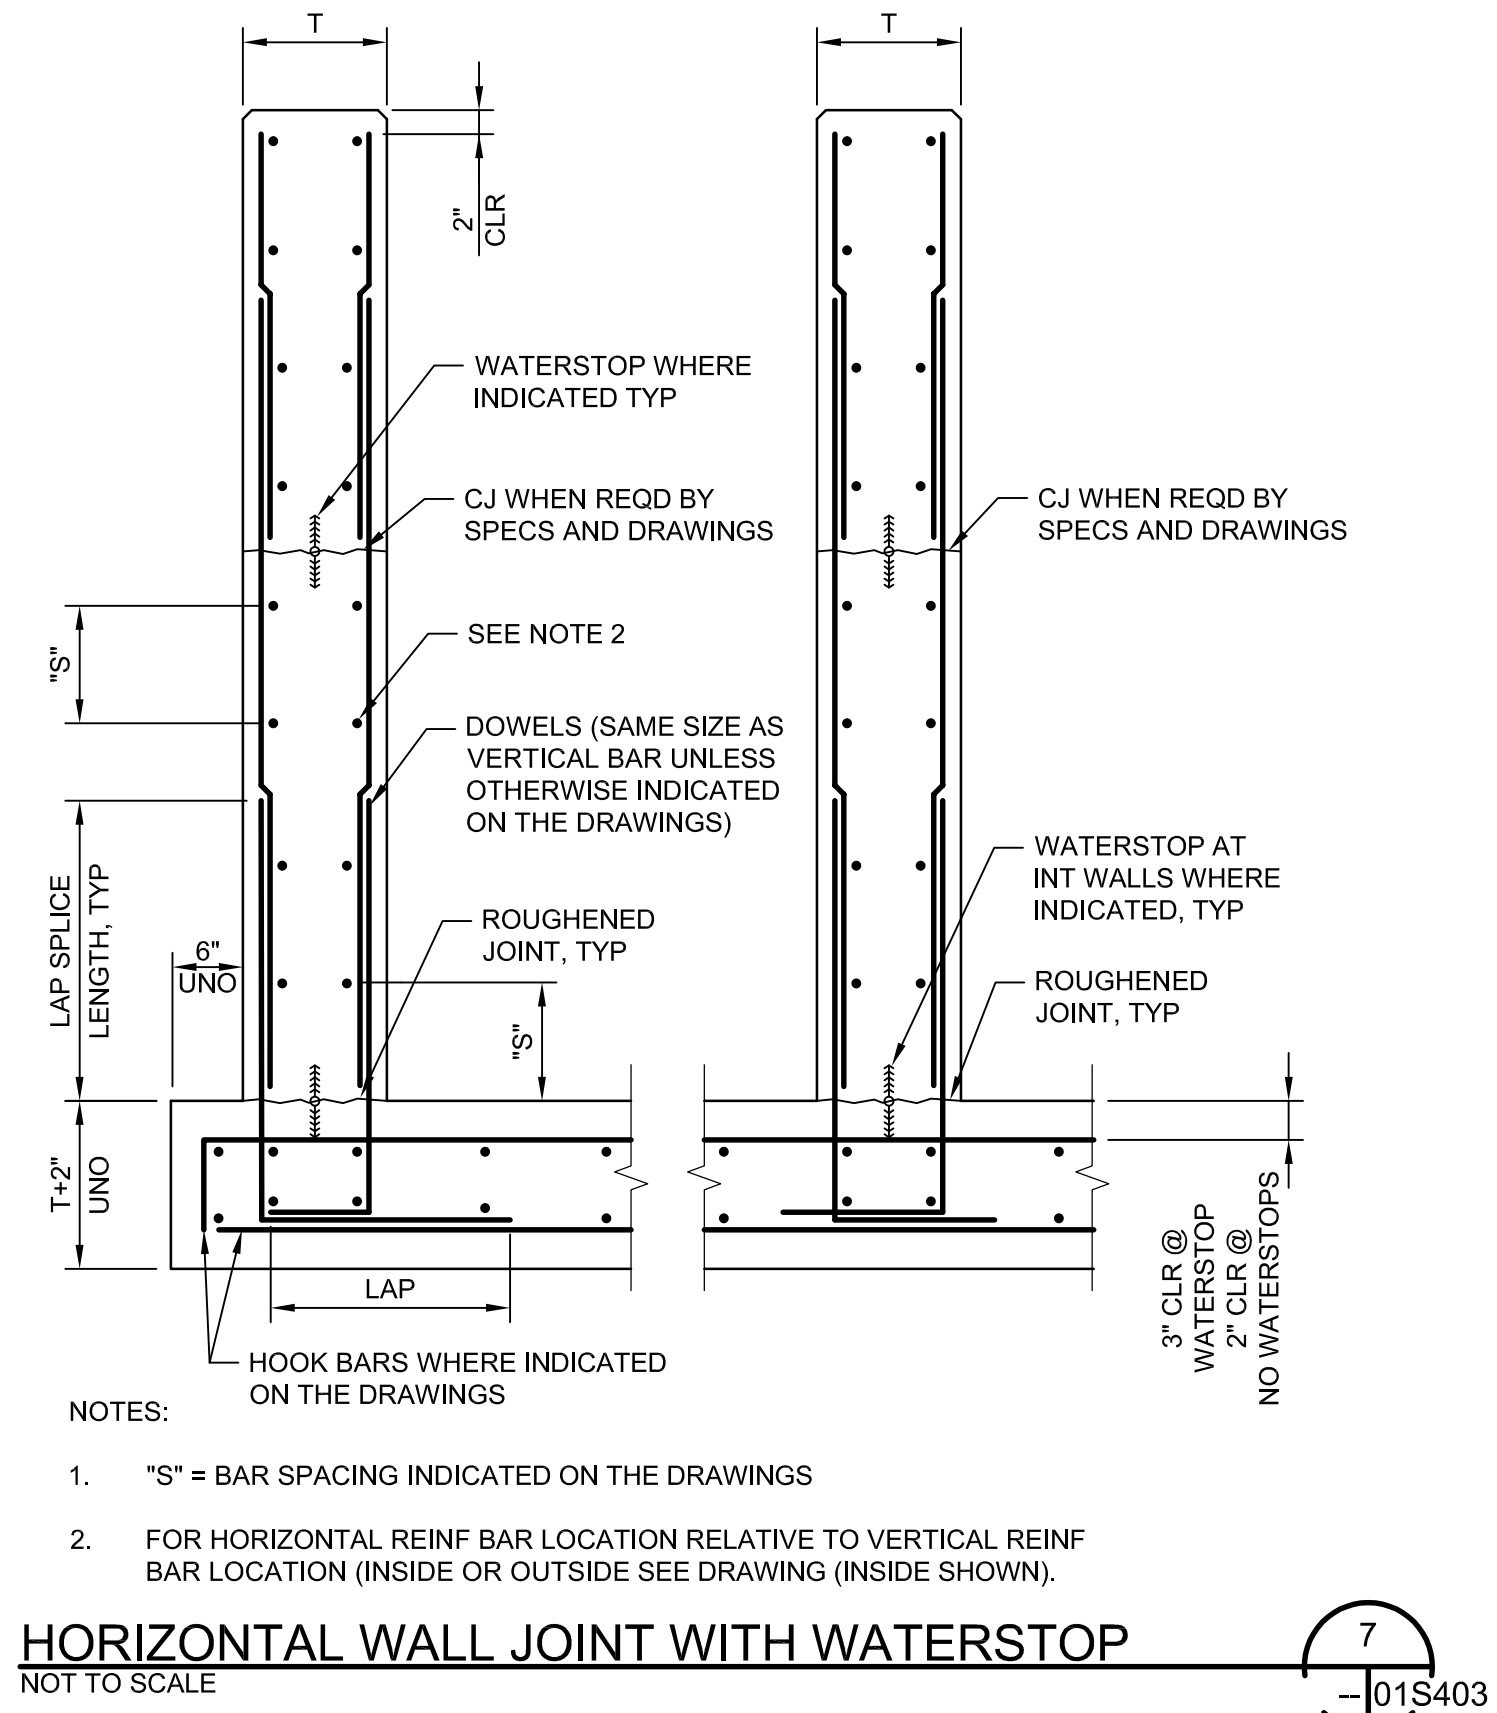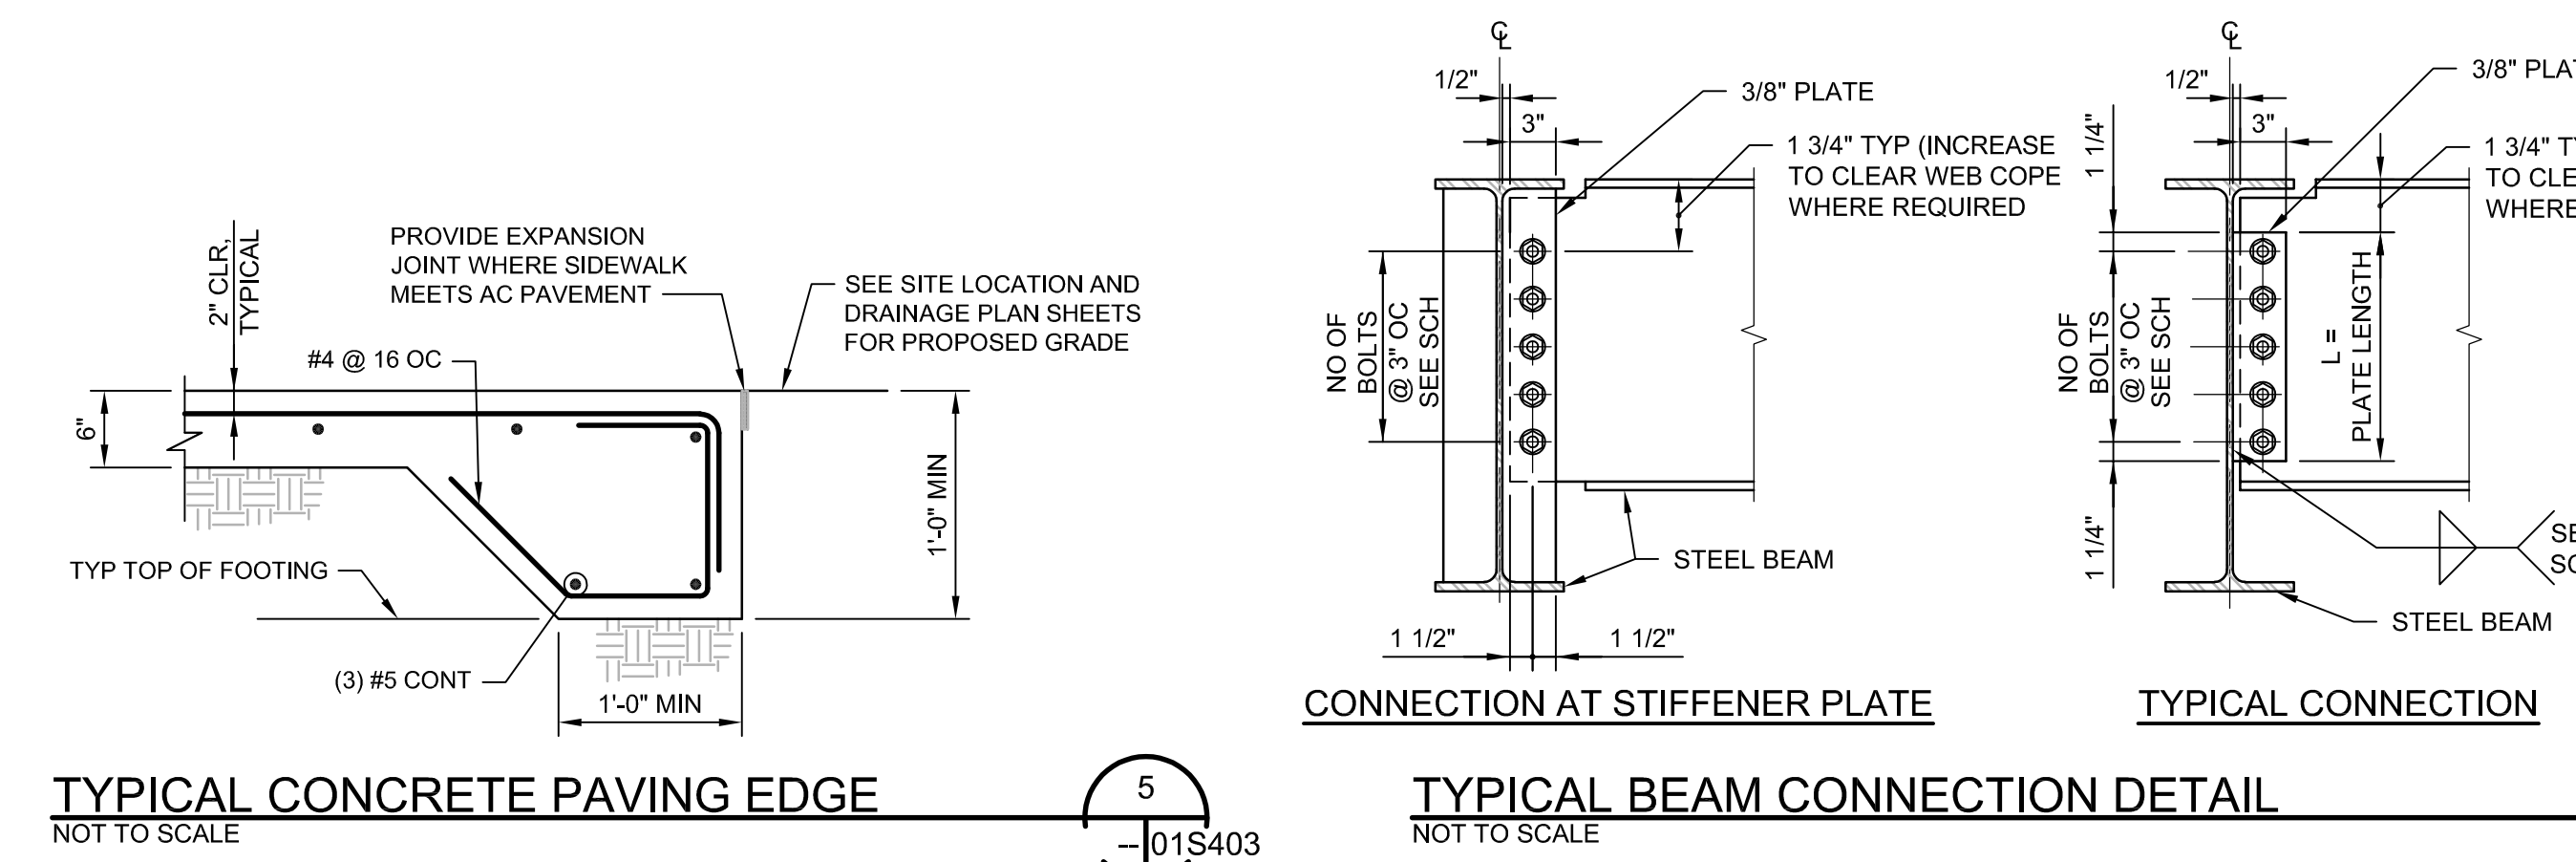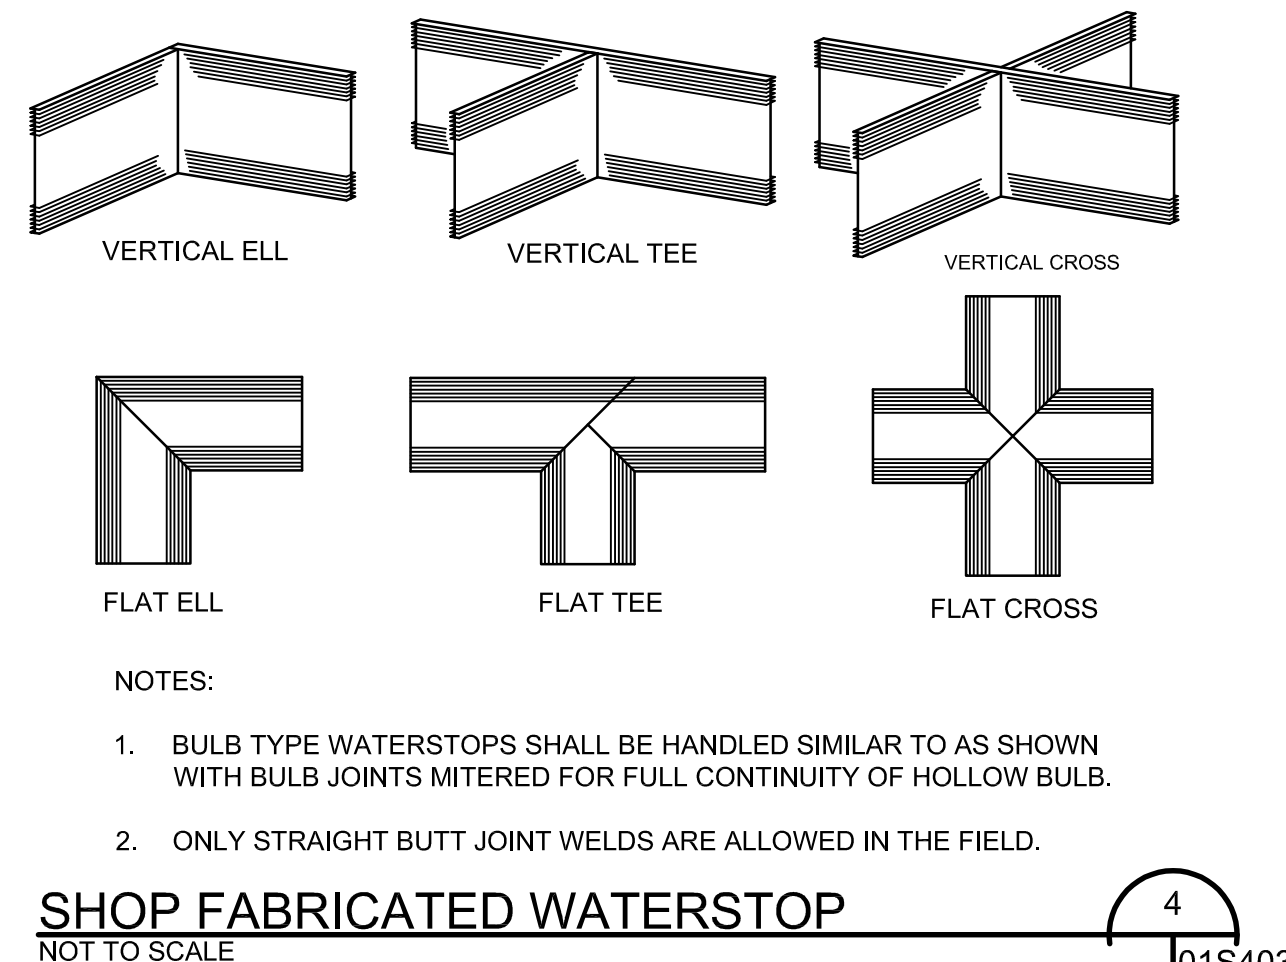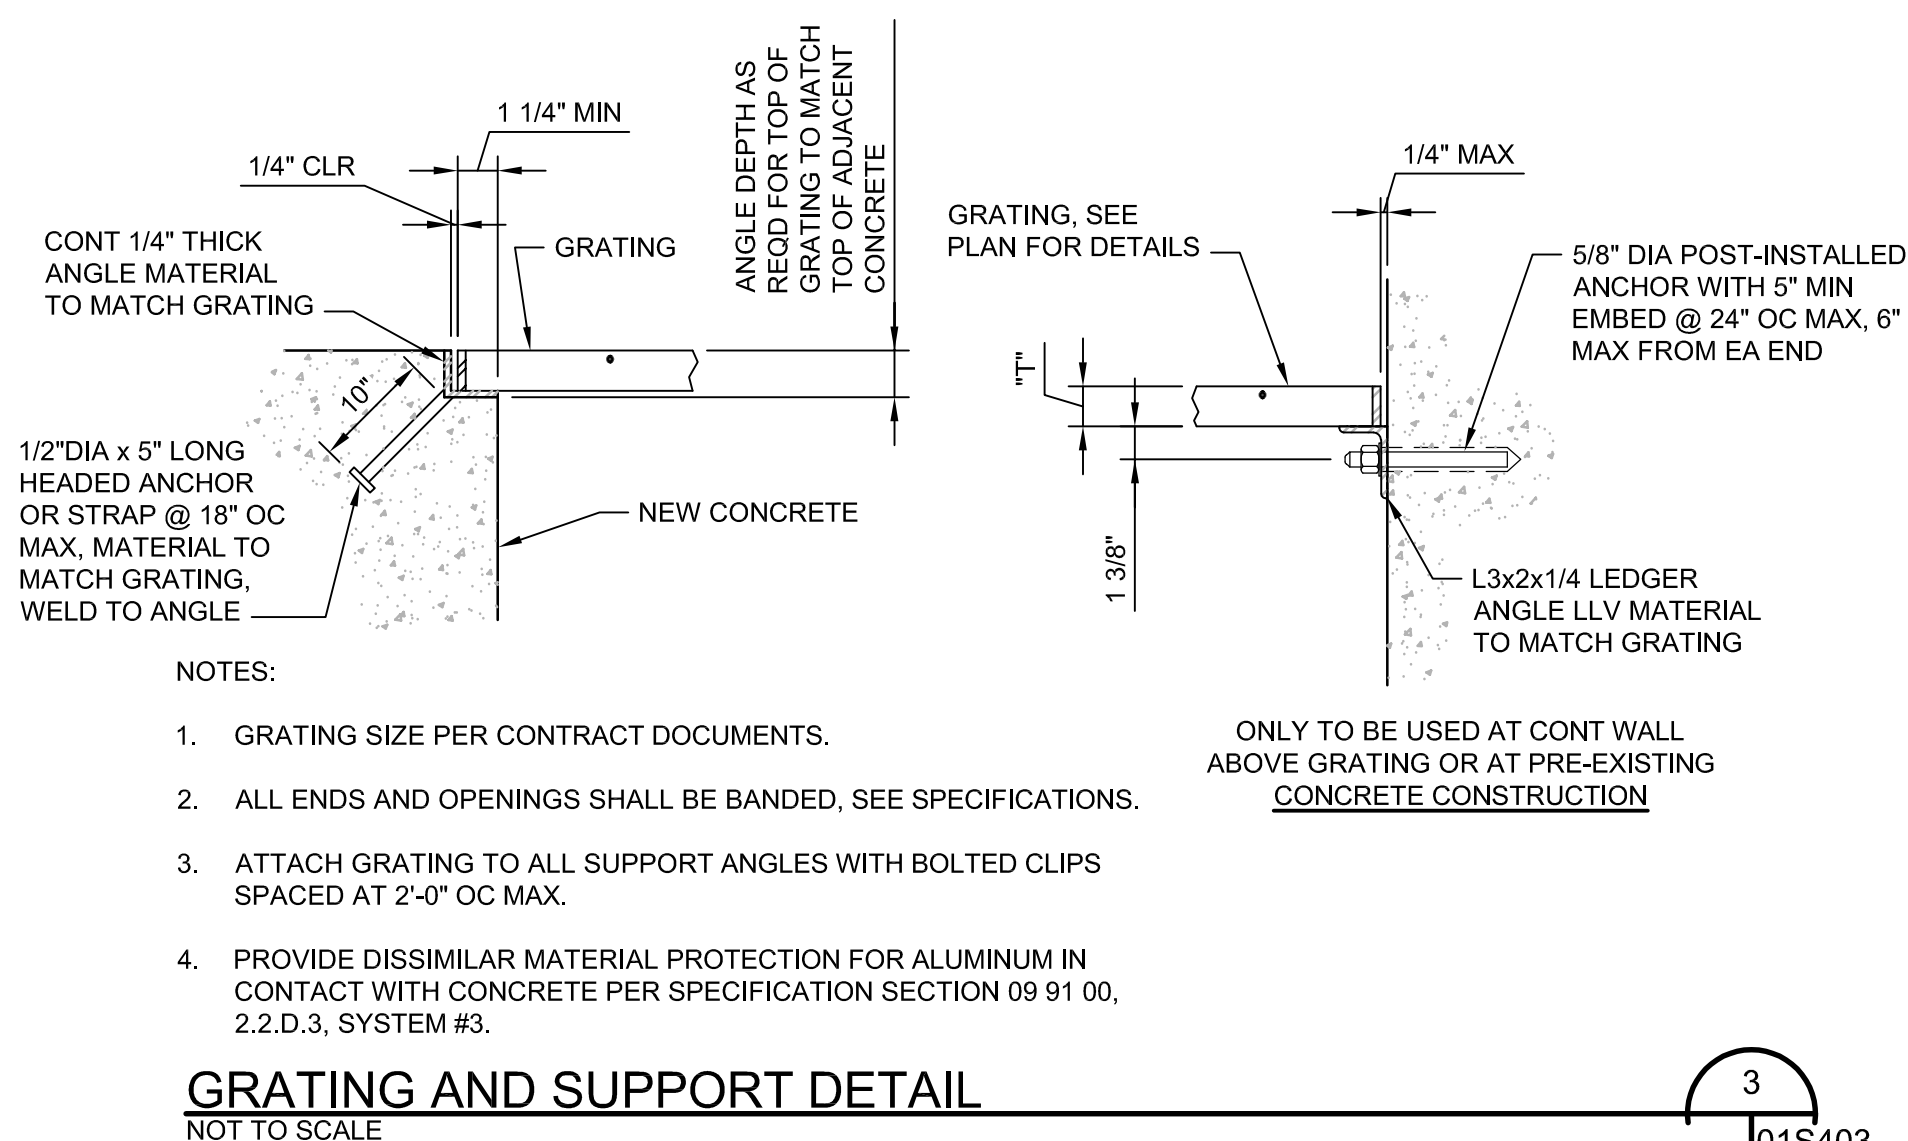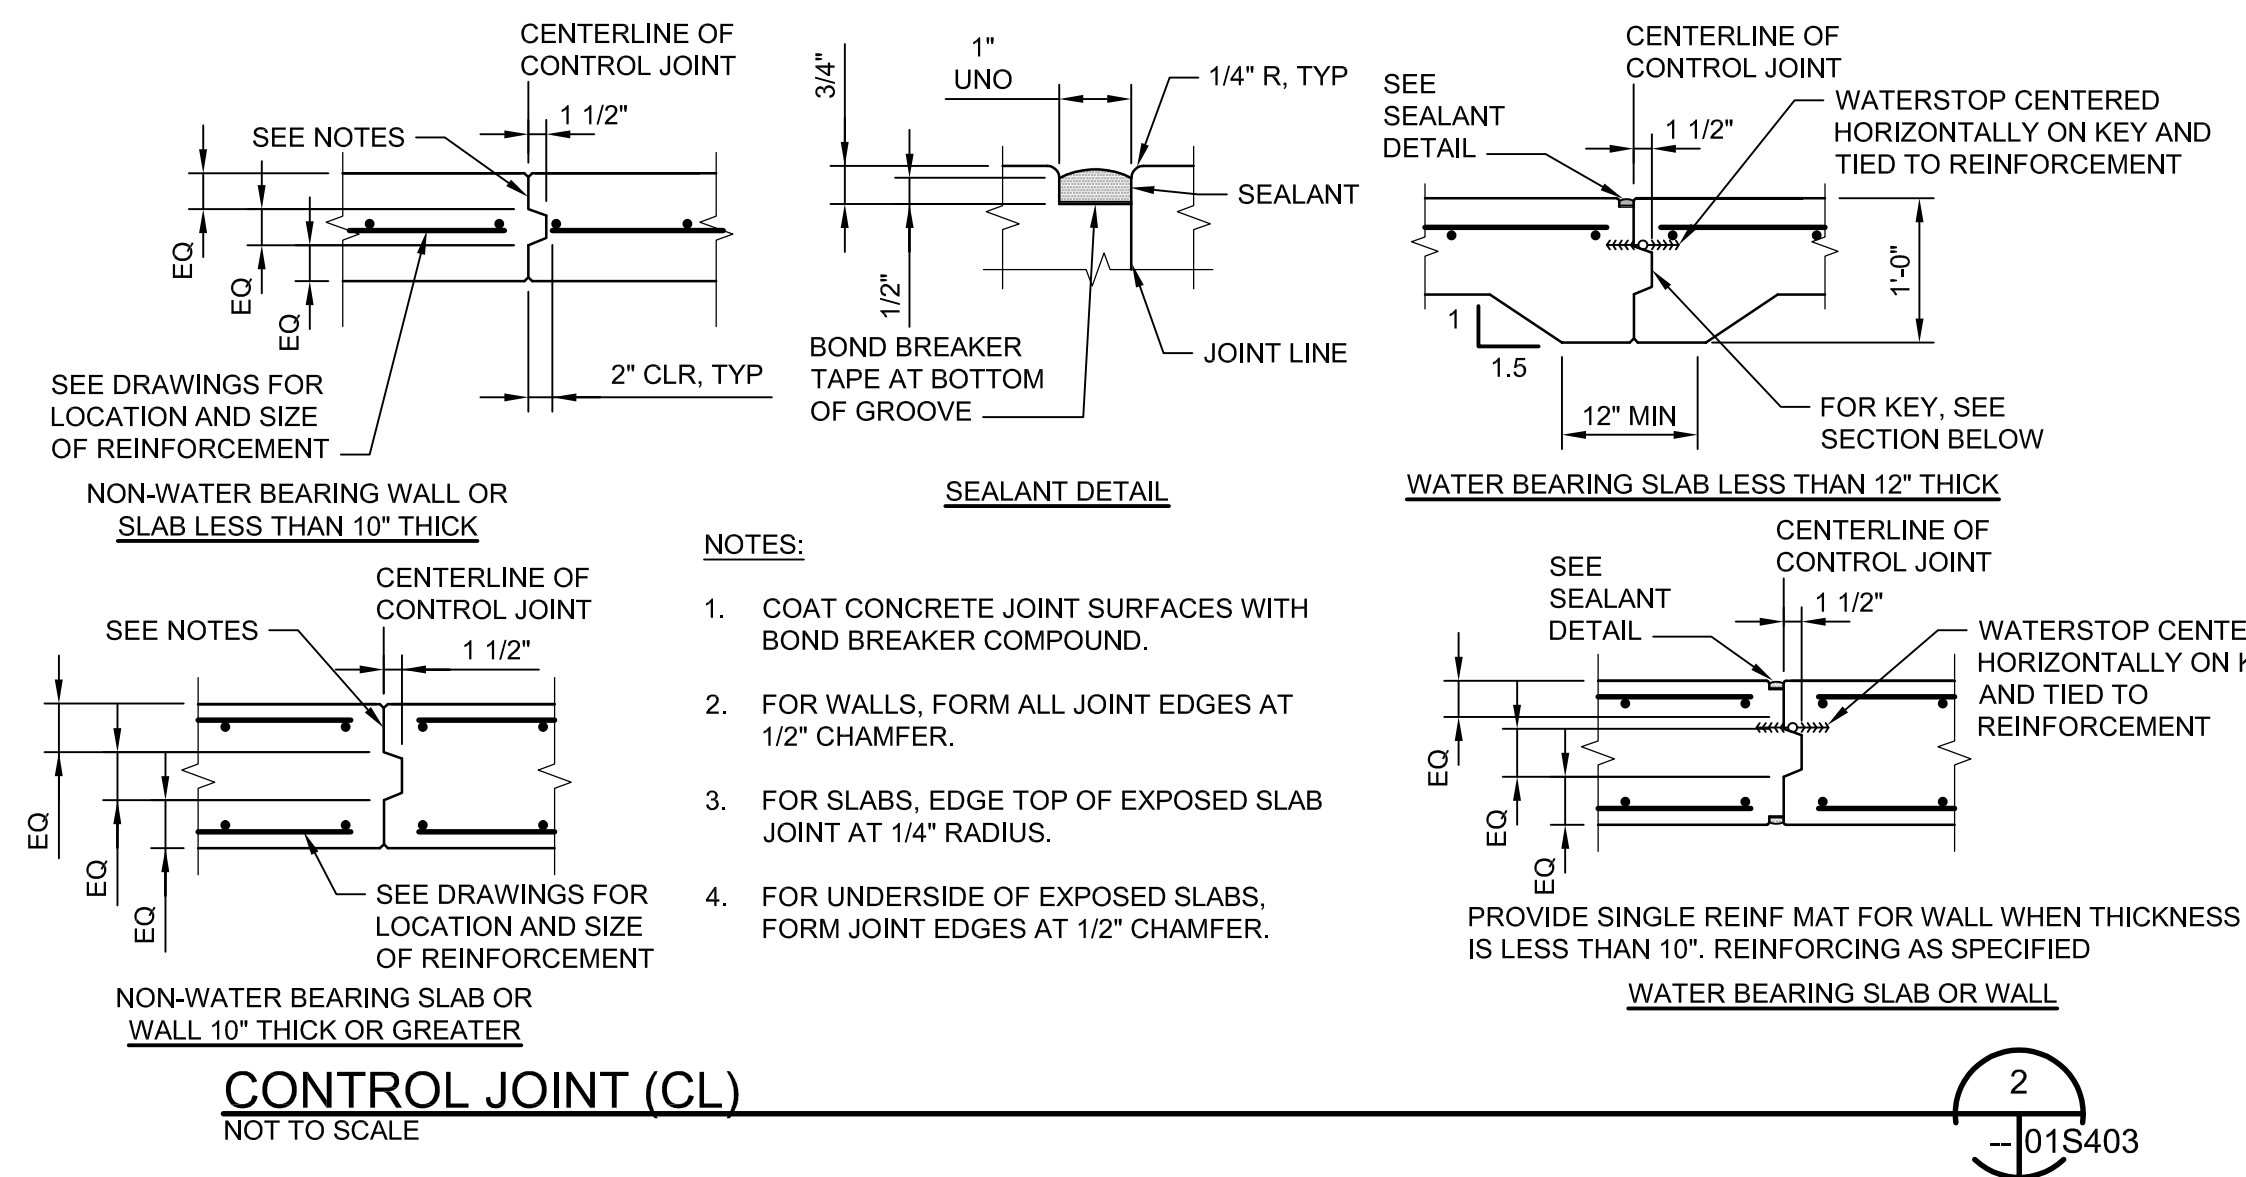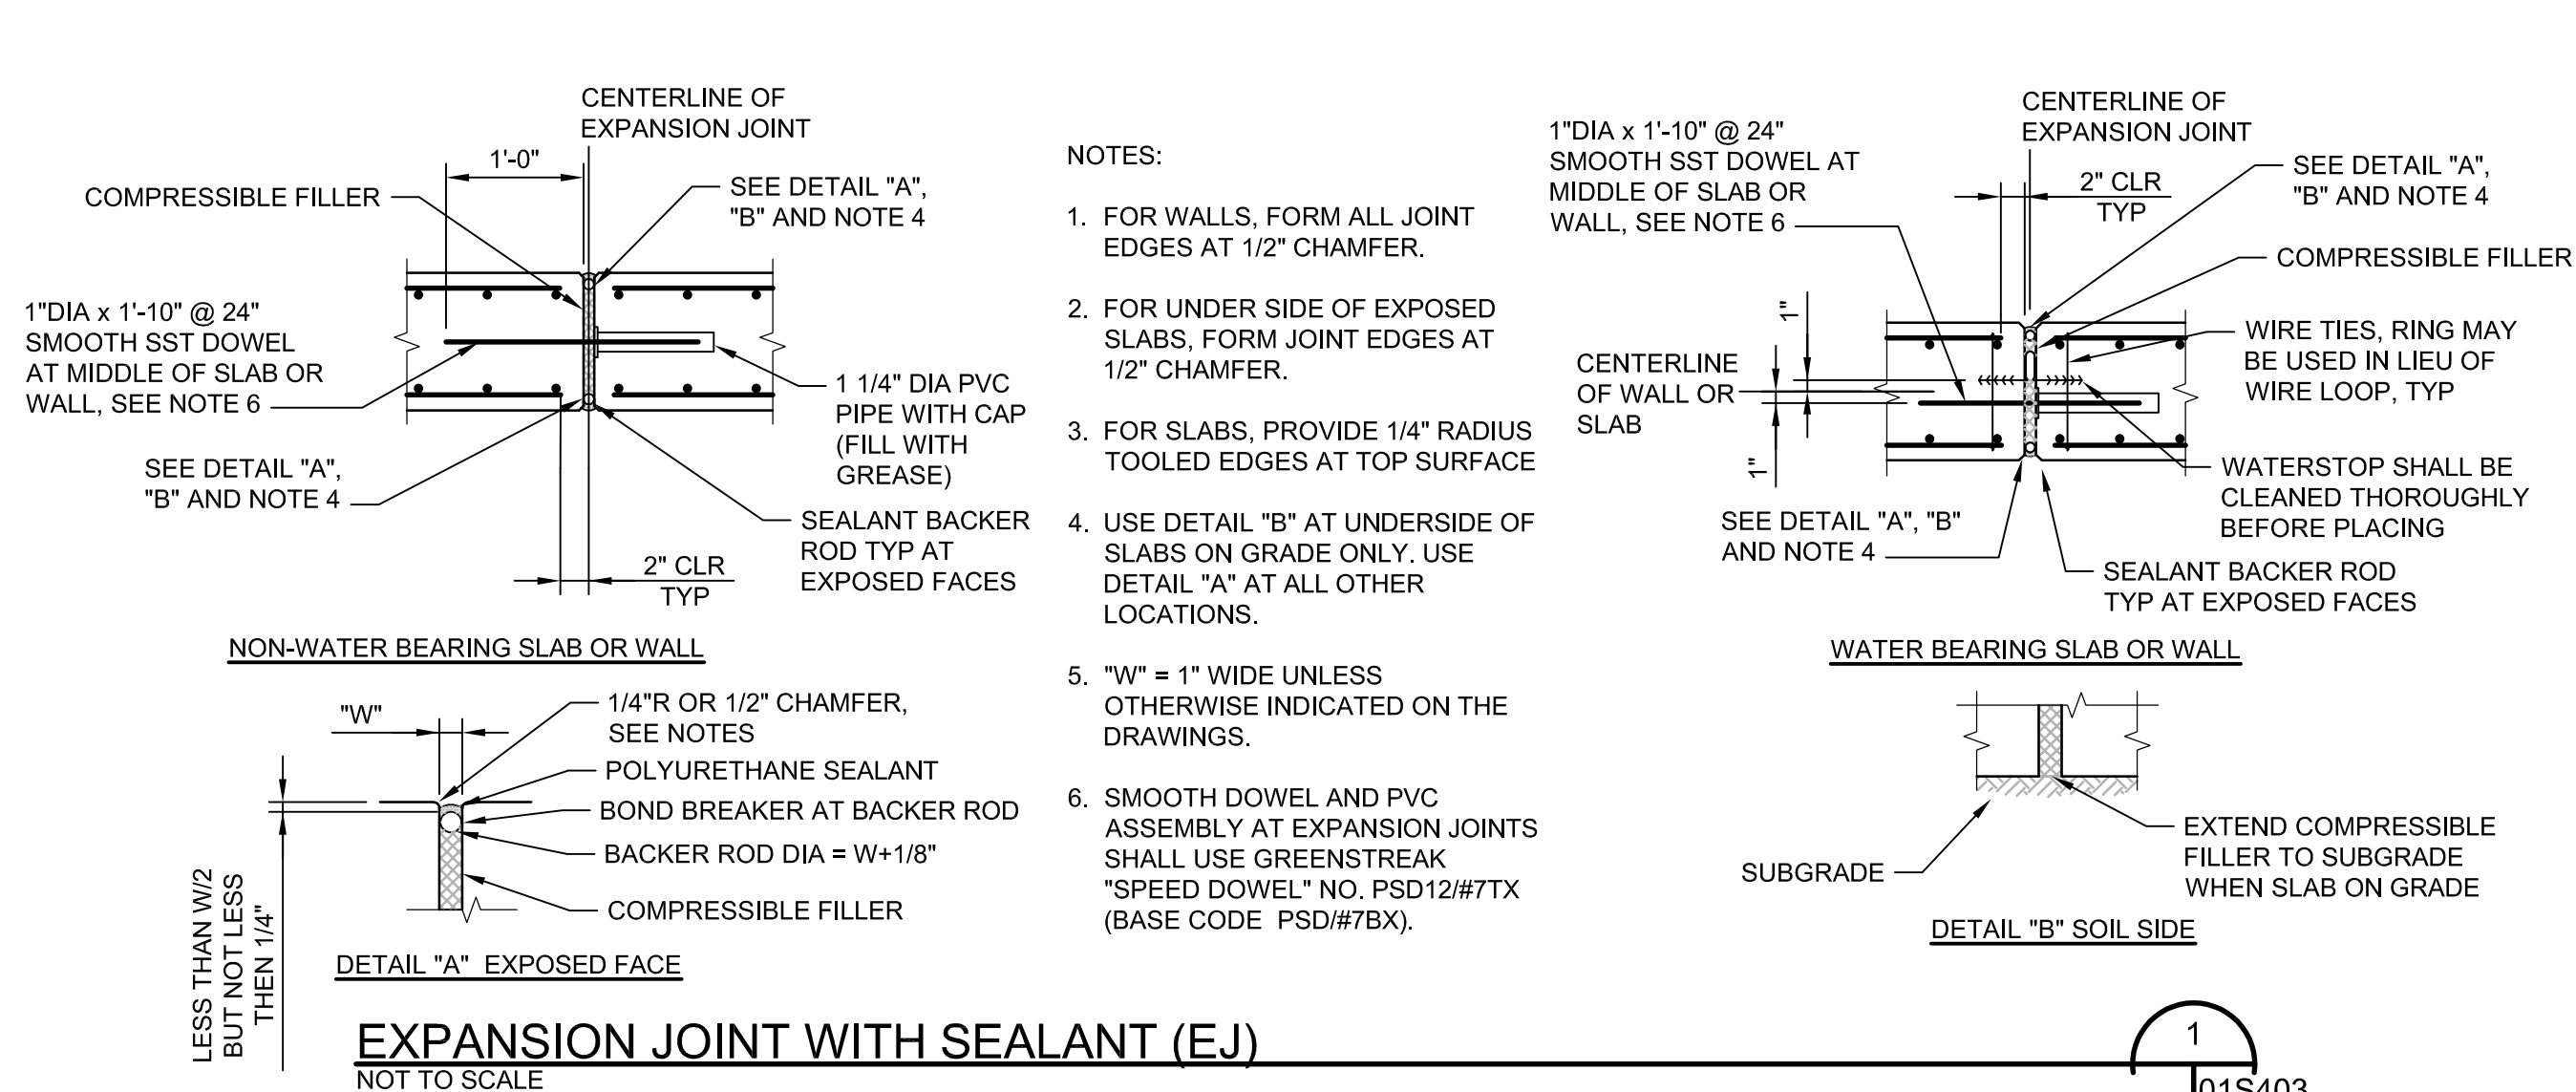

ISSUE	DATE	DESCRIPTION

PROJECT MANAGER	ERIC ORTON P.E.
DESIGN BY	JLH
DESIGN BY	
CHECKED BY	
DRAWN BY	JLC
PLOT DATE	May 18, 2023
PROJECT NUMBER	10176455



5-19-2023

**KALAMA CREEK HATCHERY
PHASE 2**

**NATURAL RESOURCES DEPARTMENT
NISQUALLY INDIAN TRIBE**


EDA AWARD NUMBER 07-79-07880

**STANDARDS
STRUCTURAL
DETAILS 3**



FILENAME | 01S403.DWG
SCALE | AS NOTED


SHEET
01S403

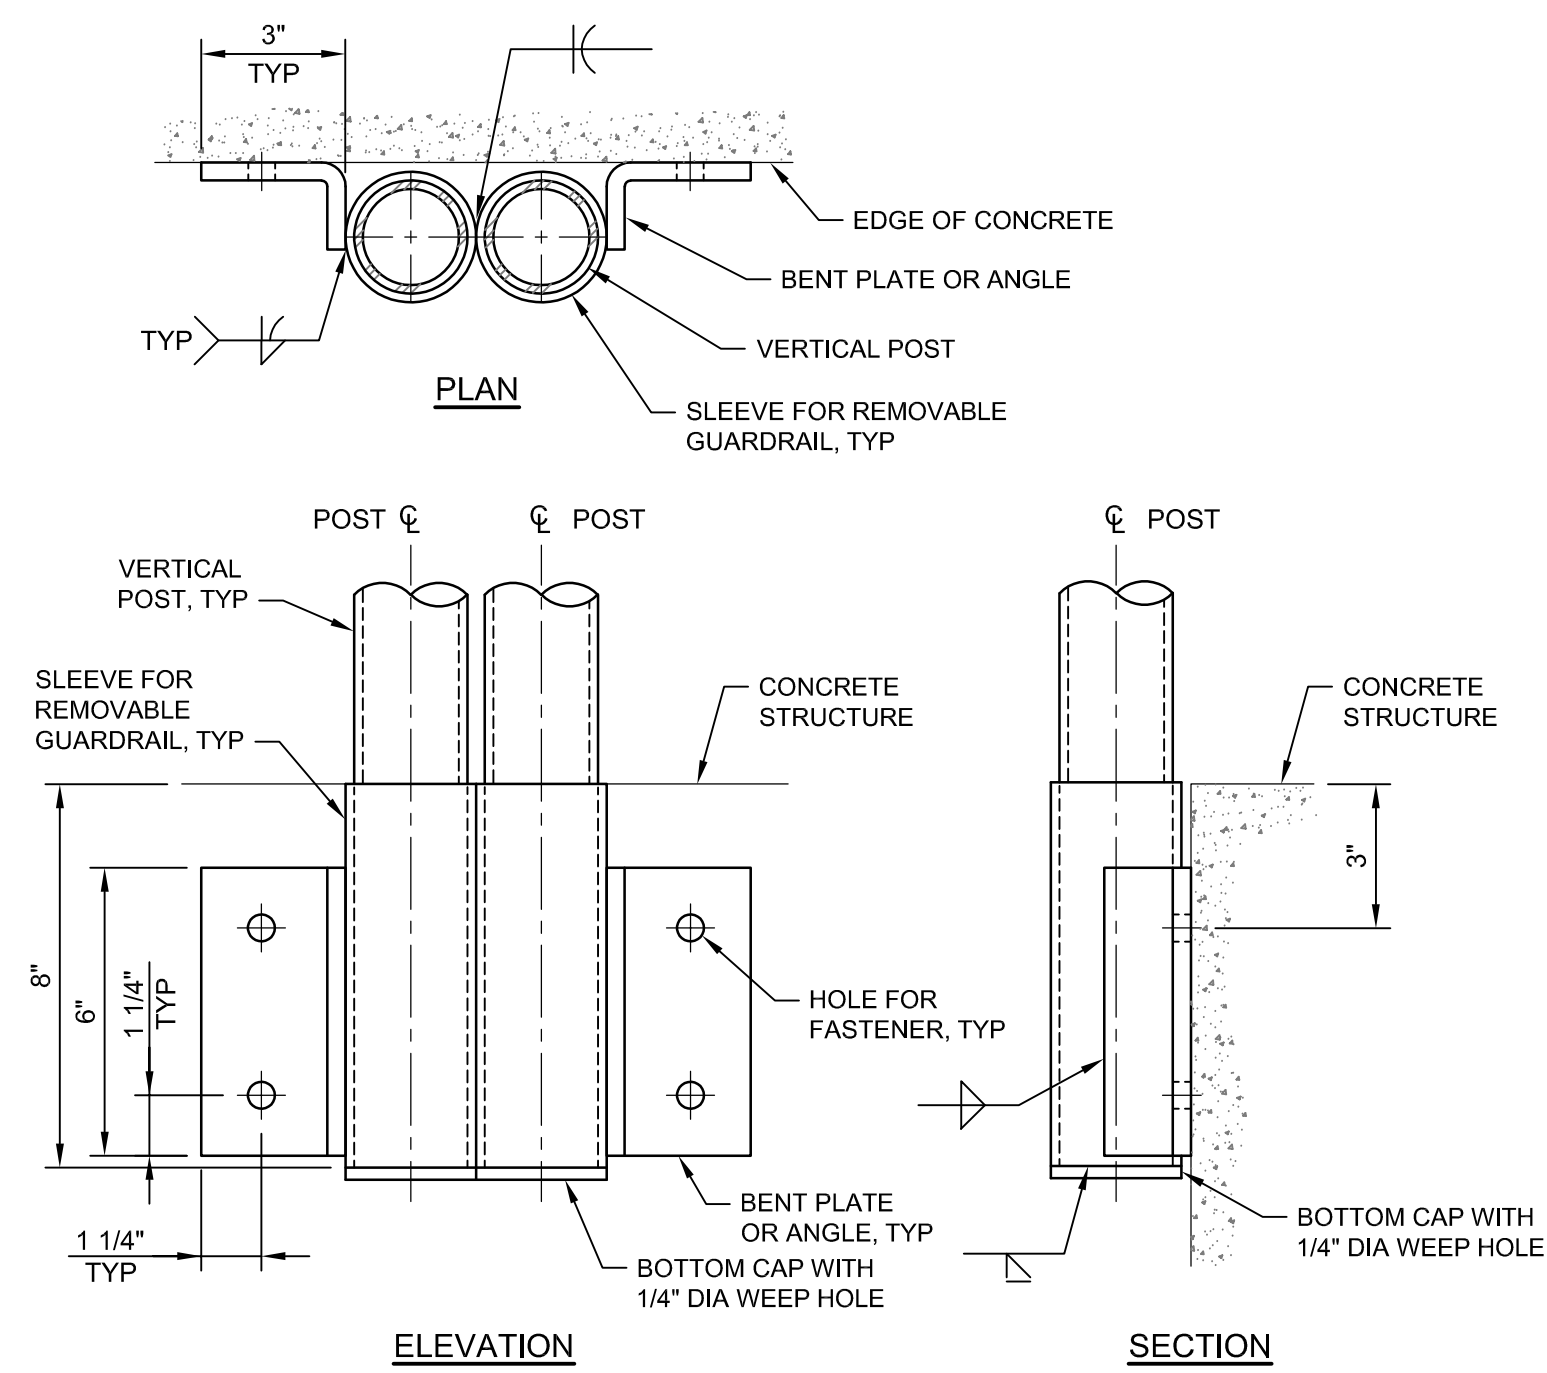

GUARDRAIL BRACKET A
SCALE: 3" = 1'-0"

NOTE:


ALL MATERIAL SHALL
BE ALUMINUM WITH
304 SS FASTENERS

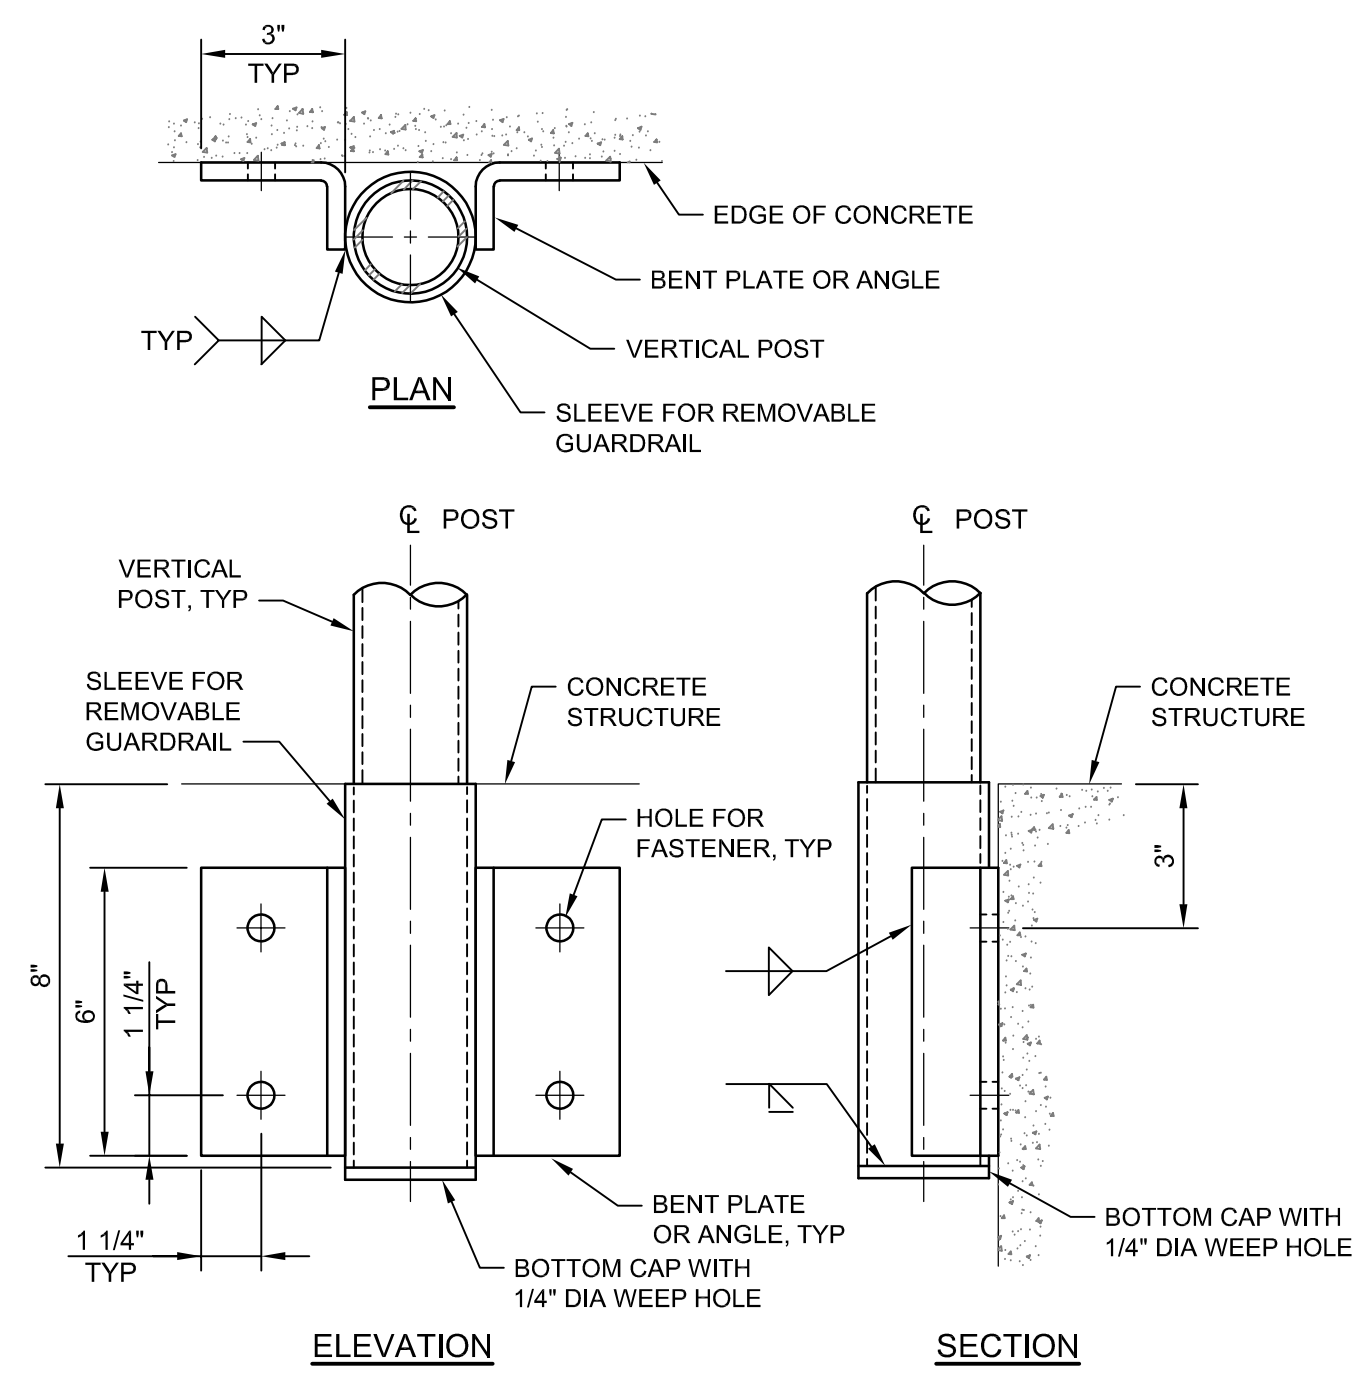

GUARDRAIL BRACKET B
SCALE: 3" = 1'-0"

NOTE:

5 ALL MATERIAL SHALL
BE ALUMINUM WITH
304 SS FASTENERS

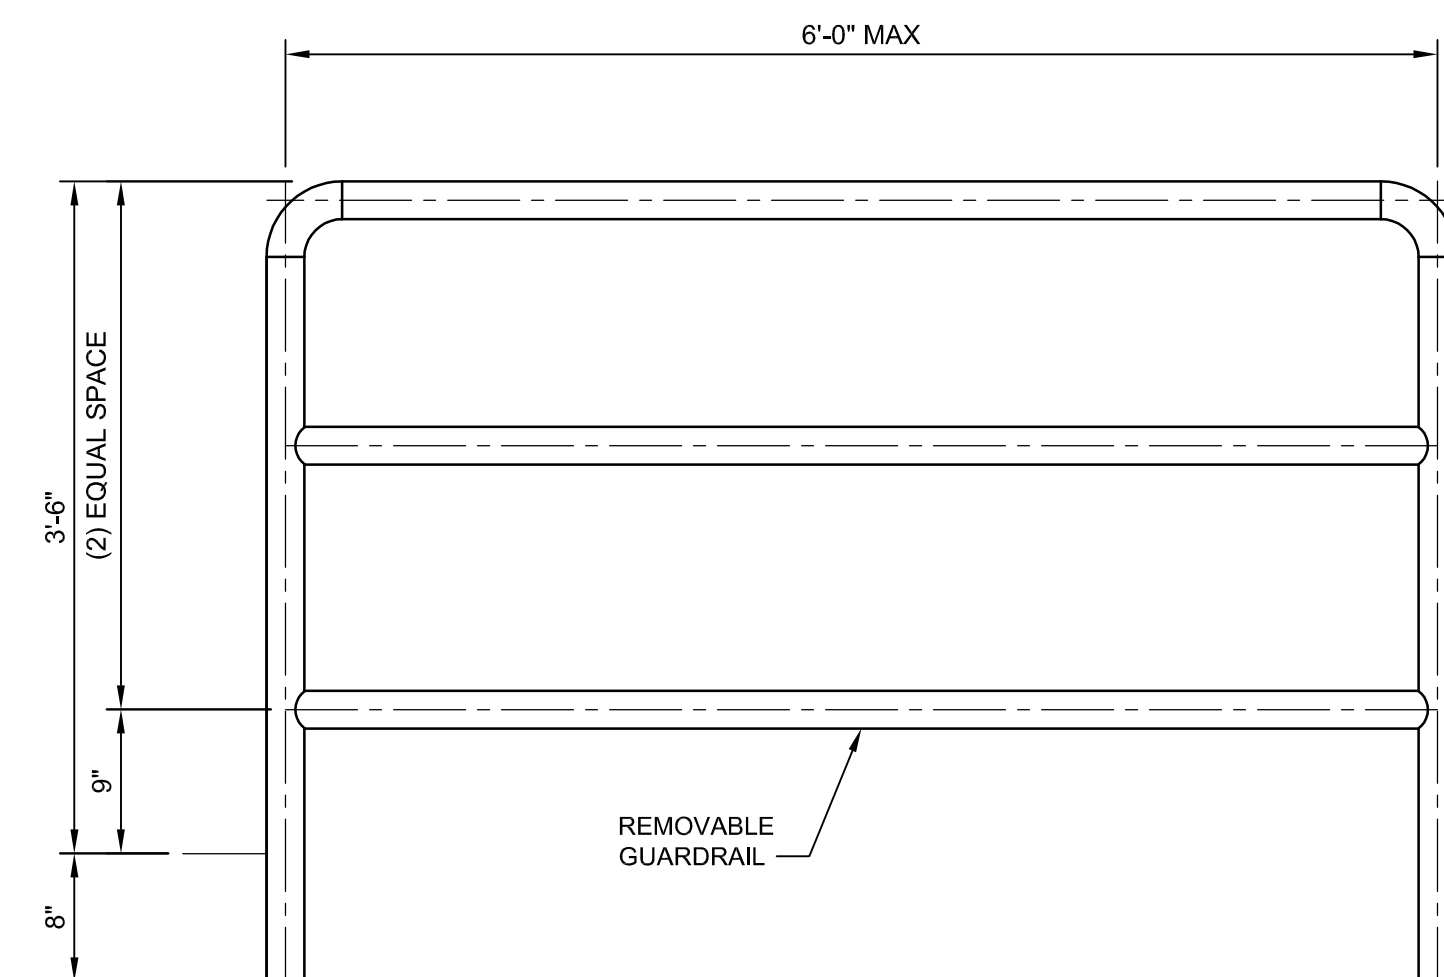

TYPICAL GUARDRAIL
SCALE: 1" = 1'-0"

NOTE:

ALL MATERIAL SHALL
5 BE ALUMINUM

-	-	-
ISSUE	DATE	DESCRIPTION


PROJECT MANAGER	ERIC ORTON	P.E.
DESIGN BY	JLH	
DESIGN BY		
CHECKED BY		
DRAWN BY	ACB	
PLOT DATE	May 18, 2023	
PROJECT NUMBER	10176455	



5-19-202:

KALAMA CREEK HATCHERY PHASE 2

**NATURAL RESOURCES DEPARTMENT
NISQUALLY INDIAN TRIBE
EDA AWARD NUMBER 07-79-07880**

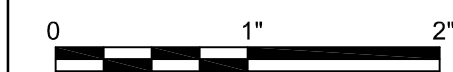


STANDARDS

STRUCTURAL DETAILS 5


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SCALE	AS NOTED

SHEET
01S405

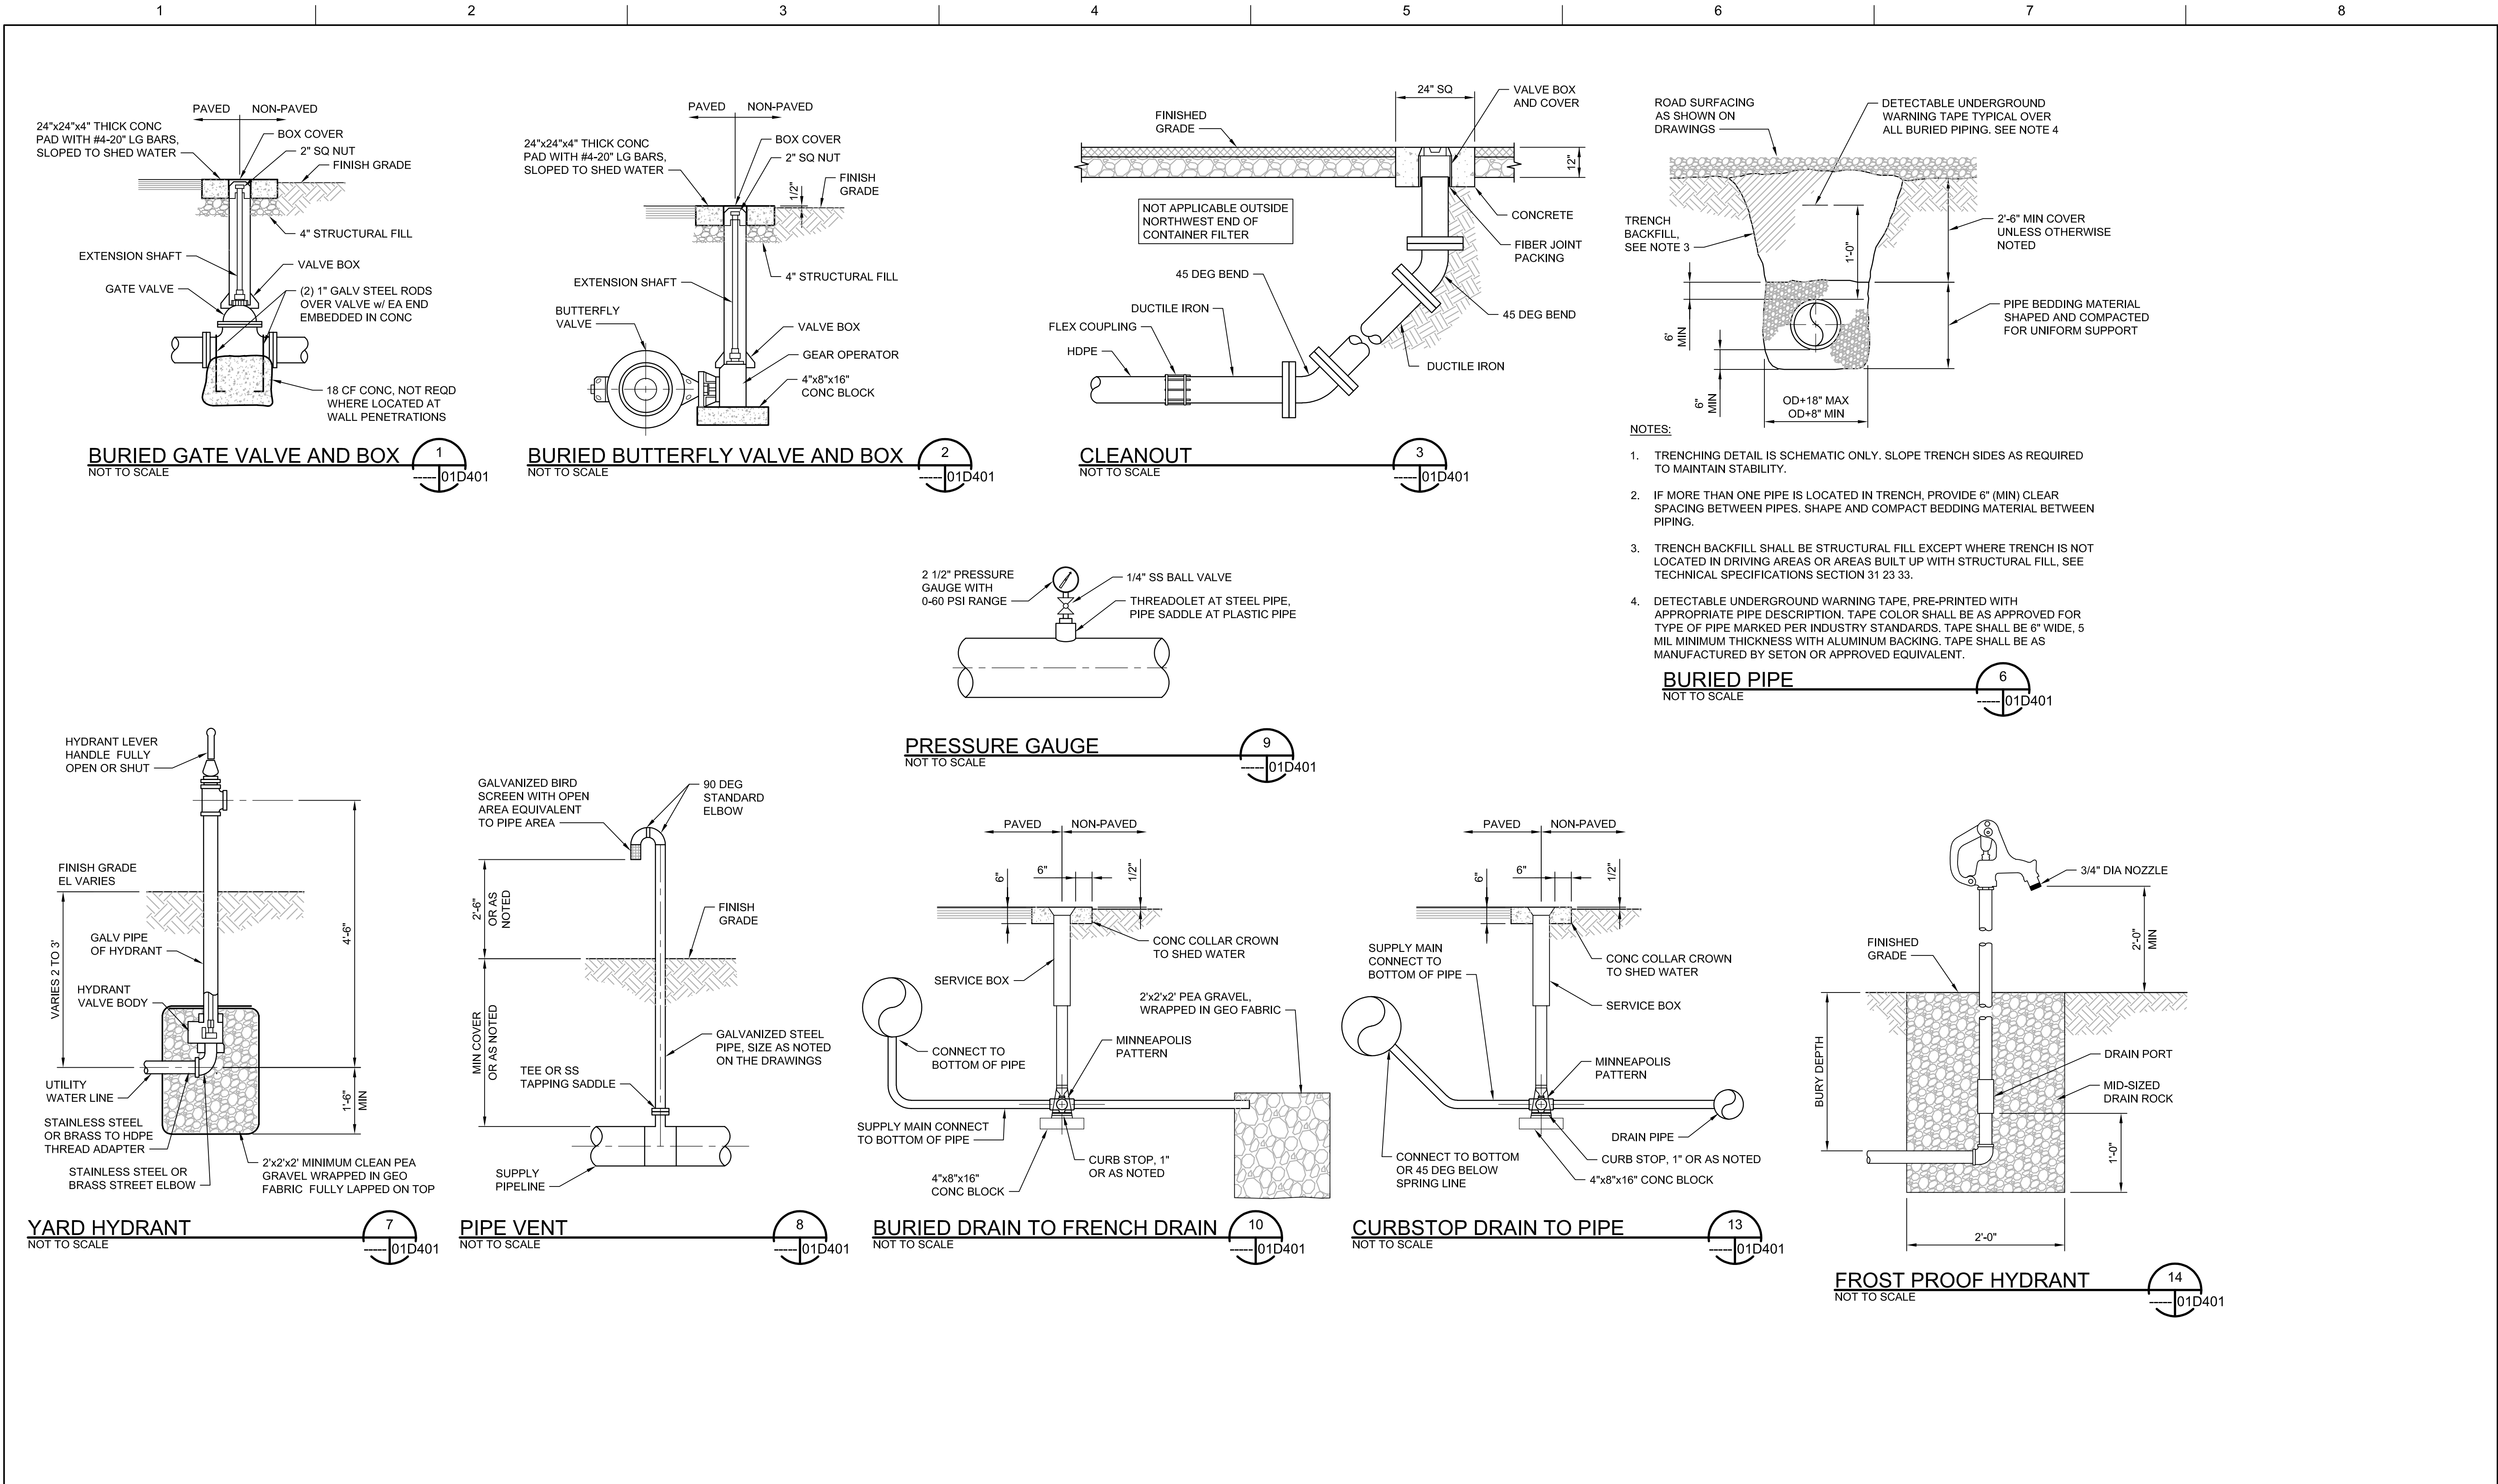

ISSUE	DATE	DESCRIPTION


PROJECT MANAGER	ERIC ORTON P.E.
DESIGN BY	KML
DESIGN BY	TT
CHECKED BY	
DRAWN BY	ACB
PLOT DATE	May 18, 2023
PROJECT NUMBER	10176455

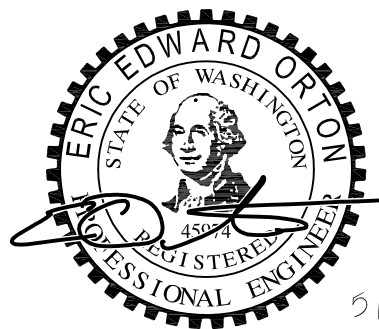

5/19/2023


**KALAMA CREEK HATCHERY
PHASE 2**
**NATURAL RESOURCES DEPARTMENT
NISQUALLY INDIAN TRIBE**
EDA AWARD NUMBER 07-79-07880

**STANDARDS
PROCESS PIPING
DETAILS**

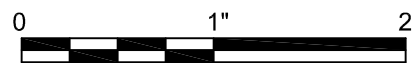


FILENAME | 01D401.DWG
SCALE | AS NOTED

SHEET
01D401

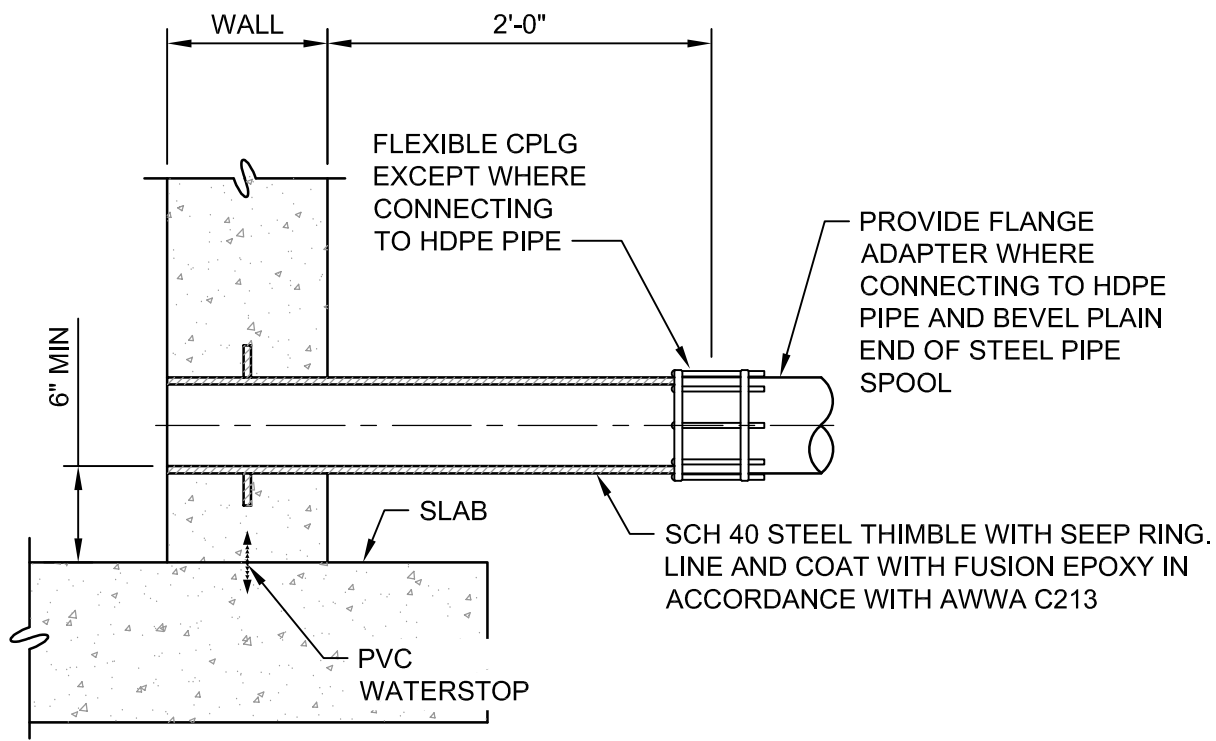


PIPE SPOOL
NOT TO SCALE

3
01D402

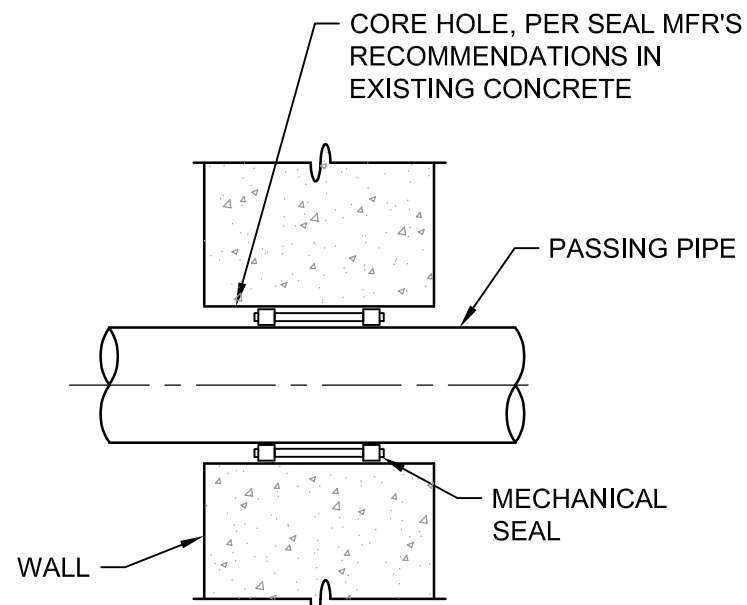


MECHANICAL SEAL
NOT TO SCALE

4
01D402

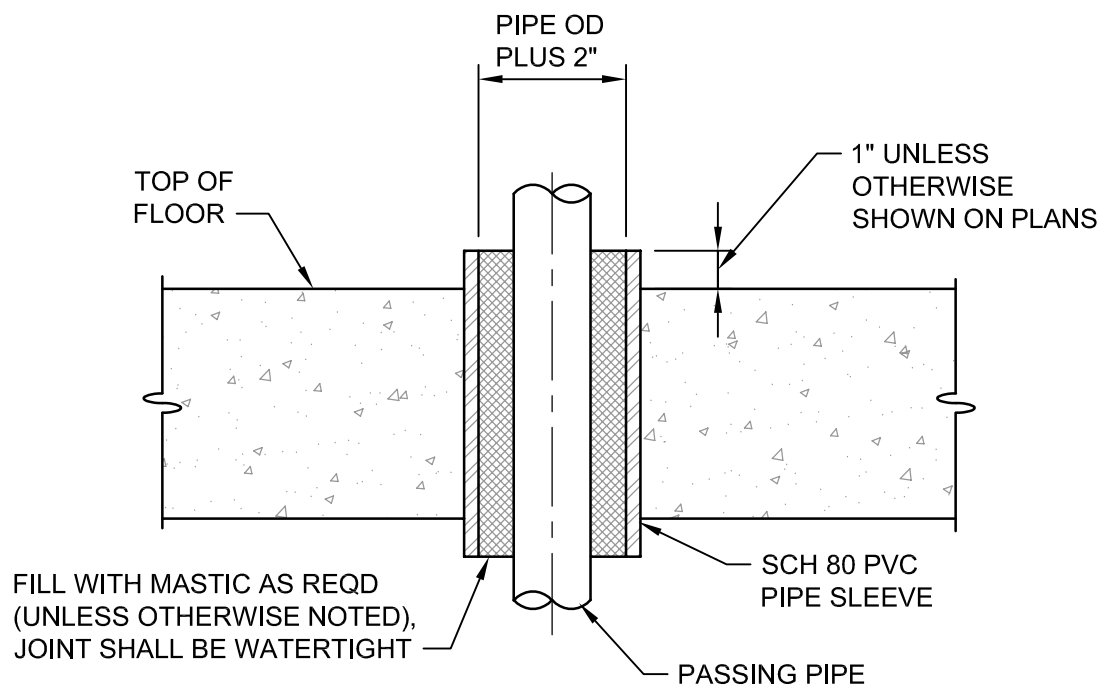


FLOOR SLEEVE
NOT TO SCALE

5
01D402

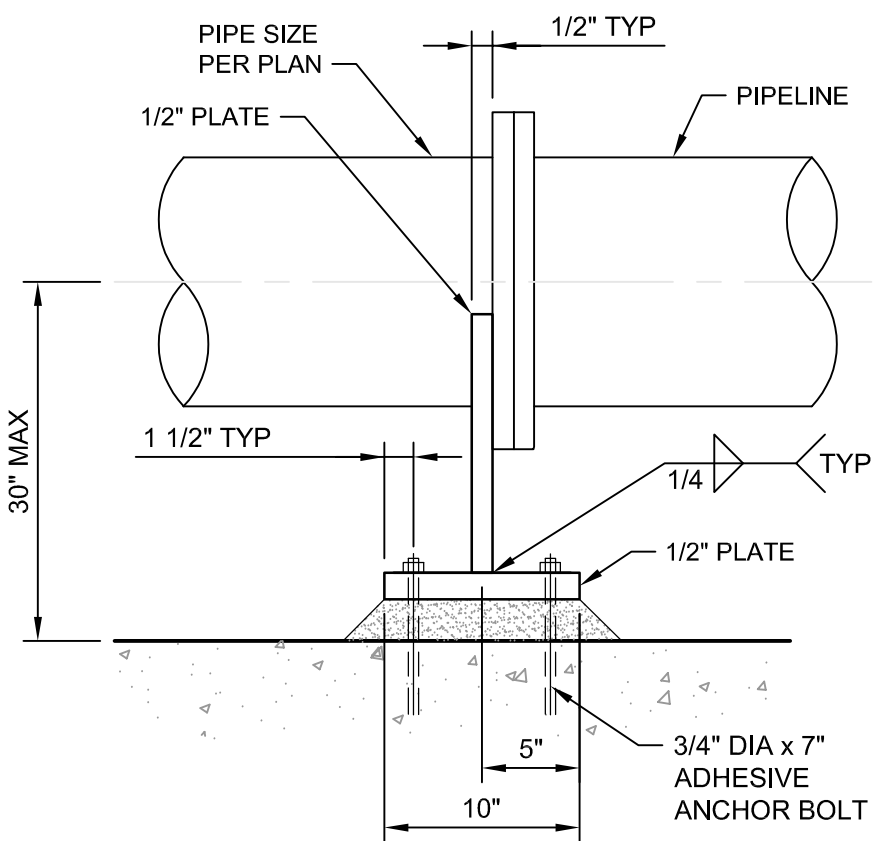


ELEVATION

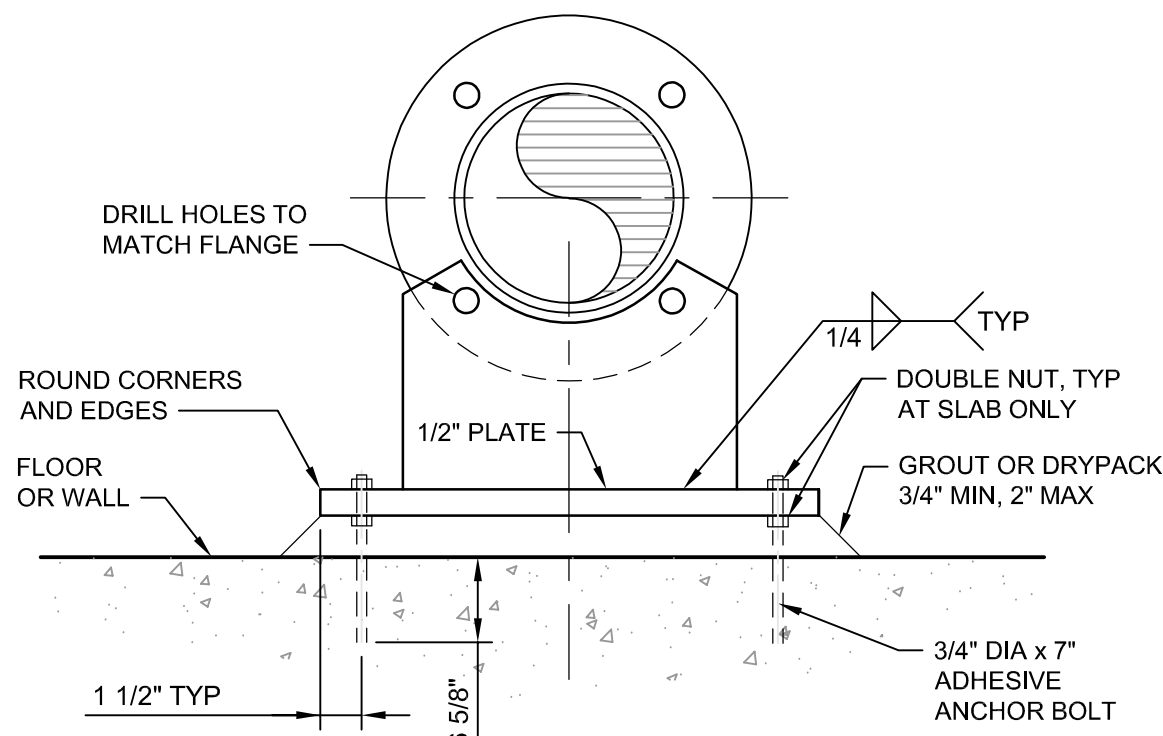

SECTION

STEEL PIPE SUPPORT
NOT TO SCALE

6
01D402

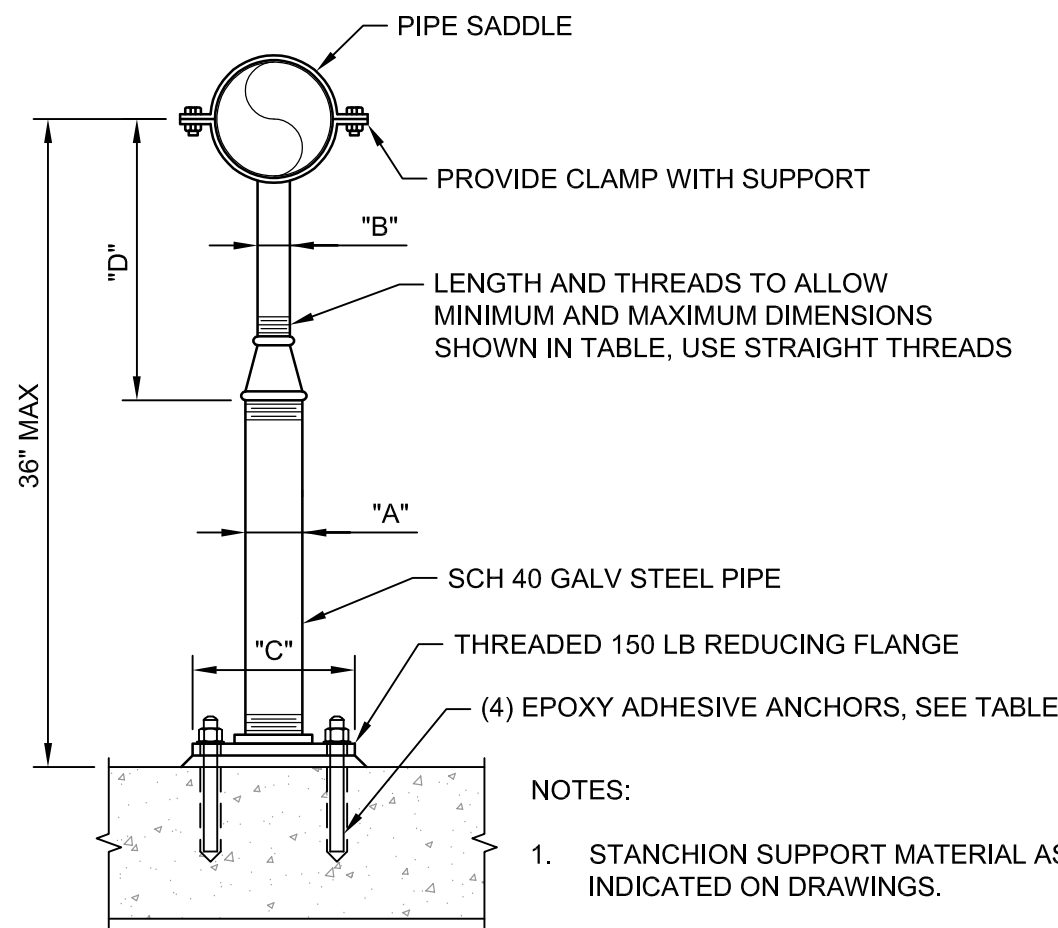

- NOTES:
1. STANCHION SUPPORT MATERIAL AS INDICATED ON DRAWINGS.
 2. PAINT EXPOSED THREADS AND USE SS ANCHORS.

FLOOR PIPE SUPPORT SCHEDULE DIMENSIONS IN INCHES							
PIPE SIZE	"A"	"B"	"C"	"D"		ANCHORS	
				MINIMUM	MAXIMUM	DIA	EMBED
≤ 2 1/2	2 1/2	1 1/2	9	8	13	5/8	5
3	2 1/2	1 1/2	9	8 1/2	13 1/2	5/8	5
3 1/2	2 1/2	1 1/2	9	8 1/2	13 1/2	5/8	5
4	3	2 1/2	9	9 1/2	14	5/8	5
6	3	2 1/2	9	10 1/2	15 1/2	5/8	5
8	3	2 1/2	9	11 1/2	16 1/2	5/8	5
10	3	2 1/2	9	13 1/2	18 1/2	5/8	5
12	3	2 1/2	9	15	19 1/2	5/8	5
14	4	3	11	16 1/2	20 1/2	3/4	6 5/8
16	4	3	11	17 1/2	22 1/2	3/4	6 5/8
18	6	3 1/2	13 1/2	19 1/2	24	3/4	6 5/8
20	6	3 1/2	13 1/2	21	25 1/2	3/4	6 5/8
24	6	4	13 1/2	23 1/2	28 1/2	3/4	6 5/8


STANCHION SUPPORT
NOT TO SCALE

7
01D402



ISSUE	DATE	DESCRIPTION

PROJECT MANAGER ERIC ORTON P.E.	
DESIGN BY	KML
DESIGN BY	
CHECKED BY	
DRAWN BY	ACB
PLOT DATE	May 18, 2023
PROJECT NUMBER	10176455

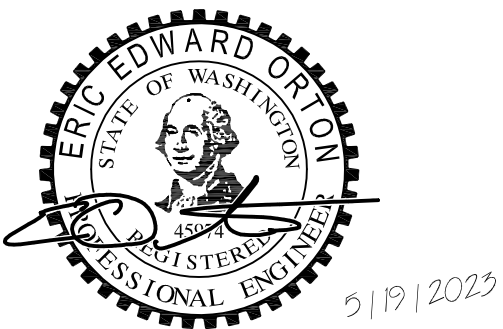


KALAMA CREEK HATCHERY
PHASE 2
NATURAL RESOURCES DEPARTMENT
NISQUALLY INDIAN TRIBE
EDA AWARD NUMBER 07-79-07880



STANDARDS
PROCESS PIPING
DETAILS
FILENAME 01D402.DWG
SCALE AS NOTED

SHEET
01D402

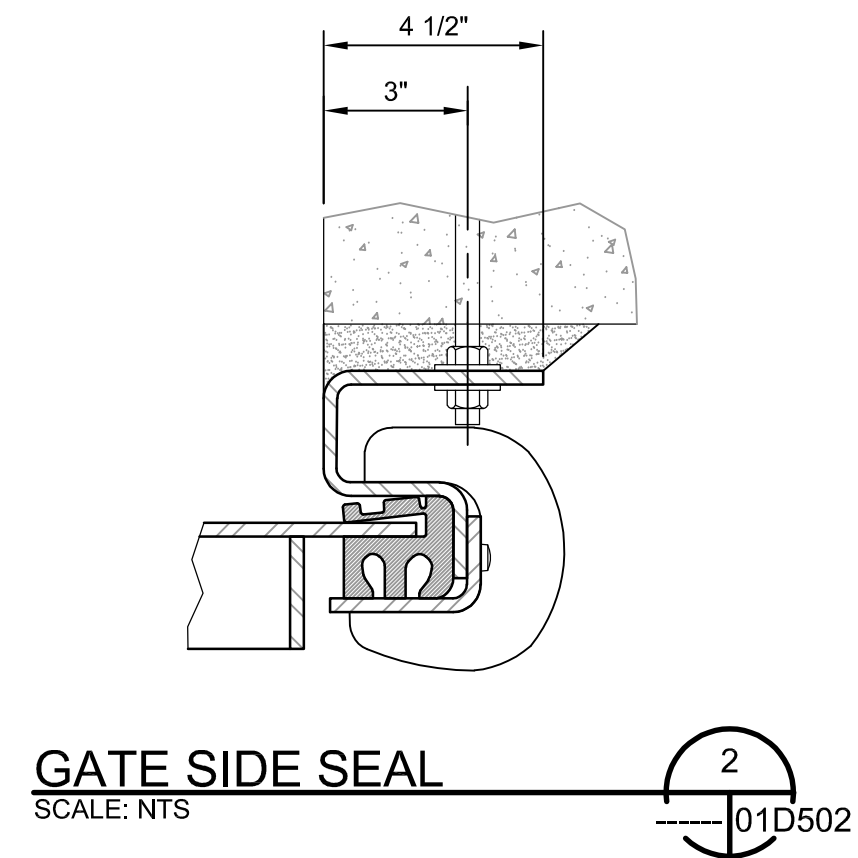


1. BOLT PATTERN OF GATE FRAMES SHALL BE AT LEAST 2" CLEAR OF PIPE TO STRUCTURE ADAPTERS OR WALL PIPES WHEN ANCHOR BOLTS ARE EPOXY AND 3" WHEN ANCHOR BOLTS ARE MECHANICAL.
2. ALL GATES SHALL BE SELF CONTAINED AND FLAT BACK, GROUTED PER MANUFACTURERS RECOMMENDATIONS.

SLIDE GATE SCHEDULE									
TAG	STRUCTURE	DETAIL	NOMINAL SIZE	OPERATOR TYPE AND ELEVATION		DESIGN HEAD PRESSURE	SIDE SEAL	BOTTOM SEAL	REMARKS
04G-01	LOWER SITE CONC POND	A / 04D401	36" x 36"	HANDWHEEL,	EL 81.36	5.5' UNSEATING HEAD	2	3	RISING STEM
04G-02	LOWER SITE CONC POND	1 / 04D401	12" DIA	2" NUT,	EL 79.00	7.0' SEATING HEAD	NA	NA	CANAL GATE, SPIGOT BACK, WATERMAN C-10 OR EQUIV
16G-01	LOWER SITE PA POND	C / 16D401	12" x 36"	HANDWHEEL,	EL 82.50	4.0' SEATING HEAD	2	1	RISING STEM

-	-	-
ISSUE	DATE	DESCRIPTION


PROJECT MANAGER	ERIC ORTON P.E.
DESIGN BY	EEO
DESIGN BY	
CHECKED BY	
DRAWN BY	JLC
PLOT DATE	May 18, 2023
PROJECT NUMBER	10176455

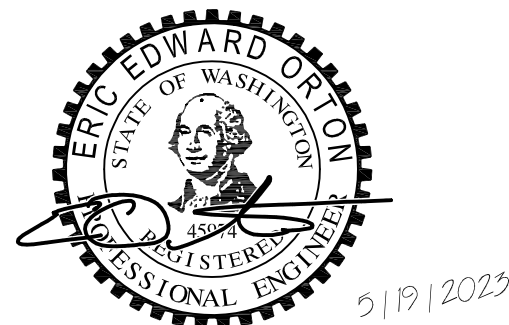

**KALAMA CREEK HATCHERY
PHASE 2
NATURAL RESOURCES DEPARTMENT
NISQUALLY INDIAN TRIBE
EDA AWARD NUMBER 07-79-07880**

STANDARDS

GATE SCHEDULE AND DETAILS

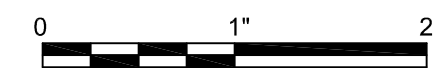


FILENAME	01D502.DWG
SCALE	AS NOTED



SHEET
01D502

HDR

PROJECT MANAGER	ERIC ORTON P.E.
DESIGN BY	DB
DESIGN BY	
CHECKED BY	
DRAWN BY	AB
PLOT DATE	May 18, 2023
PROJECT NUMBER	10176455

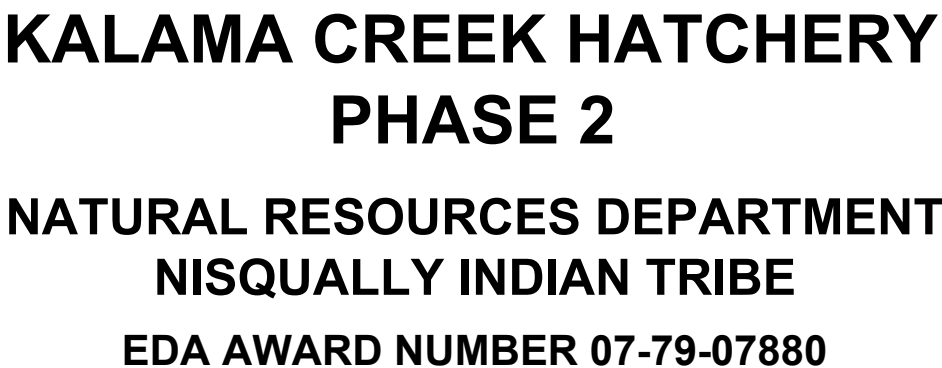

SHEET
01E002

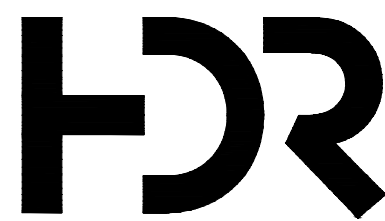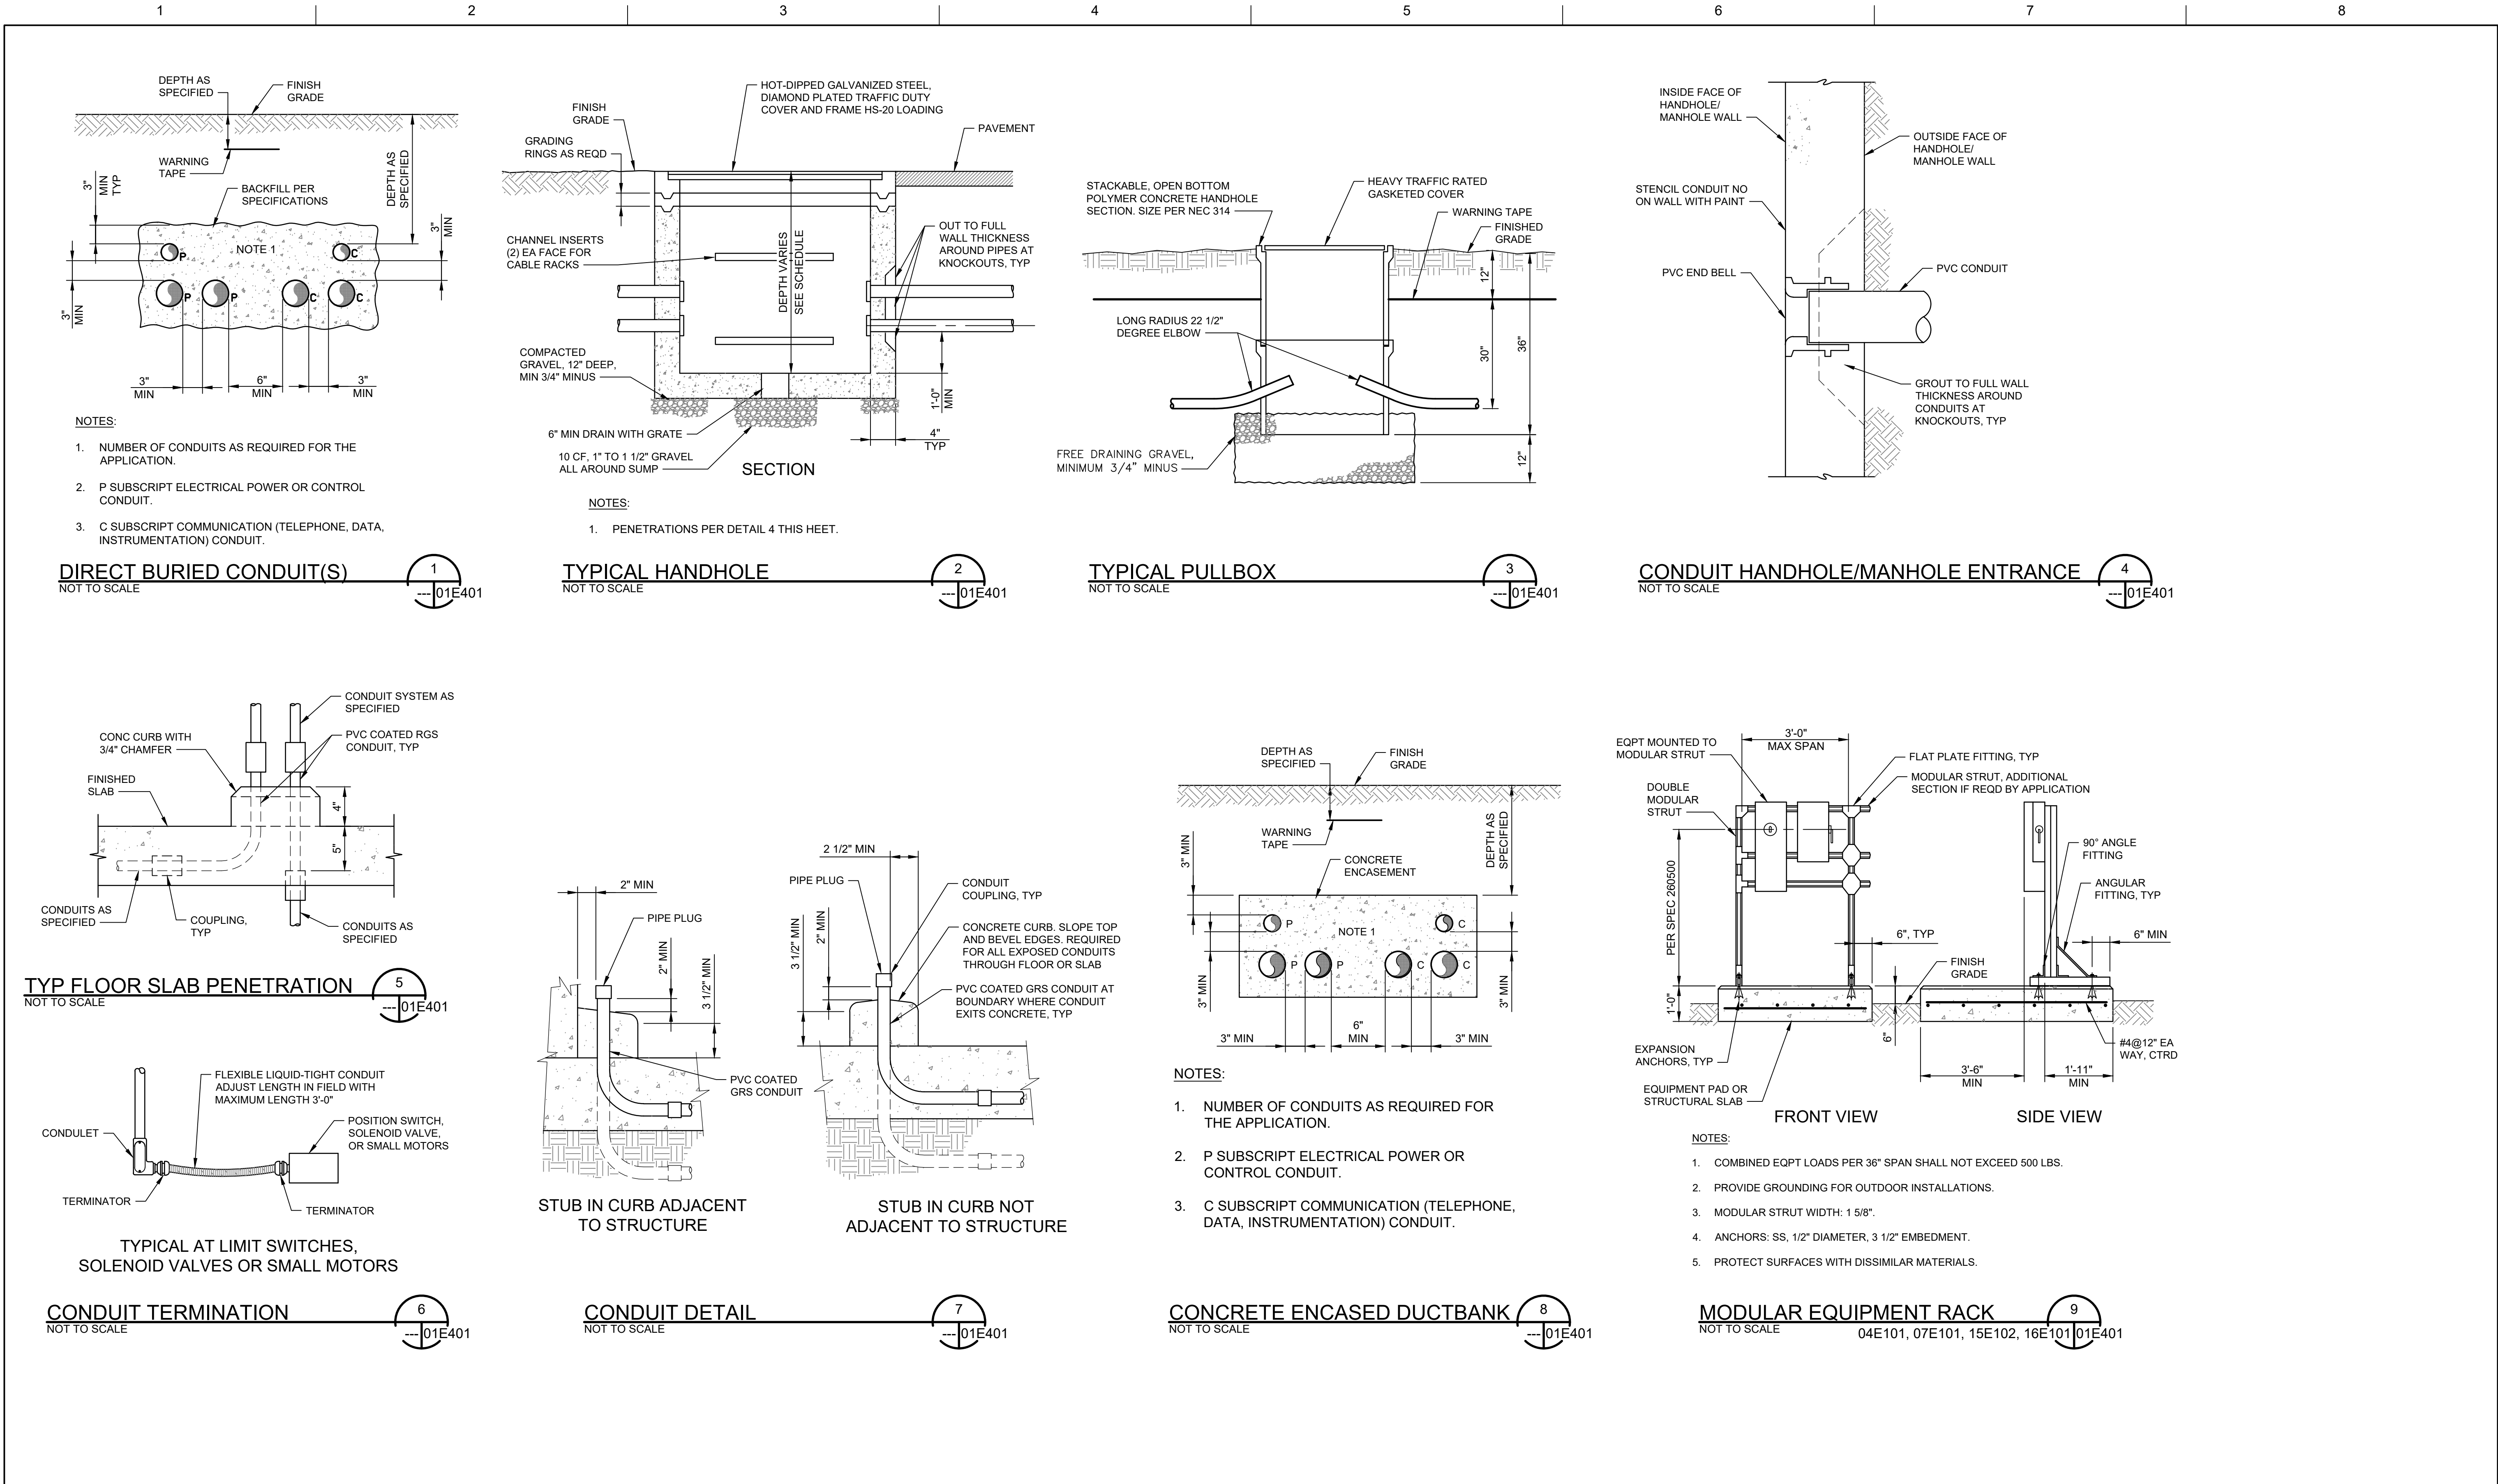


ISSUE	DATE	DESCRIPTION

PROJECT MANAGER	ERIC ORTON P.E.
DESIGN BY	DB
DESIGN BY	
CHECKED BY	
DRAWN BY	EP
PLOT DATE	May 18, 2023
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**KALAMA CREEK HATCHERY
PHASE 2**
**NATURAL RESOURCES DEPARTMENT
NISQUALLY INDIAN TRIBE**
EDA AWARD NUMBER 07-79-07880

**STANDARDS
ELECTRICAL DETAILS 1**



FILENAME	01E401.DWG
SCALE	AS NOTED

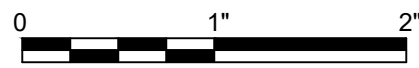SHEET
01E401

1

2

3


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5

6


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8




GROUND FIELD DETAIL

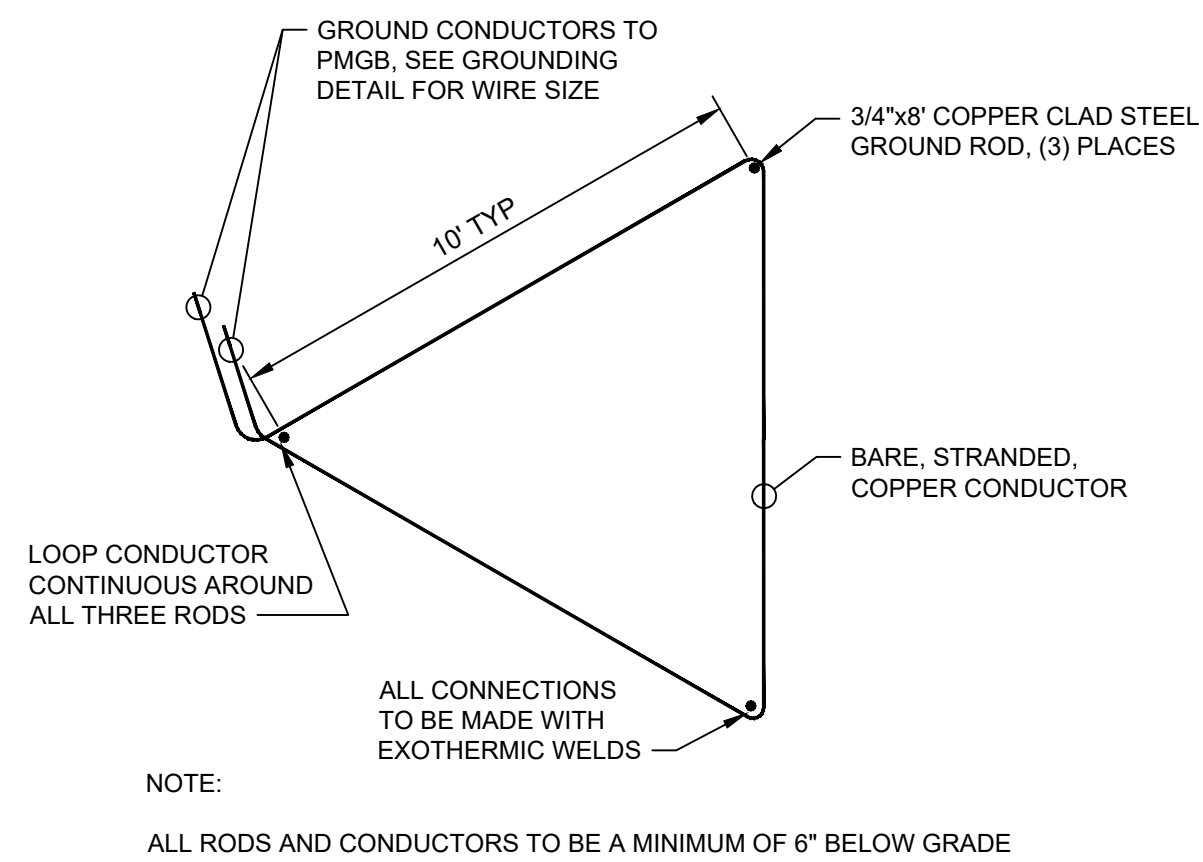NOT TO SCALE

1
03E101|01E402

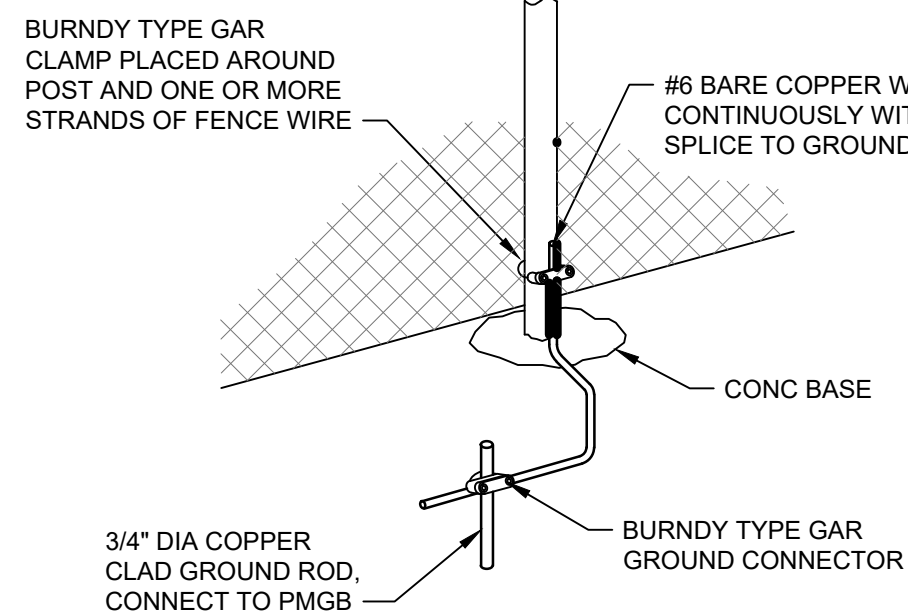
FENCE GROUNDING DETAIL

NOT TO SCALE

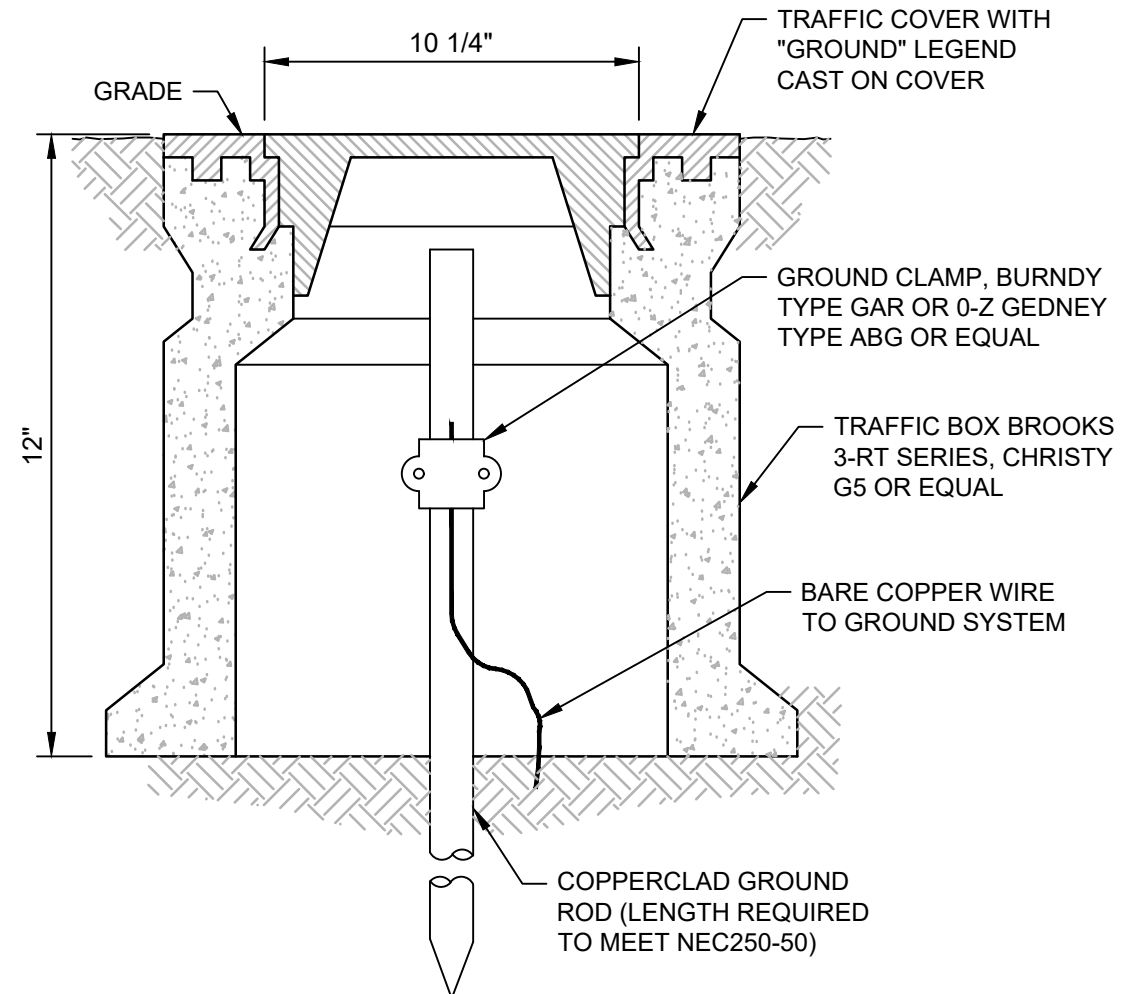2
04E101|01E402


GROUND WELL AND ROD DETAIL

NOT TO SCALE

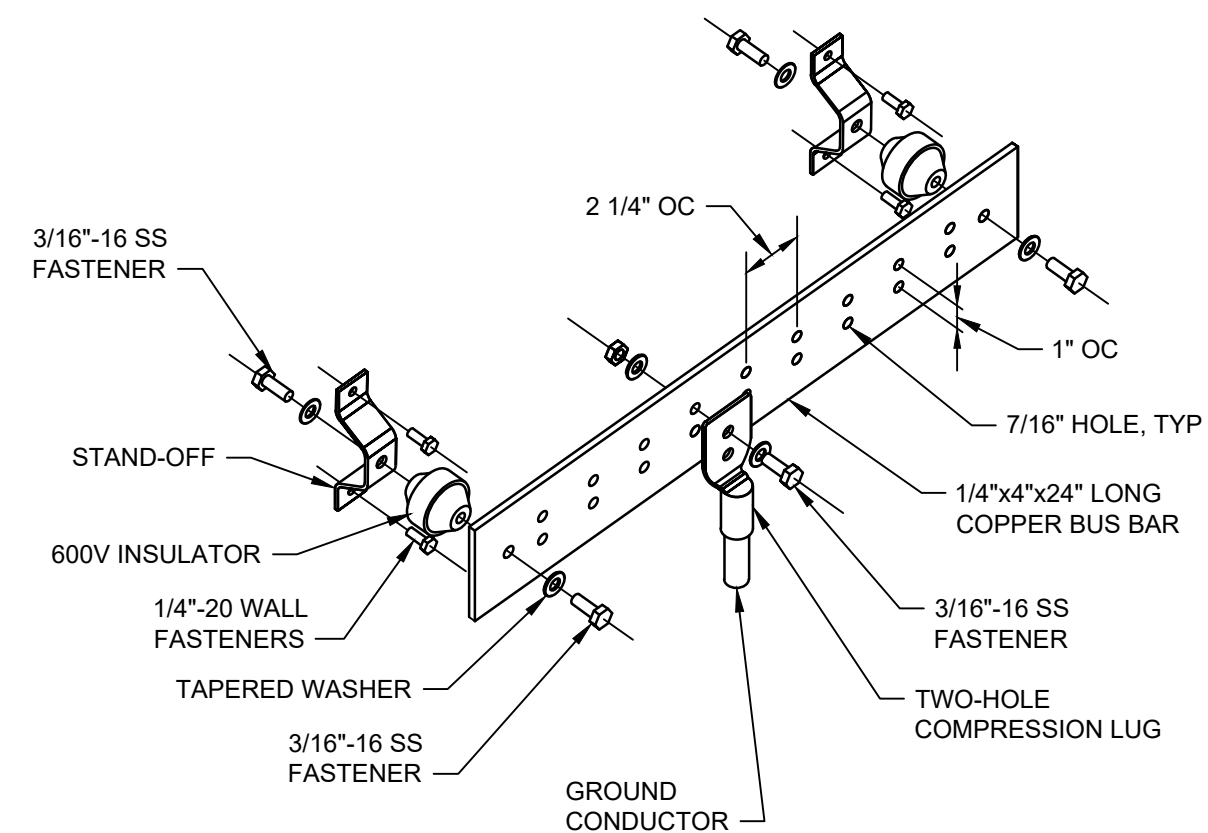3
04E101, 15E101|01E402

PRINCIPAL GROUND BUS (PGB)


NOT TO SCALE

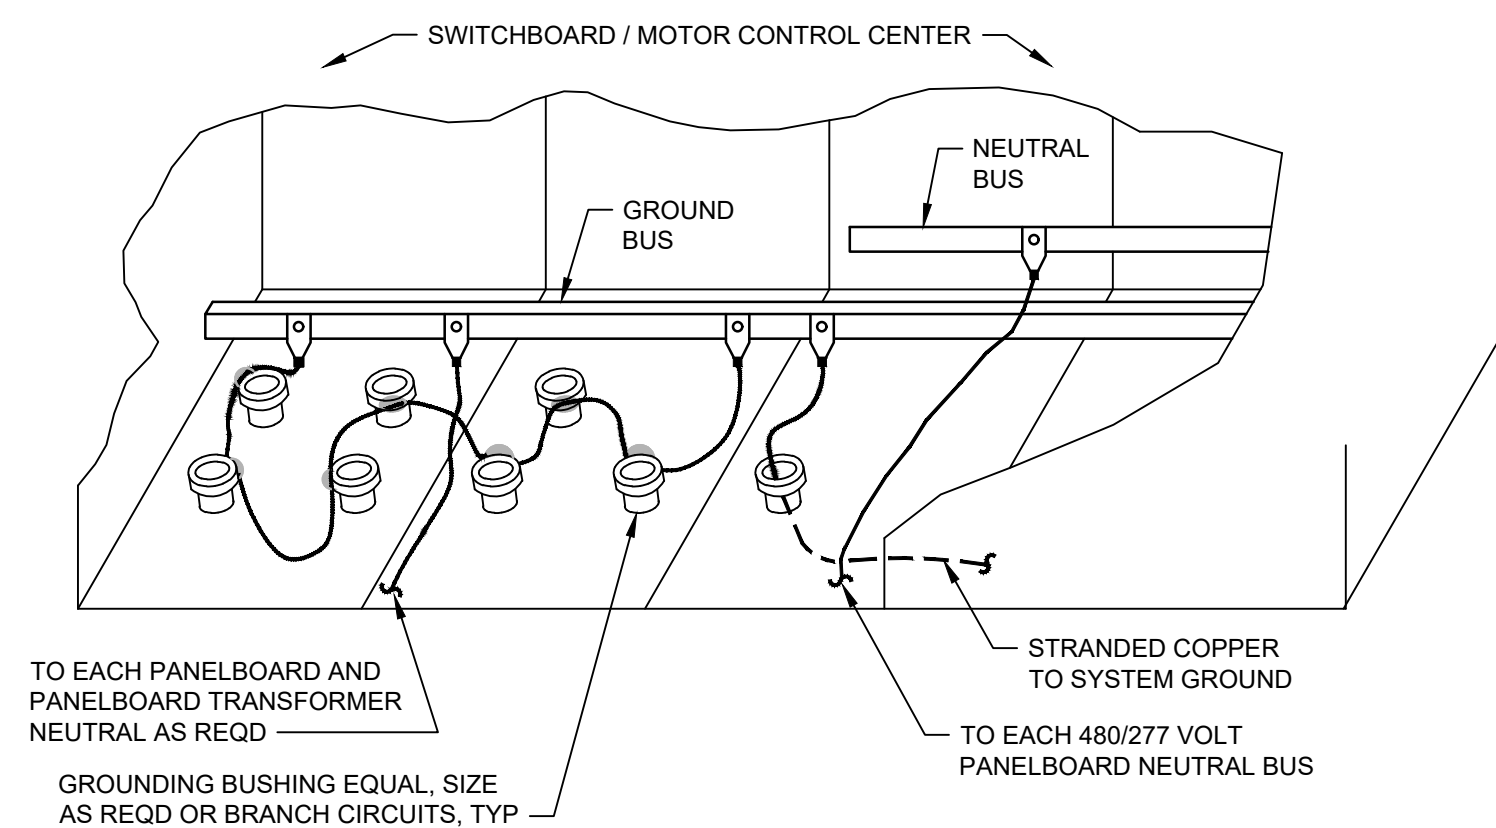4
06E101|01E402

SWITCHBOARD / MOTOR CONTROL CENTER

GROUNDING SYSTEM


NOT TO SCALE

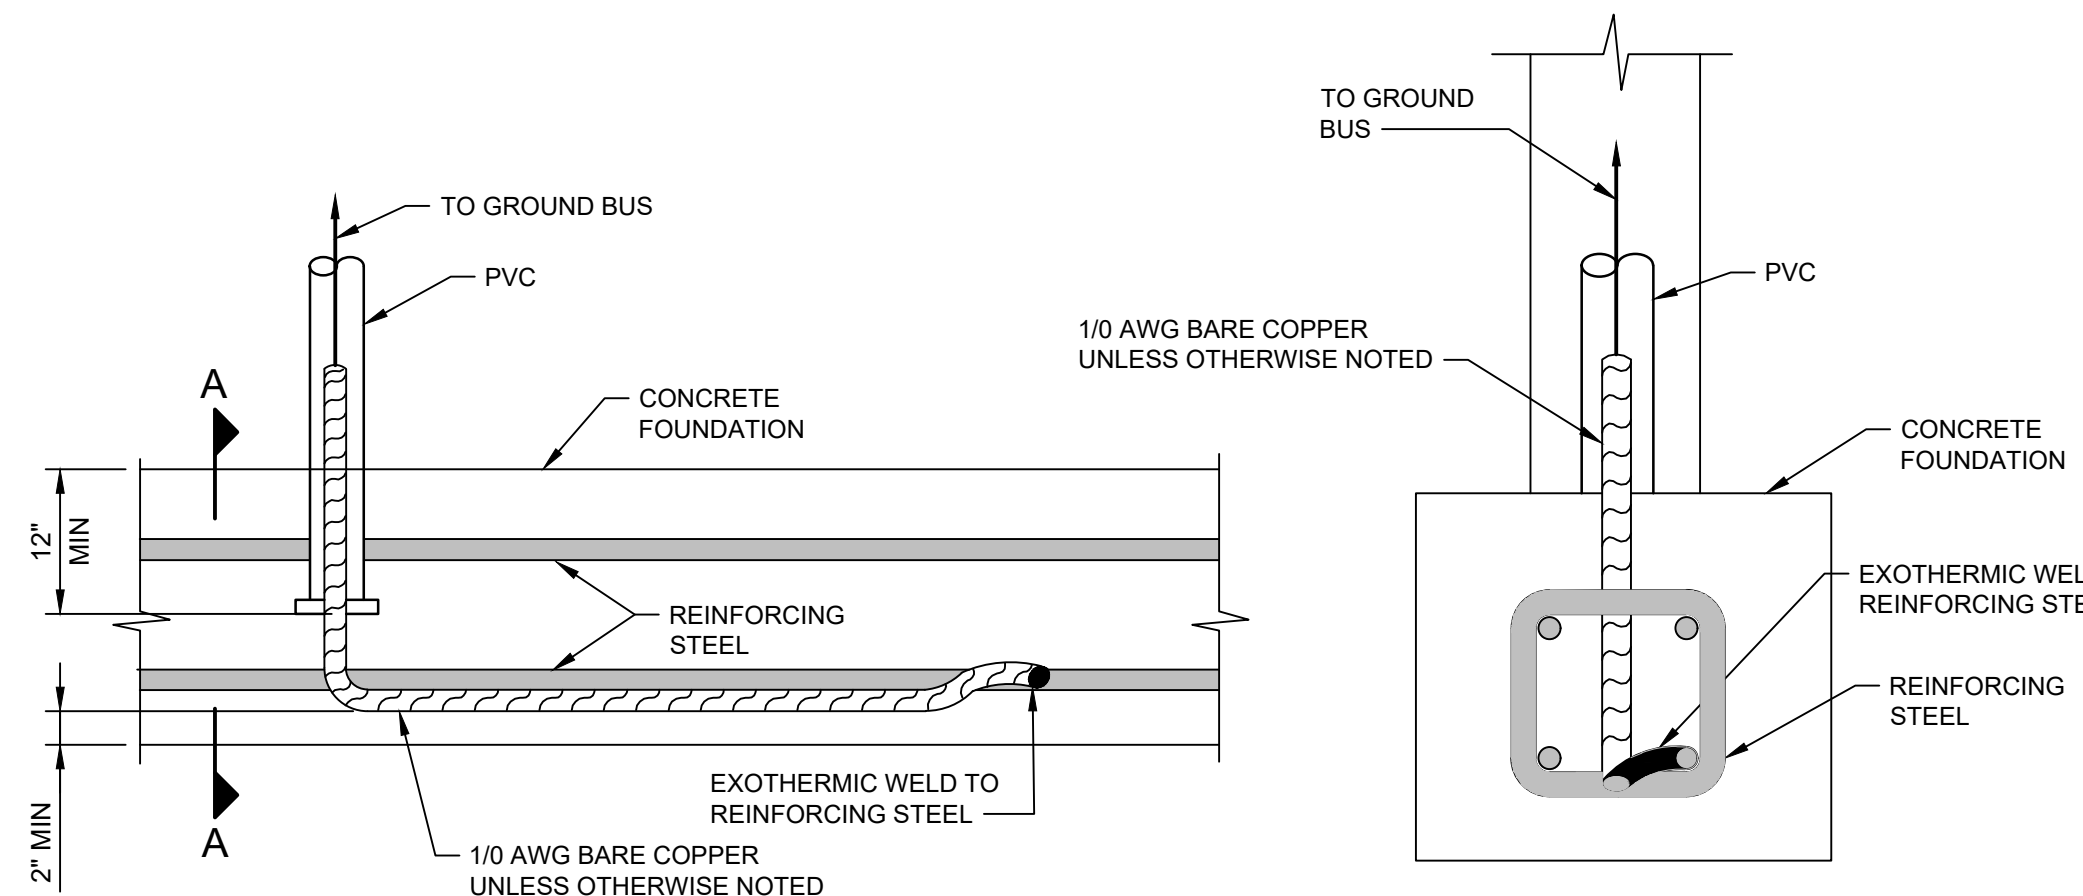5
06E101|01E402

SECTION A A


GROUNDING SYSTEM

NOT TO SCALE

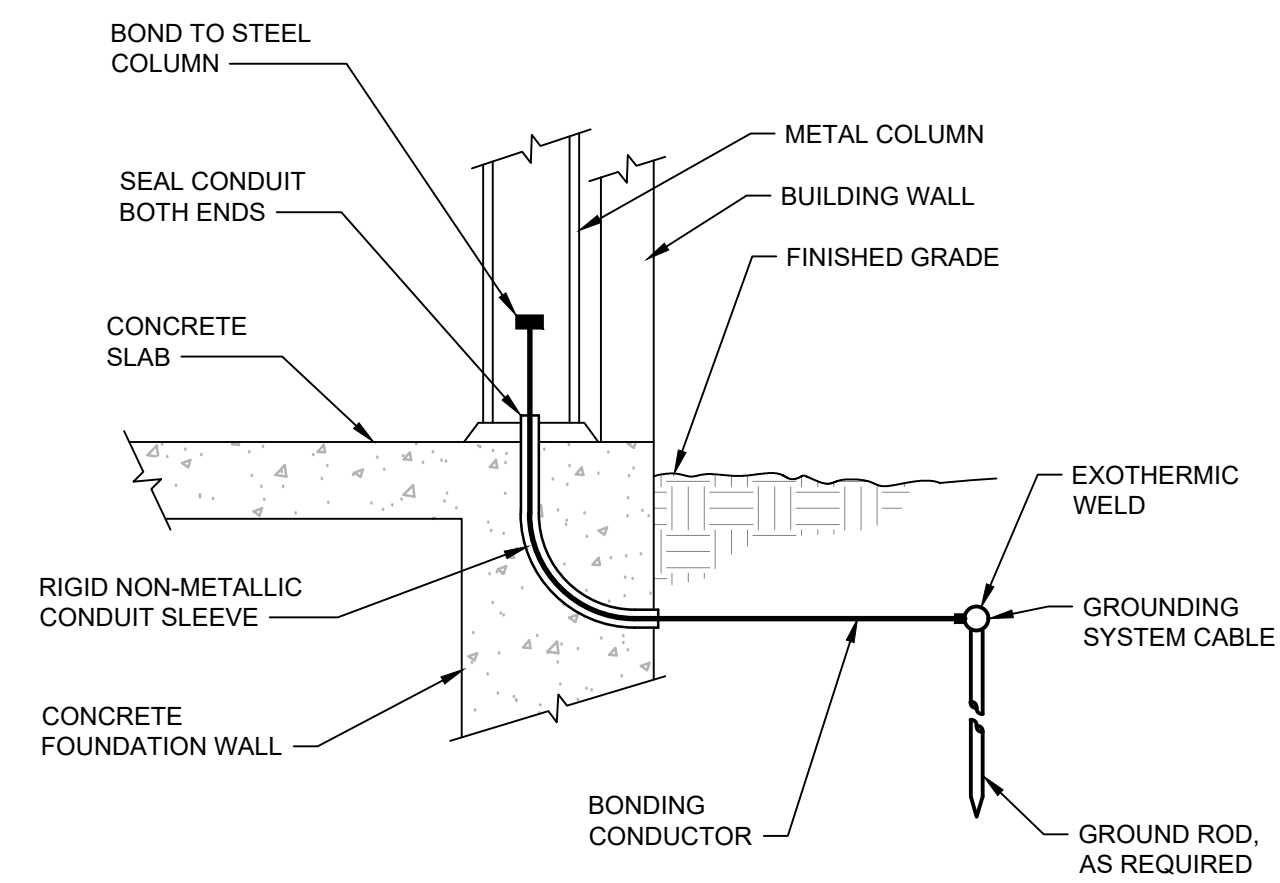6
01E402


COLUMN GROUND CONNECTION

NOT TO SCALE

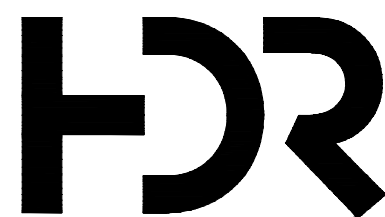7
15E101|01E402

ISSUE	DATE	DESCRIPTION

PROJECT MANAGER	ERIC ORTON P.E.
DESIGN BY	DB
DESIGN BY	
CHECKED BY	
DRAWN BY	EP
PLOT DATE	May 18, 2023
PROJECT NUMBER	10176455

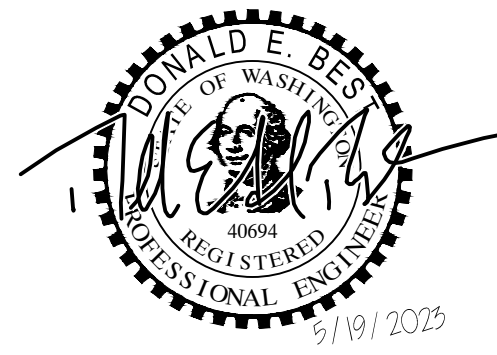

**KALAMA CREEK HATCHERY
PHASE 2**

**NATURAL RESOURCES DEPARTMENT
NISQUALLY INDIAN TRIBE**





EDA AWARD NUMBER 07-79-07880

**STANDARDS
ELECTRICAL DETAILS 2**




FILENAME | 01E402.DWG
SCALE | AS NOTED

SHEET
01E402

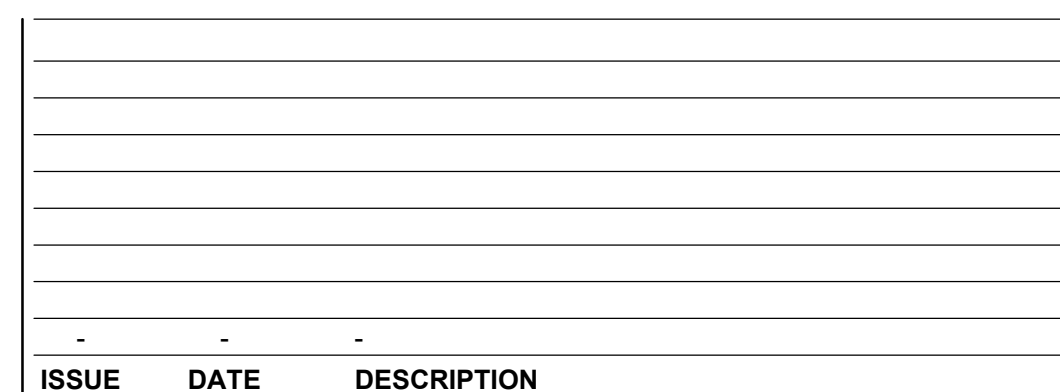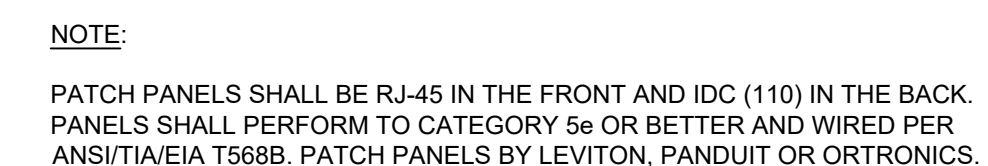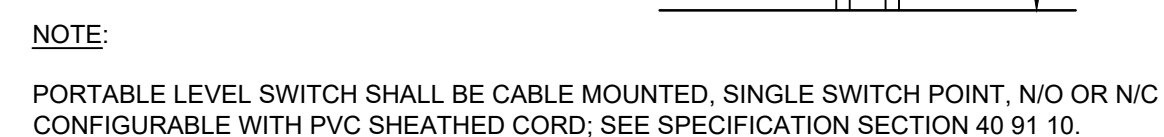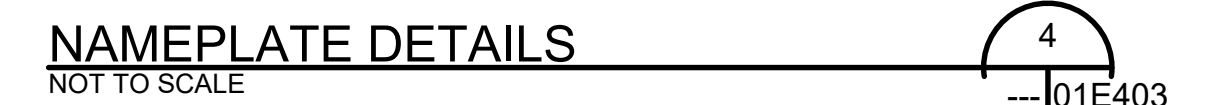


STANDARDS

ELECTRICAL DETAILS 3

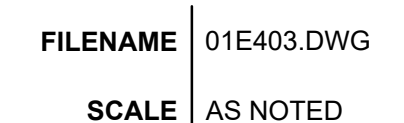


SHEET
01E403

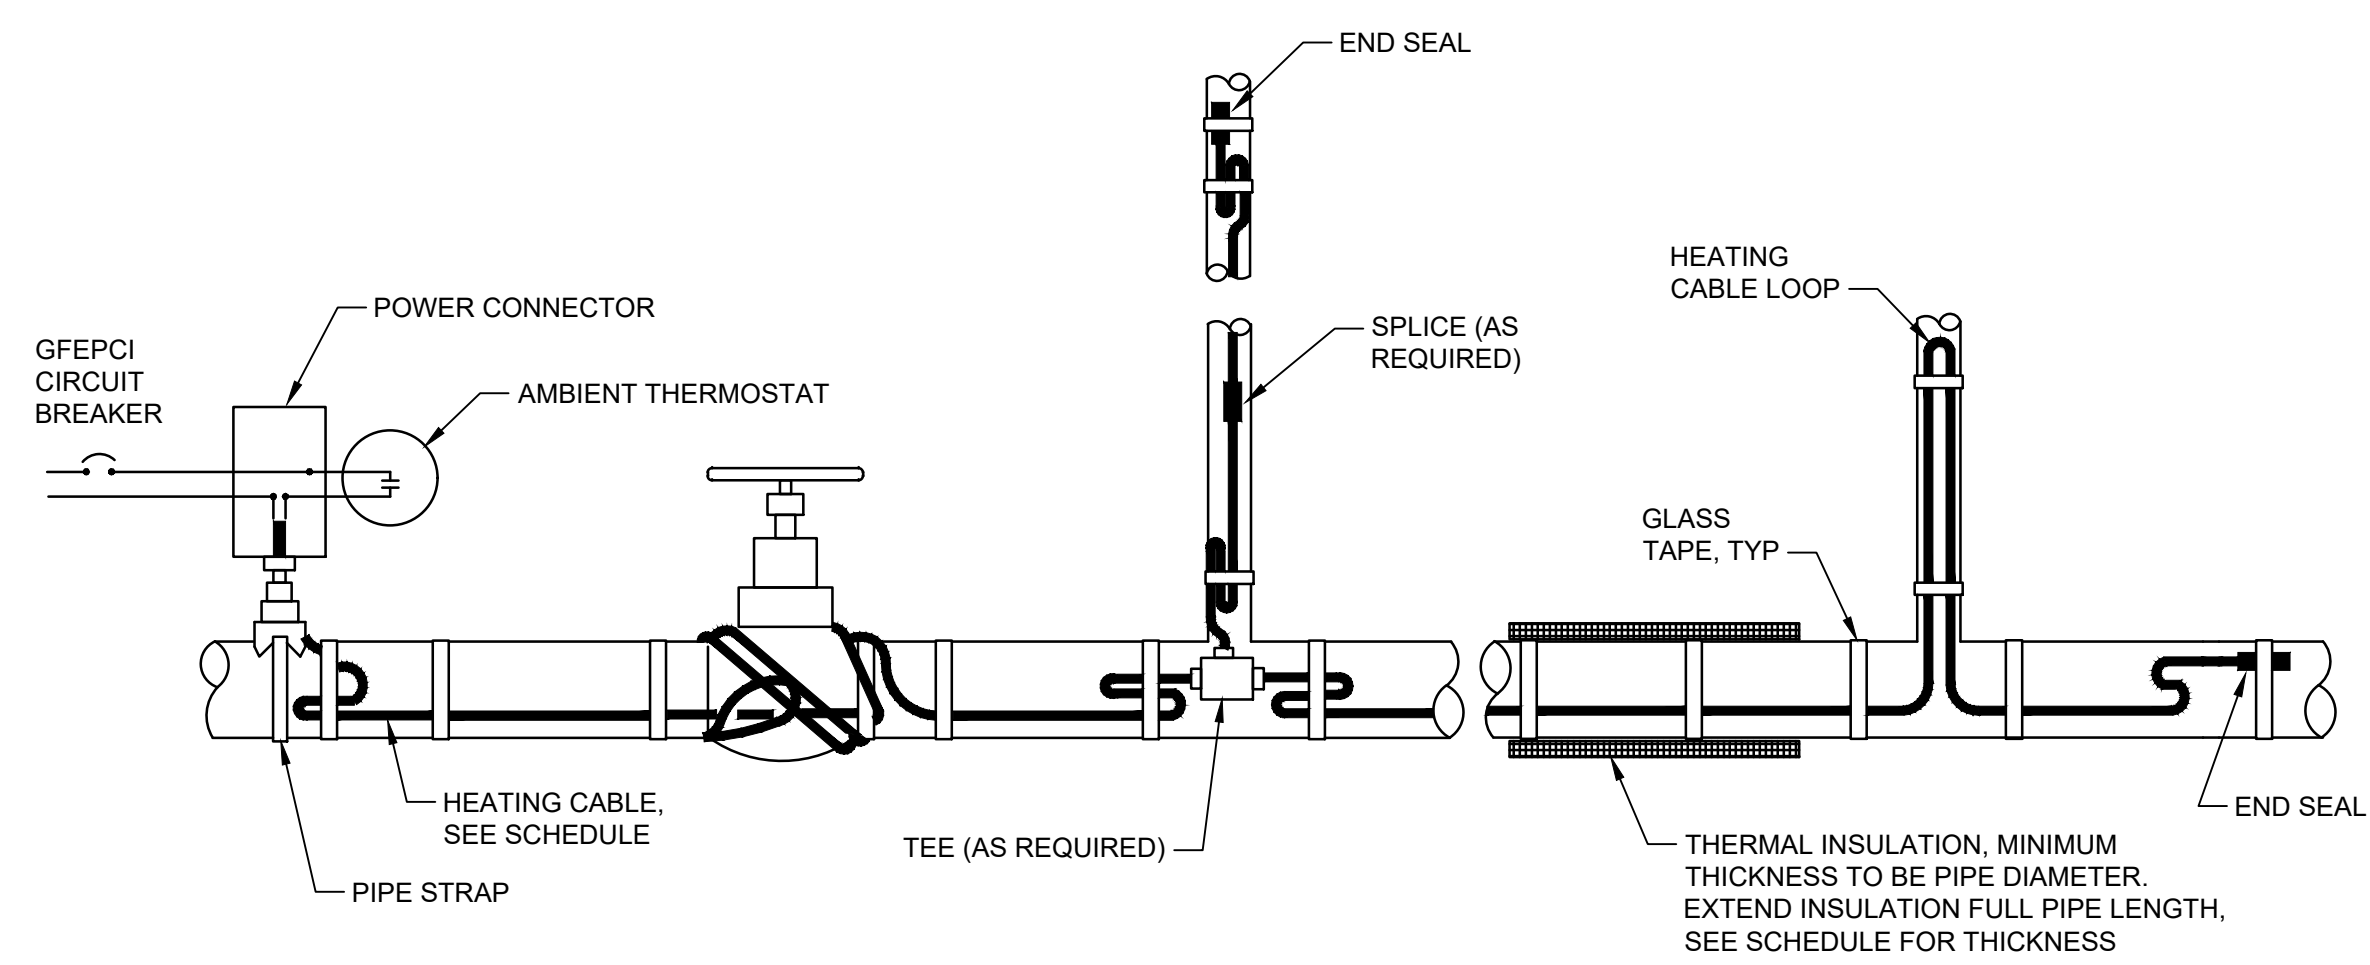


TYPICAL HEAT TRACE SYSTEM
NOT TO SCALE
09E101,15E103,16E101|01E404


PIPE INSULATION AND HEAT TRACE SCHEDULE		
NOMINAL PIPE DIAMETER (IN)	INSULATION THICKNESS (IN)	EXPOSED PIPE HEAT TRACE* (WATTS/ FOOT)
1/2"	1/2"	2.5
3/4"	1/2"	3
1"	1/2"	3.5
1 1/2"	1/2"	4.5
2"	1/2"	5
2 1/2"	1/2"	6
3"	1/2"	7.5
3 1/2"	1/2"	8.5
4"	1/2"	9.5
6"	1"	7.5
8"	1"	9
10"	1"	11

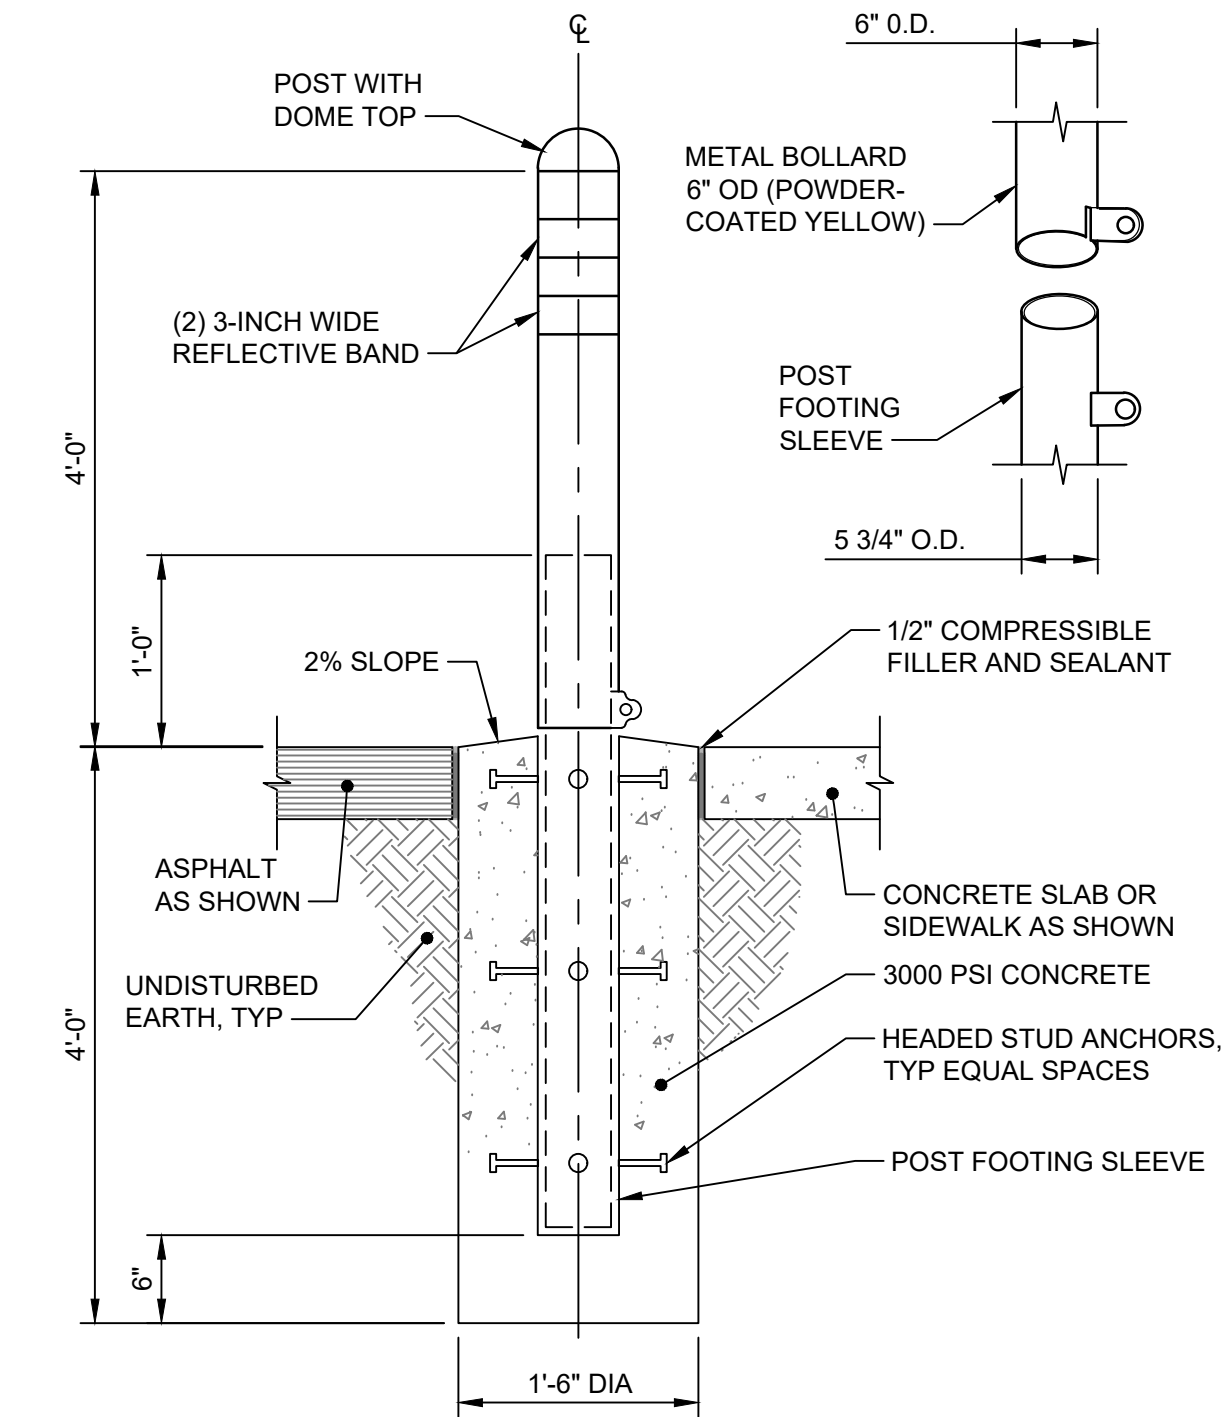


REMOVABLE BOLLARD
NOT TO SCALE
04E101|01E404

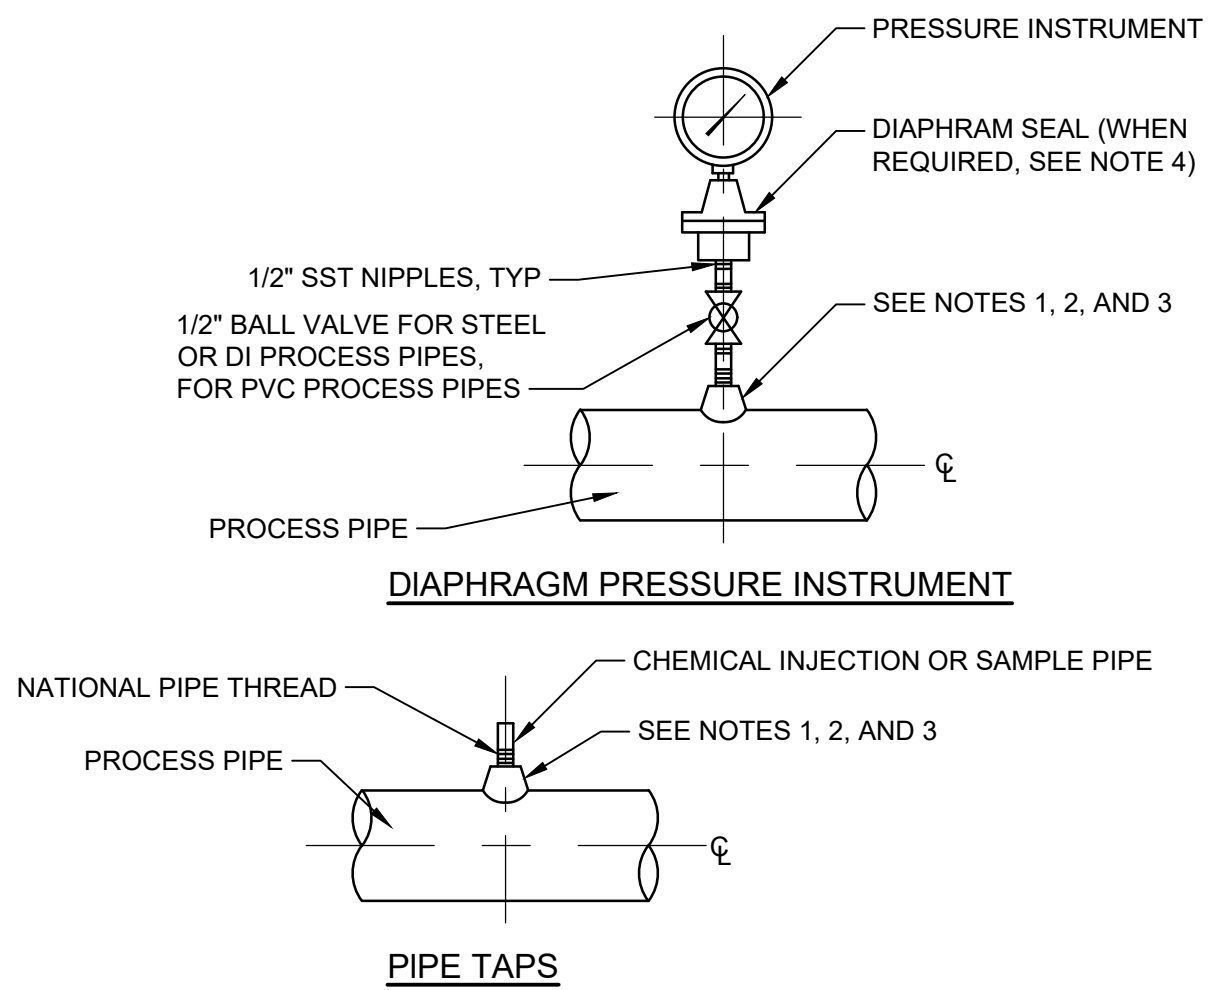


NOTES:
1. FOR STEEL, GALVANIZED STEEL AND PVC 2 1/2" AND SMALLER USE A BUSHING IN A TEE.
2. FOR DUCTILE IRON, ALL SIZES, USE PIPE SADDLE WITH BUSHING.
3. FOR STEEL AND STAINLESS STEEL PIPES 3" AND LARGER, AND PRESSURE VESSELS, USE THRED-O-LET AS SHOWN.
4. USE DIAPHRAGM SEAL ON ALL SERVICES EXCEPT AIR, POTABLE WATER, & NON-POTABLE WATER. USE IN-LINE DIAPHRAGM FOR SLUDGE SERVICES. SEE STANDARD DETAIL 13442-31.
5. PROVIDE SNUBBER FOR POSITIVE DISPLACEMENT PUMP APPLICATIONS.
6. NOT ALL REQUIRED COMPONENTS OR CONNECTIONS SHOWN; SEE SPECIFICATION SECTION .
PRESSURE INSTRUMENT APPLICATIONS
NOT TO SCALE
04E101, 15E103|01E404

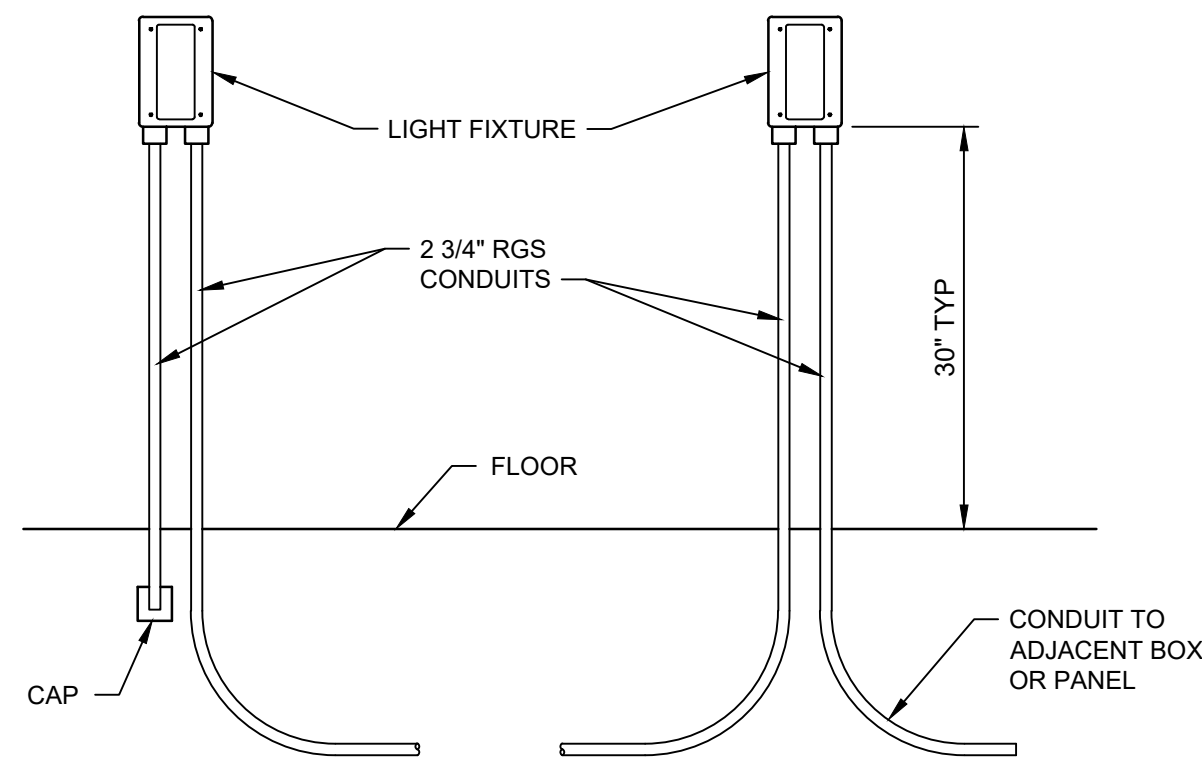

STUMBLE (STEP) LIGHTING MOUNTING DETAIL
NOT TO SCALE
04E105|01E404

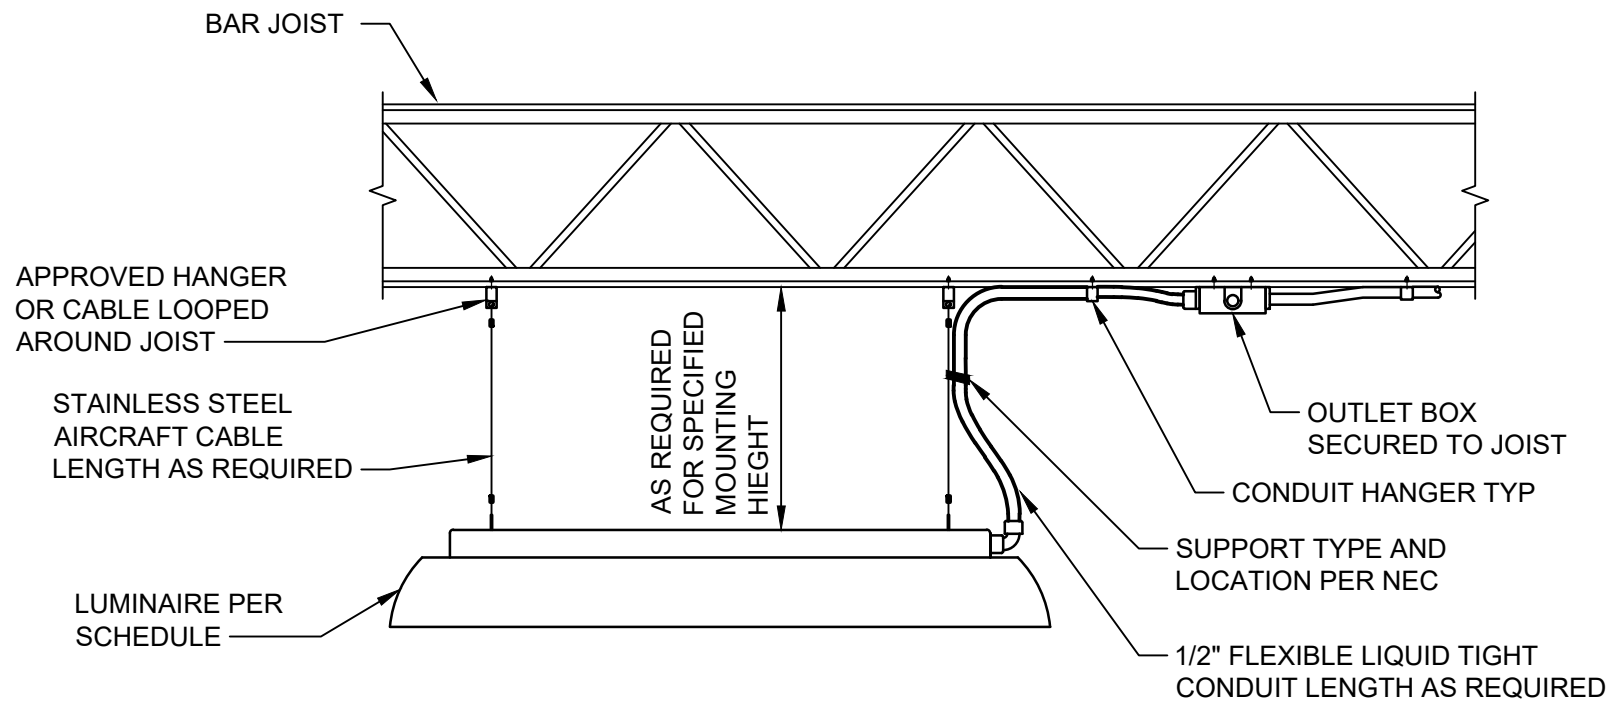

LUMINAIRE MOUNTING DETAIL
NOT TO SCALE
04E105|01E404

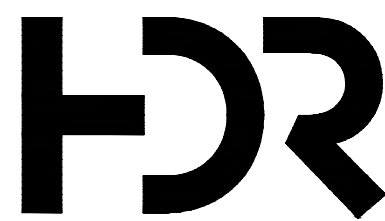

ISSUE	DATE	DESCRIPTION

PROJECT MANAGER	ERIC ORTON P.E.
DESIGN BY	DB
DESIGN BY	
CHECKED BY	
DRAWN BY	EP
PLOT DATE	May 18, 2023
PROJECT NUMBER	10176455




KALAMA CREEK HATCHERY
PHASE 2
NATURAL RESOURCES DEPARTMENT
NISQUALLY INDIAN TRIBE
EDA AWARD NUMBER 07-79-07880

STANDARDS
ELECTRICAL DETAILS 4



FILENAME | 01E404.DWG
SCALE | AS NOTED

SHEET
01E404

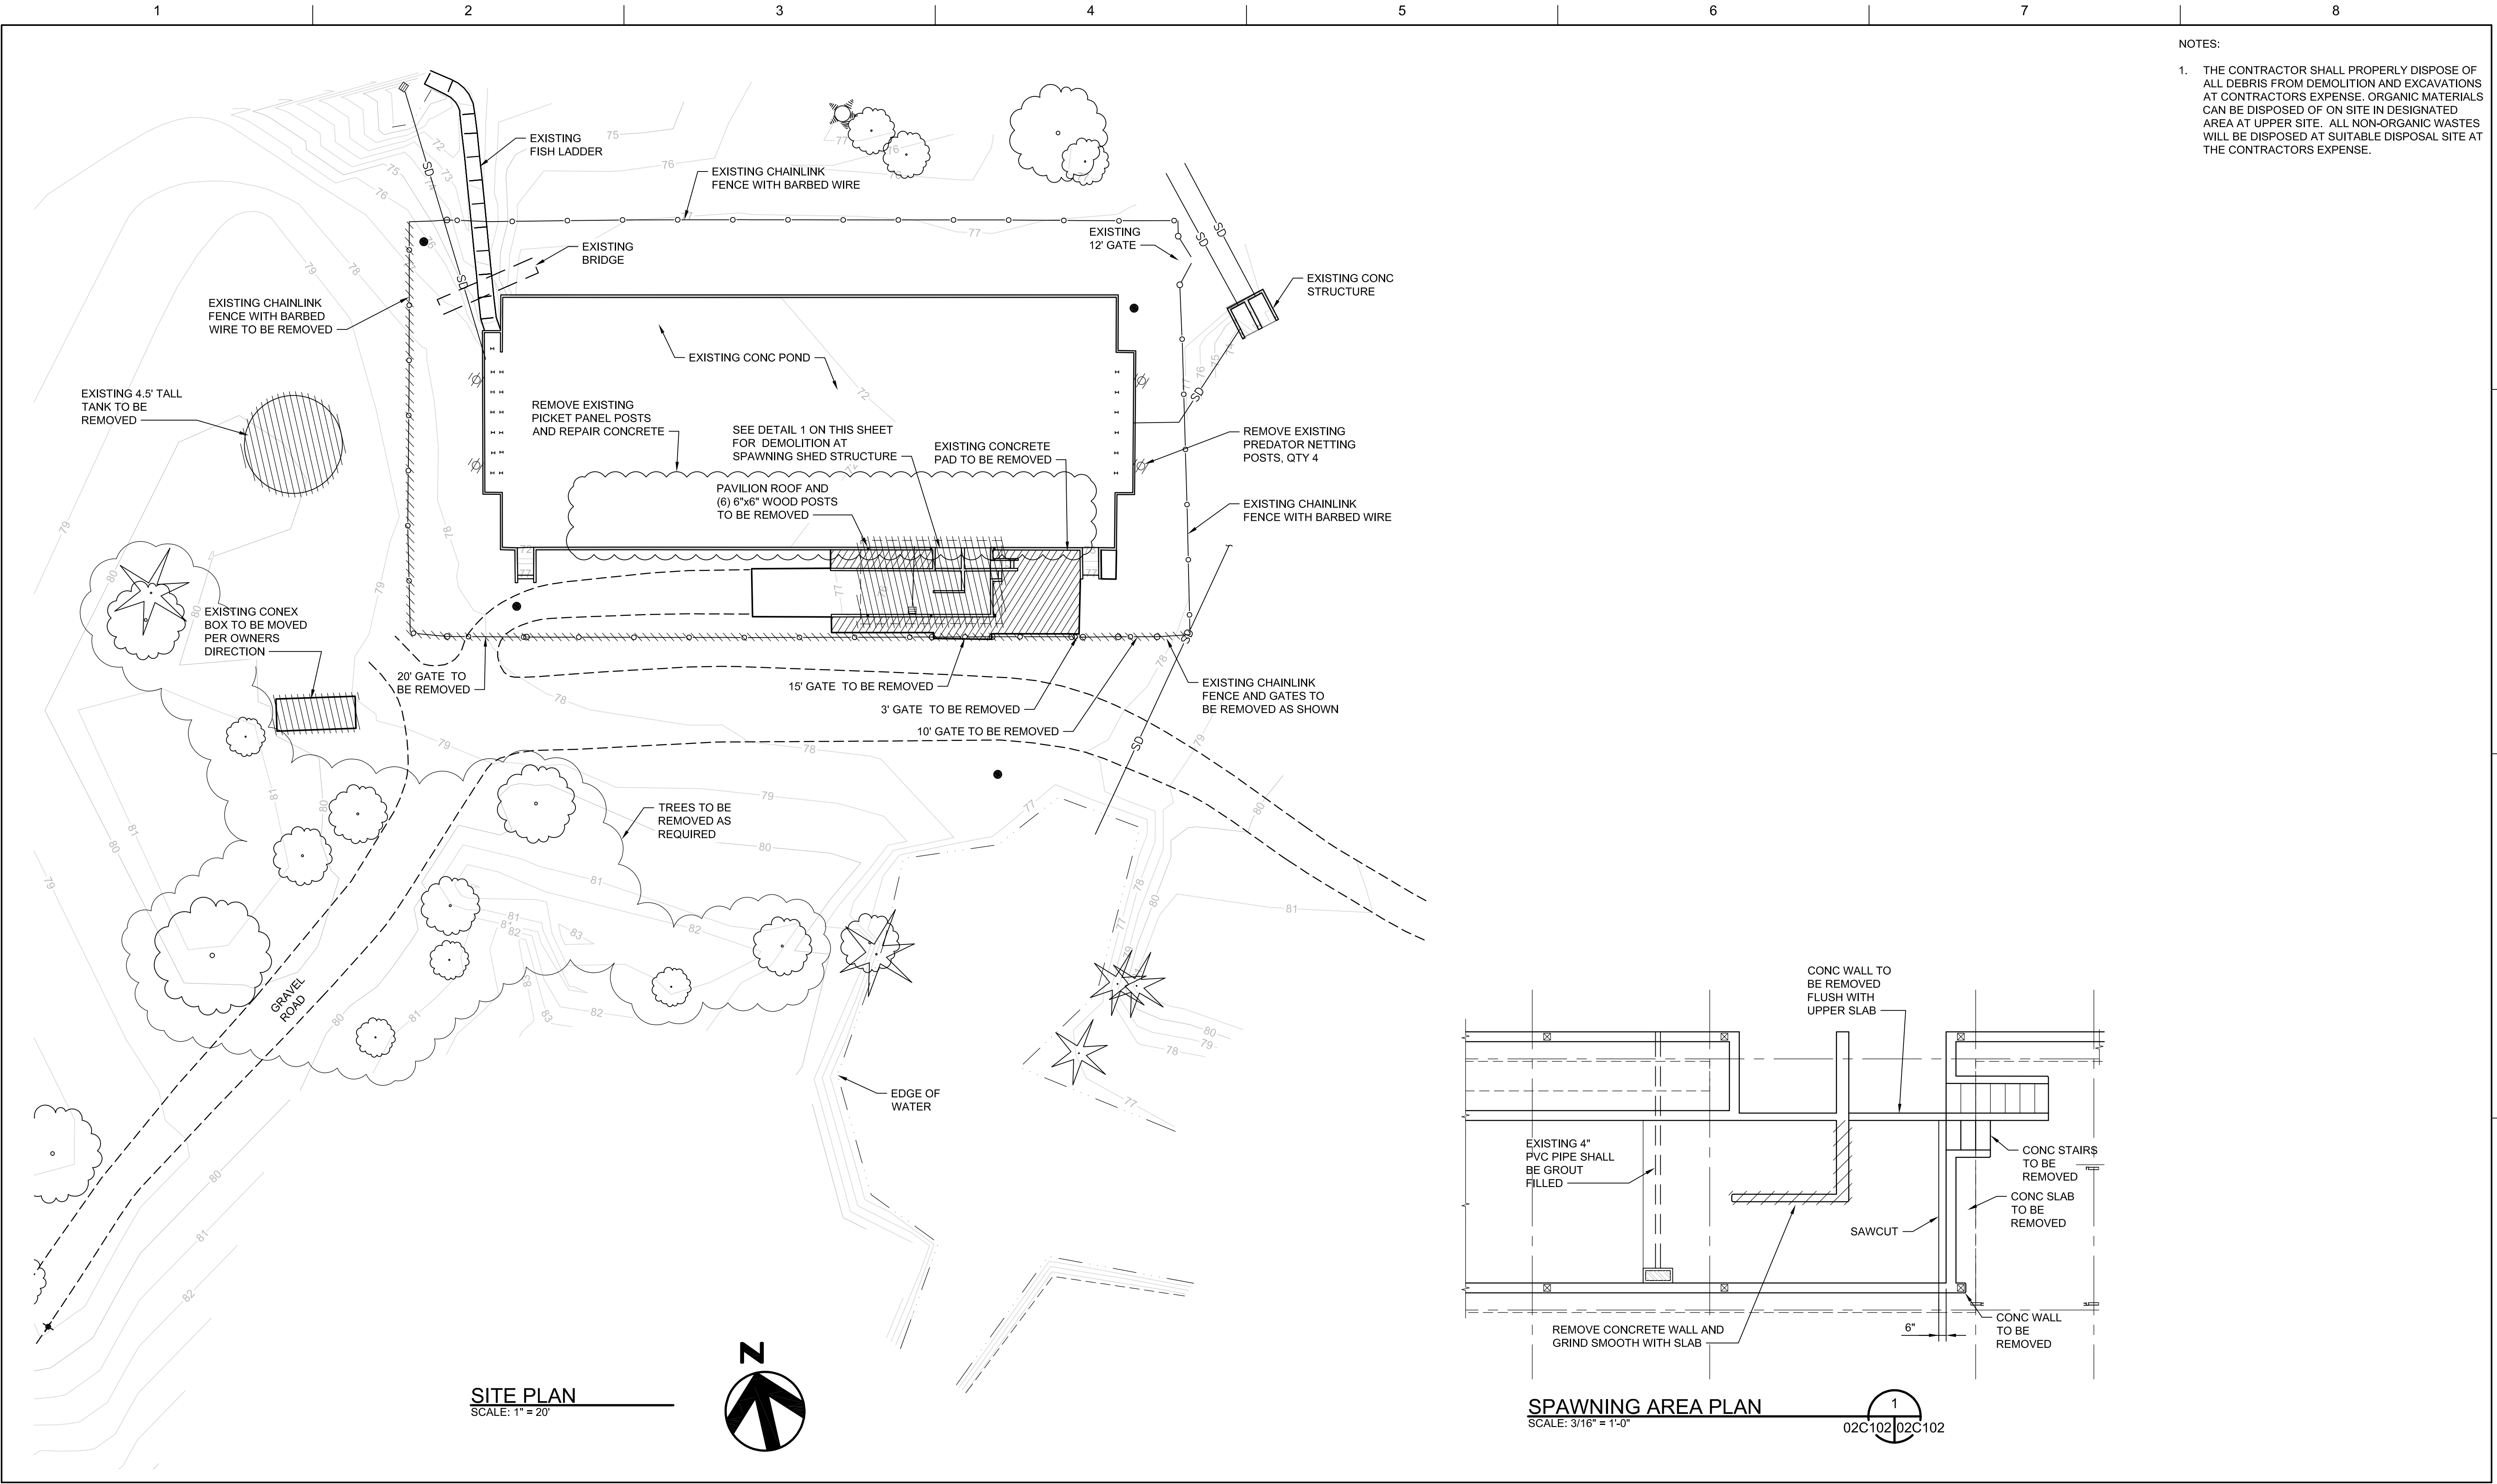

ISSUE	DATE	DESCRIPTION

PROJECT MANAGER	ERIC ORTON P.E.
DESIGN BY	
DESIGN BY	
CHECKED BY	
DRAWN BY	JLC
PLOT DATE	May 18, 2023
PROJECT NUMBER	10176455




5/19/2023

**KALAMA CREEK HATCHERY
PHASE 2**

**NATURAL RESOURCES DEPARTMENT
NISQUALLY INDIAN TRIBE**

EDA AWARD NUMBER 07-79-07880


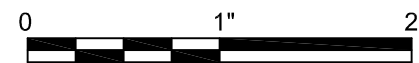


**DEMOLITION
LOWER SITE
PLAN**

FILENAME 02C102.DWG

SCALE AS NOTED

SHEET
02C102

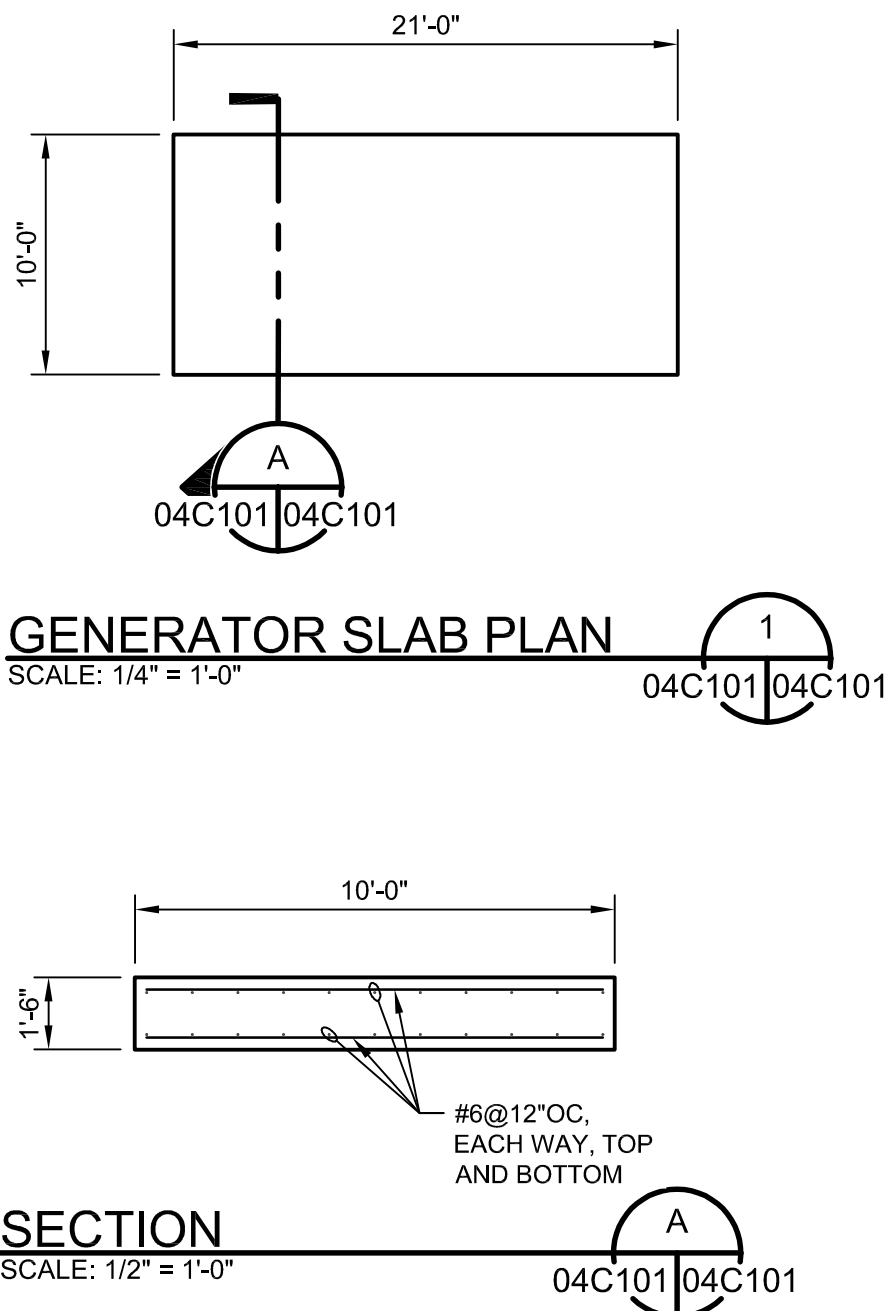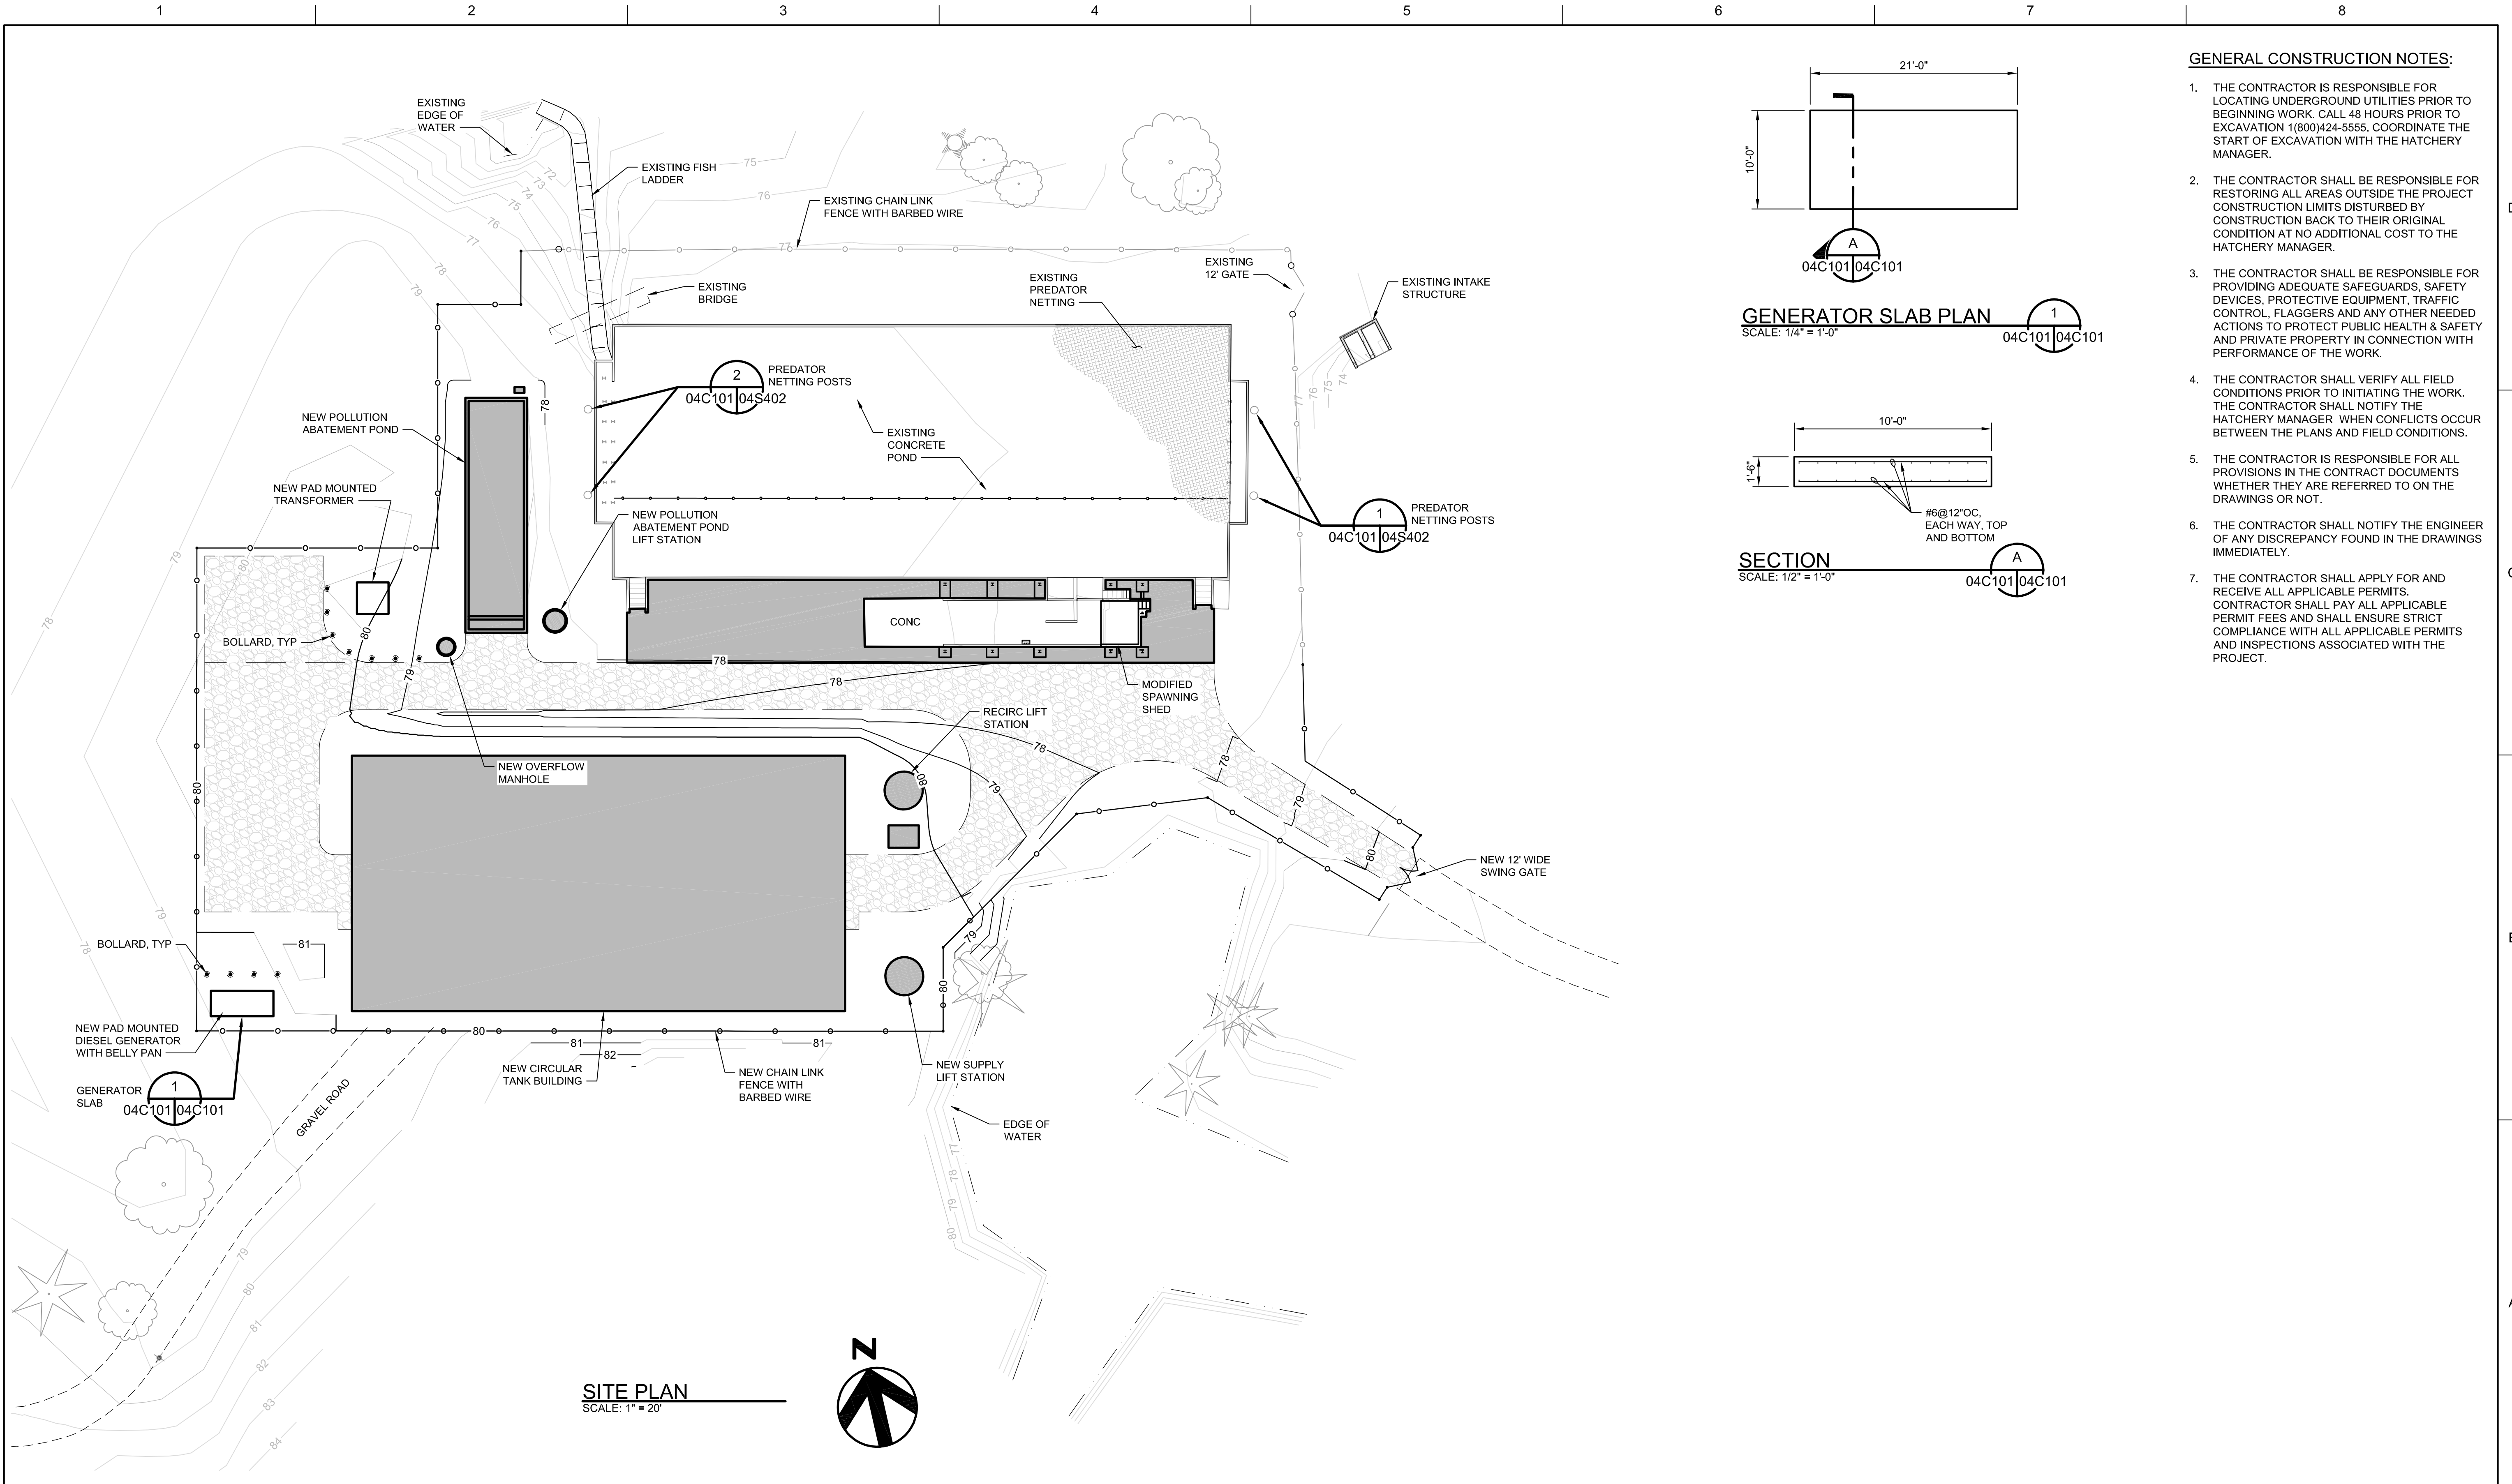

GENERAL CONSTRUCTION NOTES:

1. THE CONTRACTOR IS RESPONSIBLE FOR LOCATING UNDERGROUND UTILITIES PRIOR TO BEGINNING WORK. CALL 48 HOURS PRIOR TO EXCAVATION 1(800)424-5555. COORDINATE THE START OF EXCAVATION WITH THE HATCHERY MANAGER.
2. THE CONTRACTOR SHALL BE RESPONSIBLE FOR RESTORING ALL AREAS OUTSIDE THE PROJECT CONSTRUCTION LIMITS DISTURBED BY CONSTRUCTION BACK TO THEIR ORIGINAL CONDITION AT NO ADDITIONAL COST TO THE HATCHERY MANAGER.
3. THE CONTRACTOR SHALL BE RESPONSIBLE FOR PROVIDING ADEQUATE SAFEGUARDS, SAFETY DEVICES, PROTECTIVE EQUIPMENT, TRAFFIC CONTROL, FLAGGERS AND ANY OTHER NEEDED ACTIONS TO PROTECT PUBLIC HEALTH & SAFETY AND PRIVATE PROPERTY IN CONNECTION WITH PERFORMANCE OF THE WORK.
4. THE CONTRACTOR SHALL VERIFY ALL FIELD CONDITIONS PRIOR TO INITIATING THE WORK. THE CONTRACTOR SHALL NOTIFY THE HATCHERY MANAGER WHEN CONFLICTS OCCUR BETWEEN THE PLANS AND FIELD CONDITIONS.
5. THE CONTRACTOR IS RESPONSIBLE FOR ALL PROVISIONS IN THE CONTRACT DOCUMENTS WHETHER THEY ARE REFERRED TO ON THE DRAWINGS OR NOT.
6. THE CONTRACTOR SHALL NOTIFY THE ENGINEER OF ANY DISCREPANCY FOUND IN THE DRAWINGS IMMEDIATELY.
7. THE CONTRACTOR SHALL APPLY FOR AND RECEIVE ALL APPLICABLE PERMITS. CONTRACTOR SHALL PAY ALL APPLICABLE PERMIT FEES AND SHALL ENSURE STRICT COMPLIANCE WITH ALL APPLICABLE PERMITS AND INSPECTIONS ASSOCIATED WITH THE PROJECT.



ISSUE	DATE	DESCRIPTION

PROJECT MANAGER ERIC ORTON P.E.	
DESIGN BY	JDN
DESIGN BY	JLH
CHECKED BY	
DRAWN BY	ACB
PLOT DATE	May 18, 2023
PROJECT NUMBER	10176455



KALAMA CREEK HATCHERY
PHASE 2
NATURAL RESOURCES DEPARTMENT
NISQUALLY INDIAN TRIBE
EDA AWARD NUMBER 07-79-07880




LOWER SITE
OVERALL
SITE PLAN

FILENAME	04C101.DWG
SCALE	AS NOTED

SHEET
04C101



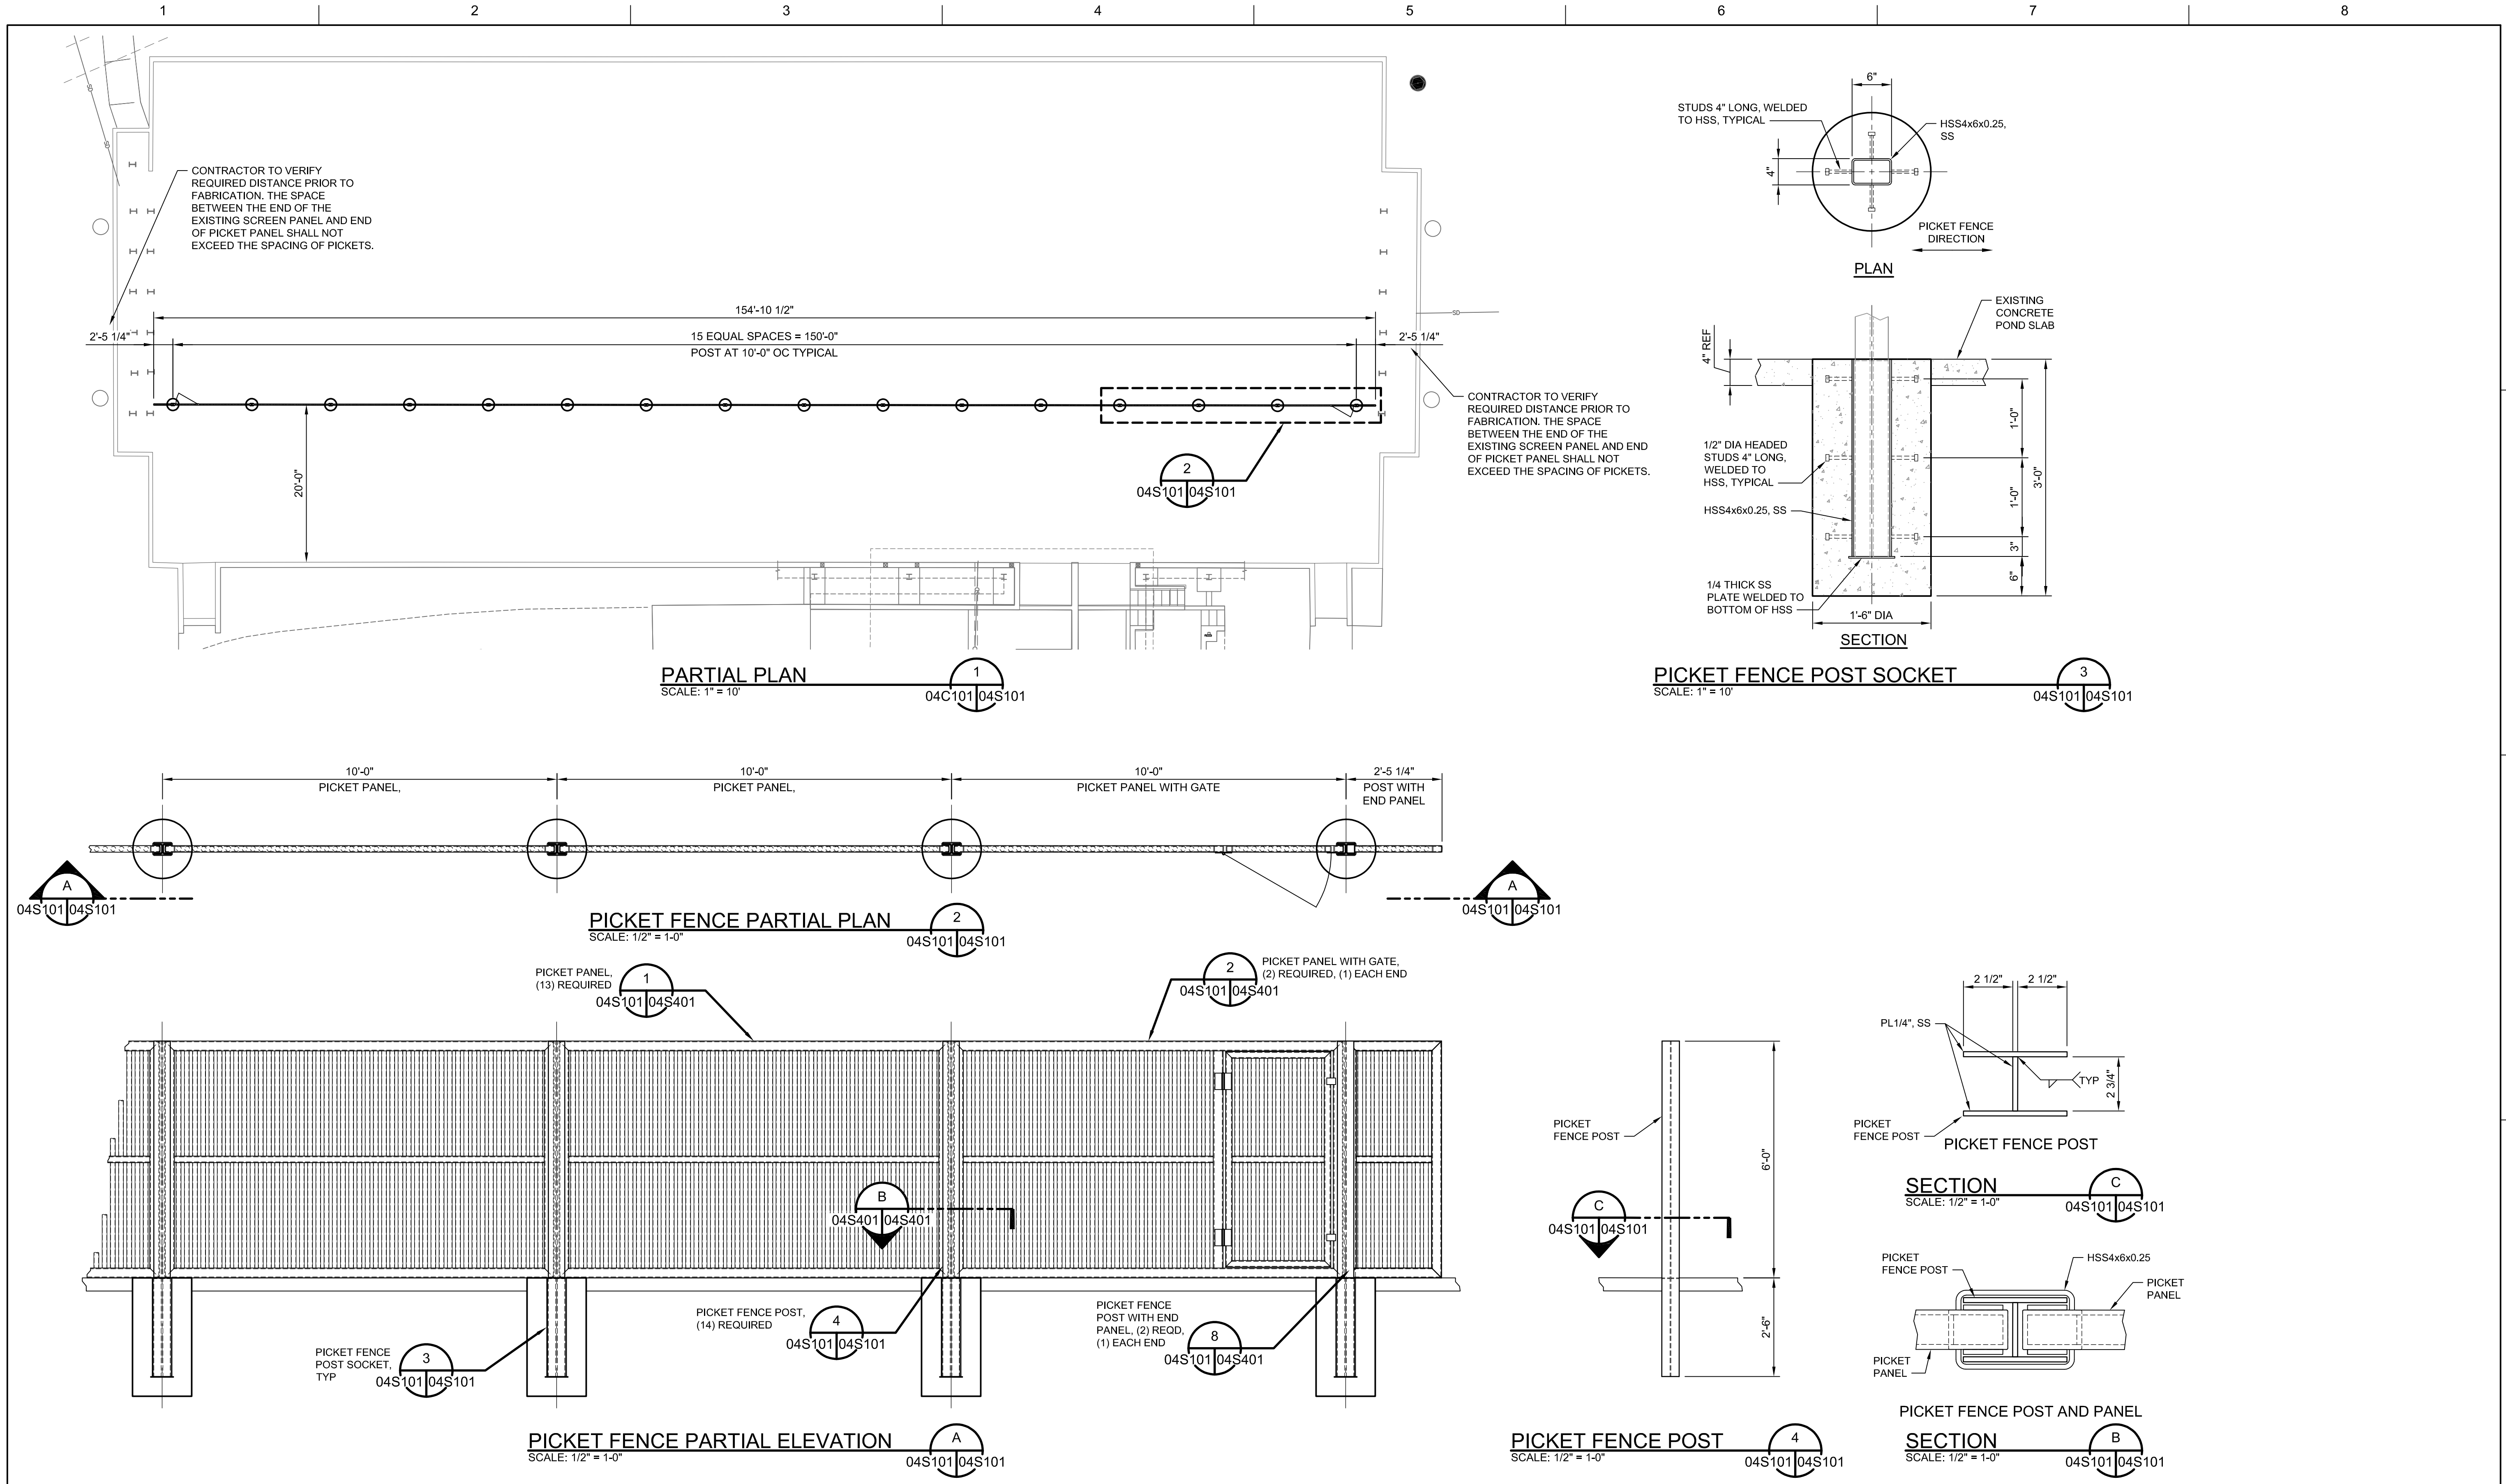

ISSUE	DATE	DESCRIPTION

PROJECT MANAGER	ERIC ORTON, P.E.
DESIGN BY	JLH
DESIGN BY	
CHECKED BY	
DRAWN BY	ACB
PLOT DATE	May 18, 2023
PROJECT NUMBER	10176455



**KALAMA CREEK HATCHERY
PHASE 2**

**NATURAL RESOURCES DEPARTMENT
NISQUALLY INDIAN TRIBE**

EDA AWARD NUMBER 07-79-07880


LOWER SITE

**PICKET PANEL FENCE
PLAN, SECTIONS AND DETAILS**


0 1" 2"

FILENAME 04S101.DWG
SCALE AS NOTED

SHEET
04S101

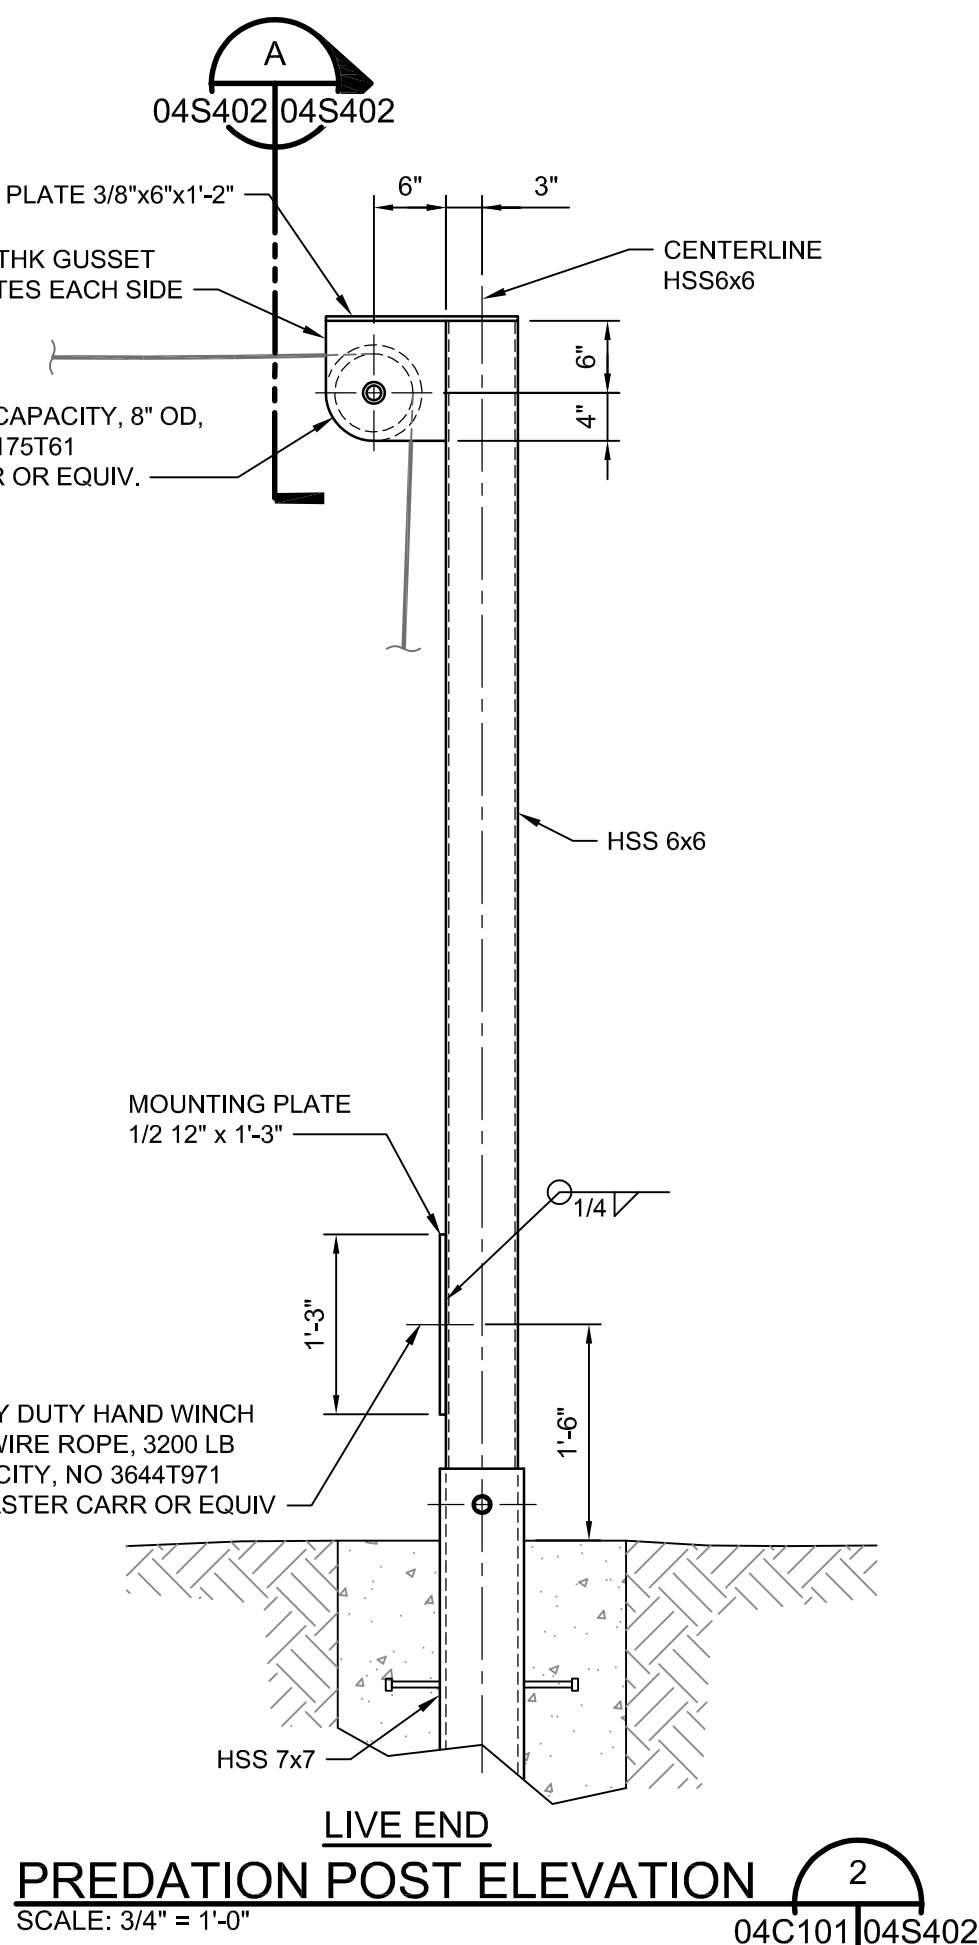

SHEET
04S402

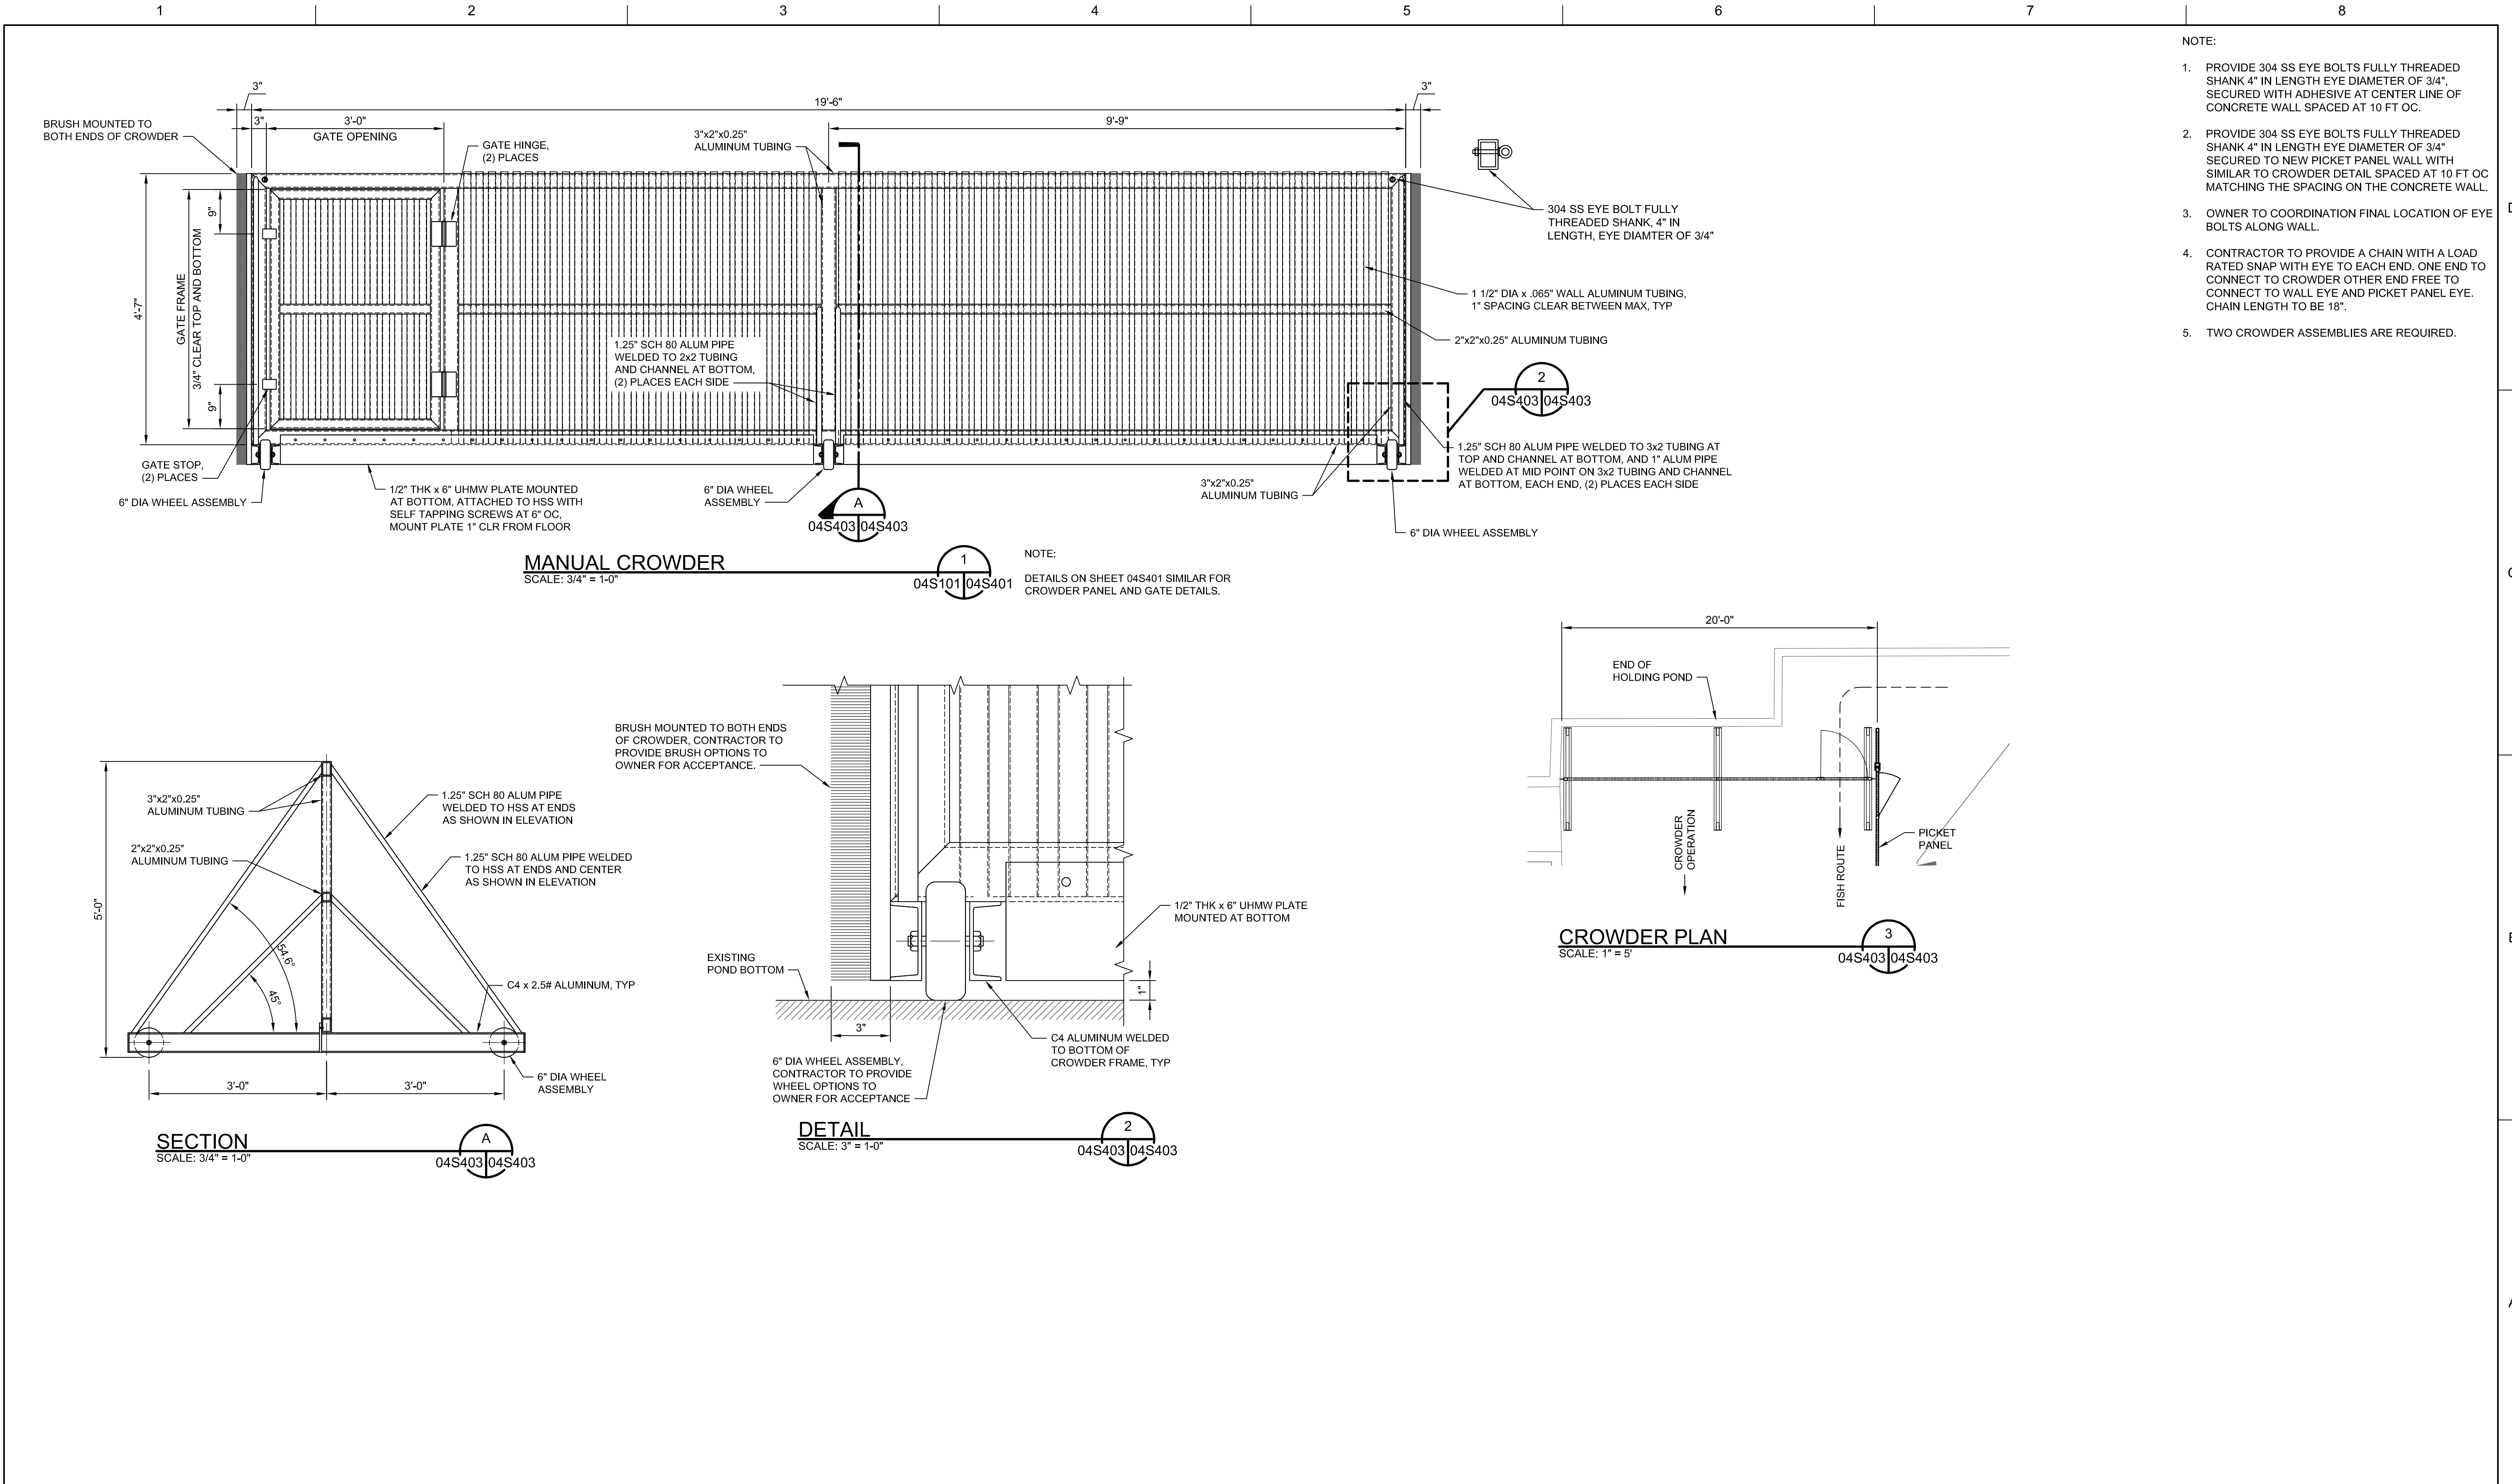

ISSUE	DATE	DESCRIPTION

PROJECT MANAGER ERIC ORTON P.E.

DESIGN BY	JLH
DESIGN BY	
CHECKED BY	
DRAWN BY	ACB
PLOT DATE	May 18, 2023
PROJECT NUMBER	10176455



5-19-2023

**KALAMA CREEK HATCHERY
PHASE 2**
**NATURAL RESOURCES DEPARTMENT
NISQUALLY INDIAN TRIBE**
EDA AWARD NUMBER 07-79-07880

**LOWER SITE
CROWDER
SECTIONS AND DETAILS**



FILENAME 04S403.DWG
SCALE AS NOTED


SHEET
04S403

ELECTRICAL HANDHOLE SCHEDULE - LOWER SITE			
HANDHOLE TAG NUMBER	TYPE	MIN. INSIDE DIMENSIONS (L, W, D)	NOTES
EHH-201	POWER/CONTROL	3'-6", 3'-6", 3'-2"	1
EHH-202	POWER/CONTROL	3'-0", 2'-0", 2'-8"	1
EHH-203	POWER/CONTROL	3'-6", 3'-6", 3'-2"	1
CHH-201	TELEPHONE	2'-5", 1'-5", 1'-9"	2

NOTES:

1. TOP WITH PADLOCKABLE (RECESSED PADLOCK HASP), H-20 RATED, SPRING ASSISTED, GALVANIZED, DIAMOND PLATE DOOR. DOOR SHALL BE CASTED WITH THE LEGEND OF THE HANDHOLE TAG NUMBER.
2. HIGH DENSITY POLYMER CONCRETE JUNCTION BOX WITH BOLT DOWN COVER, TIER 15 - 20K

DUCTBANK SCHEDULE - LOWER SITE						
TAG	TYPE	CONDUITS	CONDUCTORS (AWG OR KCMIL)	ORIGIN	DESTINATION	NOTES/DESCRIPTION
P201	POWER	2 SETS OF 3" C	4#3/0 & #1/0 GRD IN EACH	UTILITY XFMR	CT CABINET	SERVICE CONDUCTORS; SECONDARY
P202	POWER	2 SETS OF 3" C 3" C 2" C 2" C 1" C 1" C	4#3/0 IN EACH 4#300 & #4 GRD 12#14 CONTROL CABLE 12#14 CONTROL CABLE 4#10 & #10 GRD PULL ROPE	ATS ATS ATS ATS RCPT STUB UP	EHH-201 EHH-201 EHH-201 EHH-201 EHH-201 EHH-201	MDP201 FEEDER STANDBY POWER ATS CONTROL/ALARM SIGNALS GENSET CONTROL/ALARM SIGNALS CONVENIENCE RECEPTACLE SPARE CONDUIT
P203	POWER & CONTROL SIGNALS	3" C 3" C 2" C 1" C 1" C 1" C 1" C	4#300 & #4 GRD PULL ROPE 12#14 CONTROL CABLE 2#8 & #10 GRD 2#10 & #10 GRD 2#10 & #10 GRD PULL ROPE	GENSET GENSET GENSET GENSET GENSET GENSET GENSET	EHH-201 EHH-201 EHH-201 EHH-201 EHH-201 EHH-201 EHH-201	STANDBY POWER SPARE CONDUIT GENSET CONTROL/ALARM SIGNALS GENSET HEATER BATTERY CHARGER CONVENIENCE RECEPTACLE SPARE CONDUIT
P204	POWER & CONTROL SIGNALS	2 SETS OF 3" C 3" C 2 SETS OF 2" C 2" C 1" C 1" C 1" C 1" C	4#3/0 IN EACH & #2 GND IN EACH PULL ROPE 12#14 CONTROL CABLE IN EACH PULL ROPE 2#8 & #10 GRD 2#10 & #10 GRD 2#10 & #10 GRD PULL ROPE IN EACH	EHH-201 EHH-201 EHH-201 EHH-201 EHH-201 EHH-201 EHH-201 EHH-201	EHH-203 EHH-203 EHH-203 EHH-203 EHH-203 EHH-203 EHH-203 EHH-203	MDP201 FEEDER SPARE CONDUIT STATUS/ALARM MONITORING SPARE CONDUIT GENSET HEATER GENSET BATTERY CHARGER CONVENIENCE RECEPTACLES SPARE CONDUIT
P205	POWER & CONTROL SIGNALS	1" C 1" C 1" C 1" C 1" C 3 SETS OF 1" C	3#10 & #10 GRD 8#14 CONTROL CABLE 2#10 & #10 GRD 4#10 & #10 GRD 3#14 CONTROL CABLE PULL ROPE IN EACH	EHH-202 EHH-202 EHH-202 EHH-202 EHH-202 EHH-202	EHH-203 EHH-203 EHH-203 EHH-203 EHH-203 EHH-203	PA POND LIFT STATION FEEDER PA POND LIFT STATION ALARM HEAT TRACE CONVENIENCE RECEPTACLES CONC POND LEVEL SWITCH SPARE CONDUIT
P206	POWER	1 1/2" C 1" C	2#4 & #8 GRD PULL ROPE	PP-202 CAP	EHH-203 EHH-203	PACKAGE POWER SUPPLY FEEDER (PP202) SPARE CONDUIT
P207	POWER & CONTROL SIGNALS	2 SETS OF 3" C 3" C 2 SETS OF 2" C 2" C 1" C 1" C 1" C 1" C 1" C 1" C 1 1/2" C 2 SETS OF 1" C 6 SETS OF 1" C	4#3/0 IN EACH & #2 GND IN EACH PULL ROPE 12#14 CONTROL CABLE IN EACH PULL ROPE 2#8 & #10 GRD 2#10 & #10 GRD 3#10 & #10 GRD 8#14 CONTROL CABLE 2#10 & #10 GRD 3#14 CONTROL CABLE 2#8 & #10 GRD 2#10 & #10 GRD IN EACH PULL ROPE IN EACH	EHH-203 EHH-203 EHH-203 EHH-203 EHH-203 EHH-203 EHH-203 EHH-203 EHH-203 EHH-203 EHH-203 EHH-203 EHH-203	MDP201 MDP201 ACP201 ACP201 LP201 LP201 LP201 LP201 LP201 LP201 LP201 LP201 LP201	MDP201 FEEDER SPARE CONDUIT STATUS/ALARM MONITORING SPARE CONDUIT GENSET HEATER GENSET BATTERY CHARGER PA POND LIFT STATION FEEDER PA POND LIFT STATION ALARM PA POND HEAT TRACE CONC POND LEVEL SWITCH PACKAGE POWER SUPPLY FEEDER (PP202) CONVENIENCE RECEPTACLES SPARE CONDUITS
C201	COMMUNICATIONS	2" C 2" C	TELEPHONE CABLE PULL ROPE	TBD TBD	CHH-201 CHH-201	TELEPHONE SERVICE SPARE CONDUIT
C202	COMMUNICATIONS	2" C 2" C	TELEPHONE CABLE PULL ROPE	CHH-201 CHH-201	PEDESTAL PEDESTAL	TELEPHONE SERVICE SPARE CONDUIT
C203	COMMUNICATIONS	2" C 2" C	TELEPHONE CABLE PULL ROPE	PEDESTAL PEDESTAL	ACP201 ACP201	TELEPHONE SERVICE SPARE CONDUIT

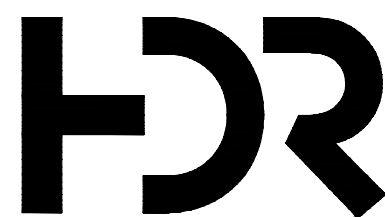
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**KALAMA CREEK HATCHERY
PHASE 2
NATURAL RESOURCES DEPARTMENT
NISQUALLY INDIAN TRIBE
EDA AWARD NUMBER 07-79-07880**

LOWER SITE


ELECTRICAL

HANDHOLE AND DUCTBANK SCHEDULES

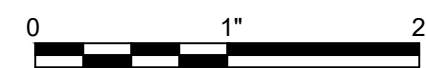


FILENAME	04E102.DWG
SCALE	AS NOTED

SHEET
04E102

KEYED NOTES: 

1. GFEP CI TYPE CIRCUIT BREAKER.
REFERENCE SPECIFICATION 40 41 13

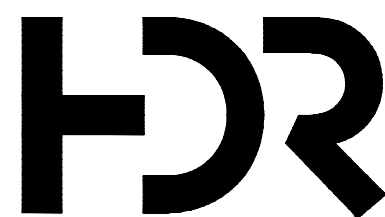[illegible]

PROJECT MANAGER	ERIC ORTON P.E.
DESIGN BY	DB
DESIGN BY	
CHECKED BY	
DRAWN BY	EP
PLOT DATE	May 18, 2023
PROJECT NUMBER	10176455




KALAMA CREEK HATCHERY PHASE 2

**NATURAL RESOURCES DEPARTMENT
NISQUALLY INDIAN TRIBE
EDA AWARD NUMBER 07-79-07880**



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ELECTRICAL SCHEDULES


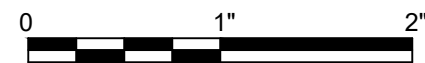


FILENAME	04E103.DWG
SCALE	AS NOTED

SHEET
04E103

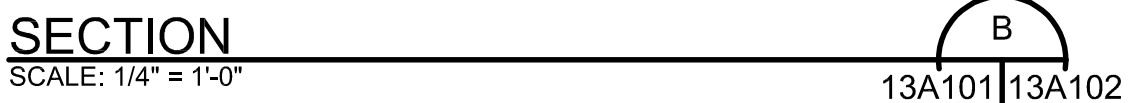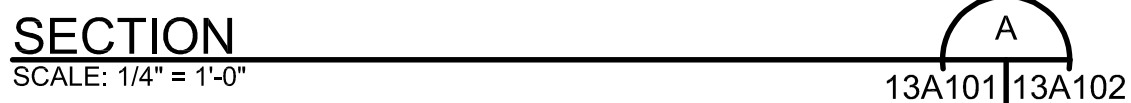


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ADULT HANDLING BUILDING

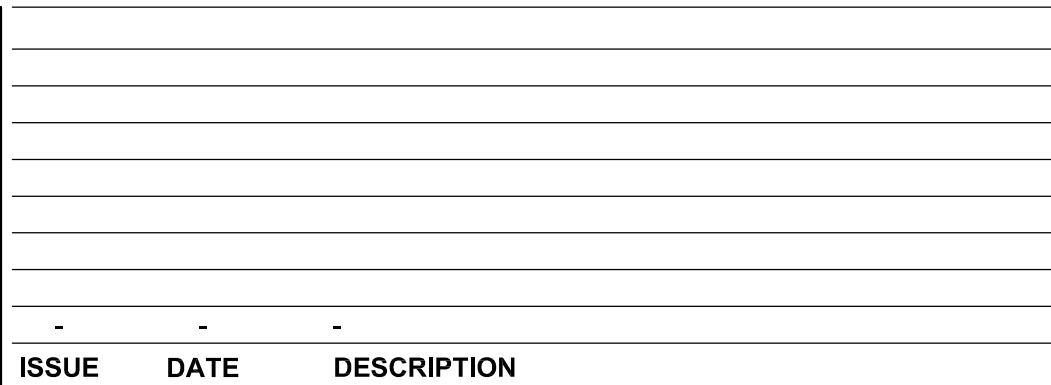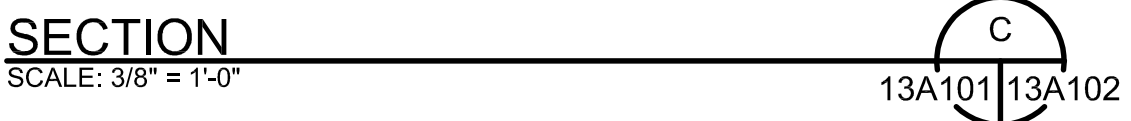FILENAME	13A102.DWG
SCALE	AS NOTED

SHEET
13A102



ISSUE	DATE	DESCRIPTION

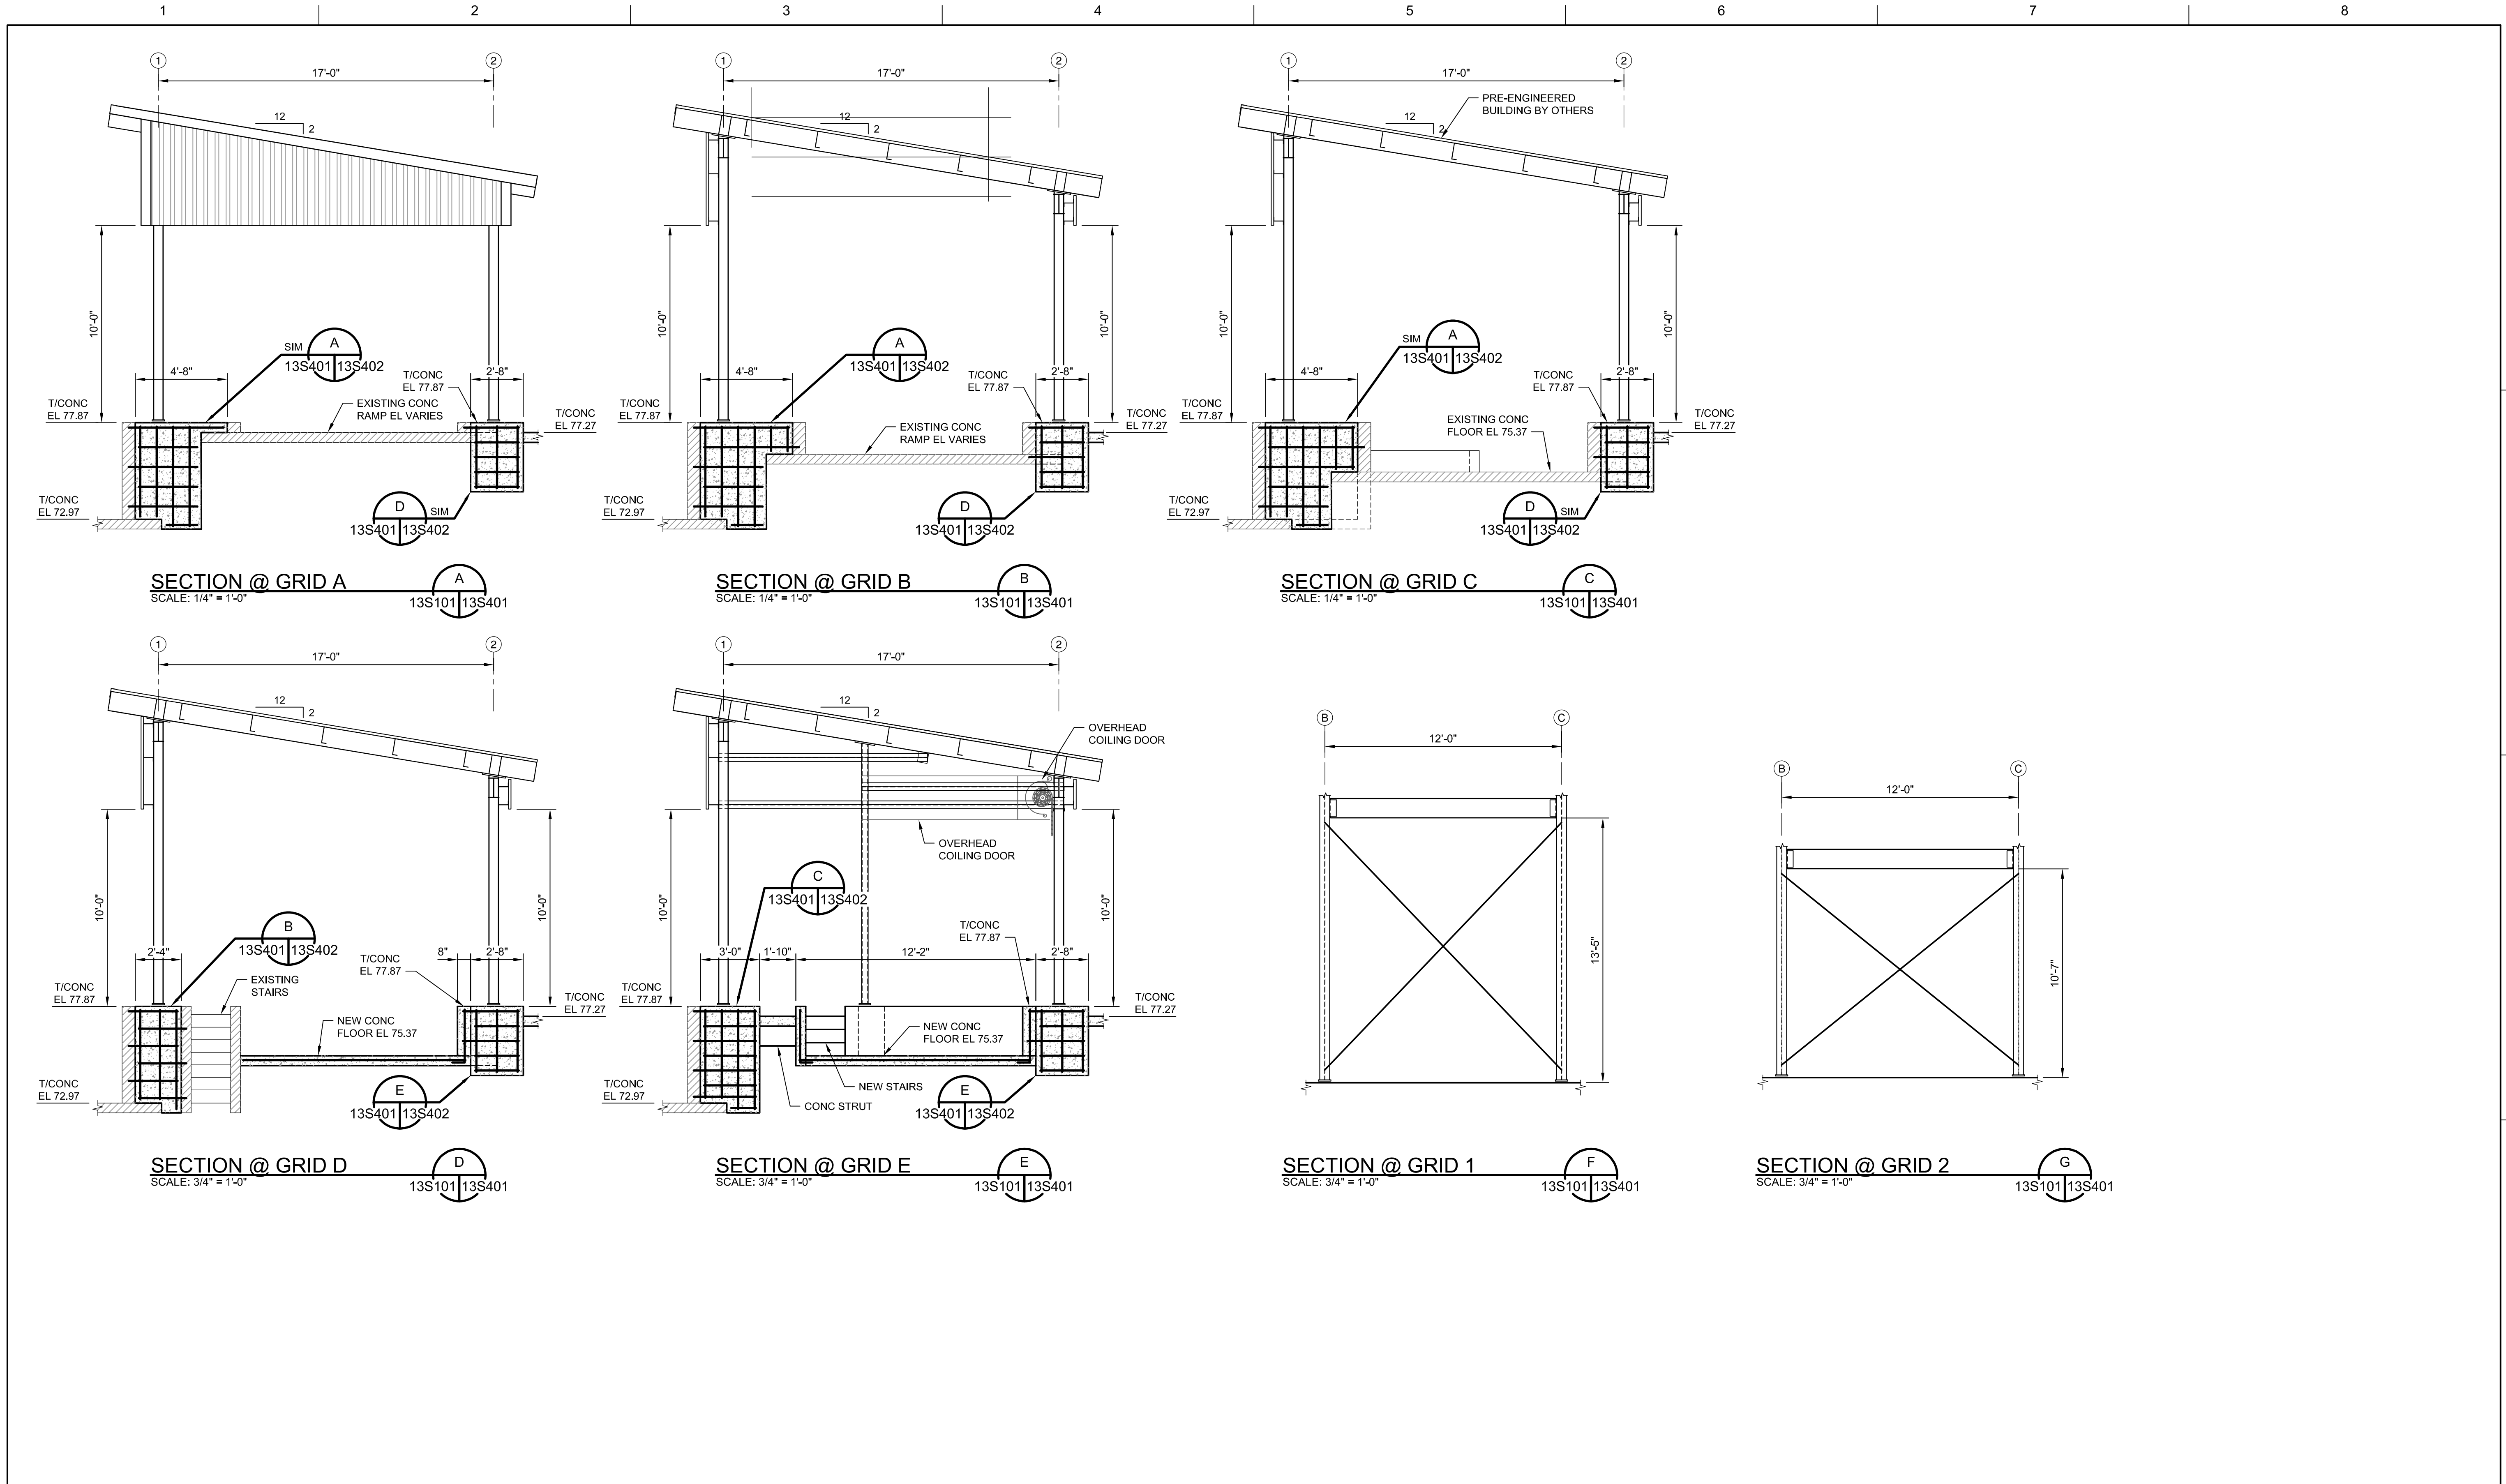
PROJECT MANAGER	ERIC ORTON P.E.
DESIGN BY	JLH
DESIGN BY	
CHECKED BY	
DRAWN BY	ACB
PLOT DATE	May 18, 2023
PROJECT NUMBER	10176455



**KALAMA CREEK HATCHERY
PHASE 2**
**NATURAL RESOURCES DEPARTMENT
NISQUALLY INDIAN TRIBE**
EDA AWARD NUMBER 07-79-07880























ADULT HANDLING BUILDING

SECTIONS

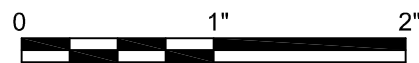

FILENAME	13S401.DWG
SCALE	AS NOTED

SHEET
13S401

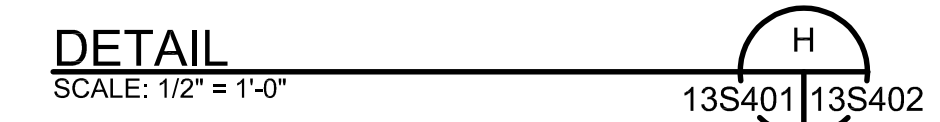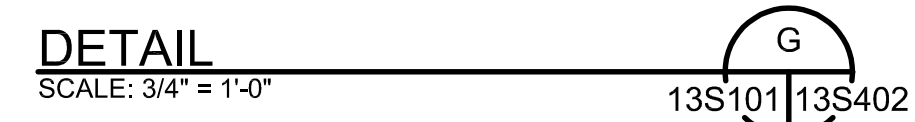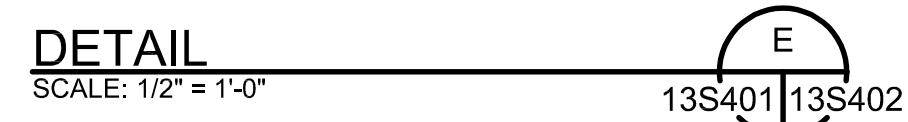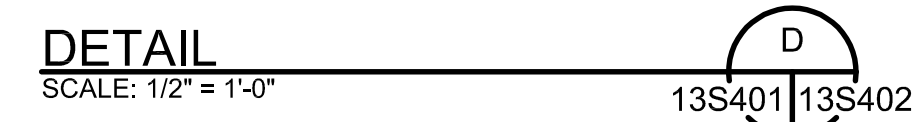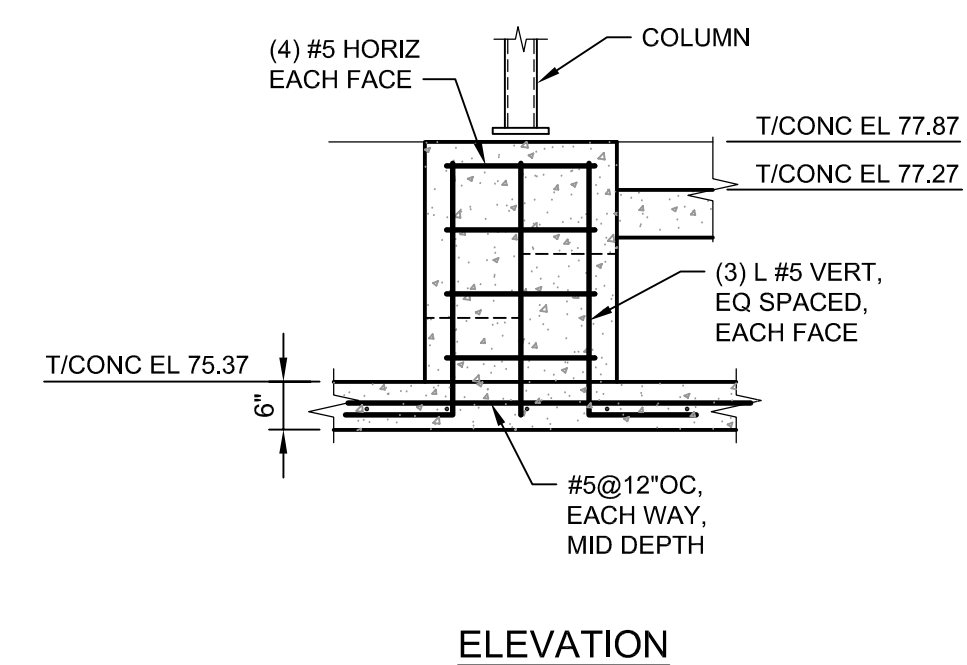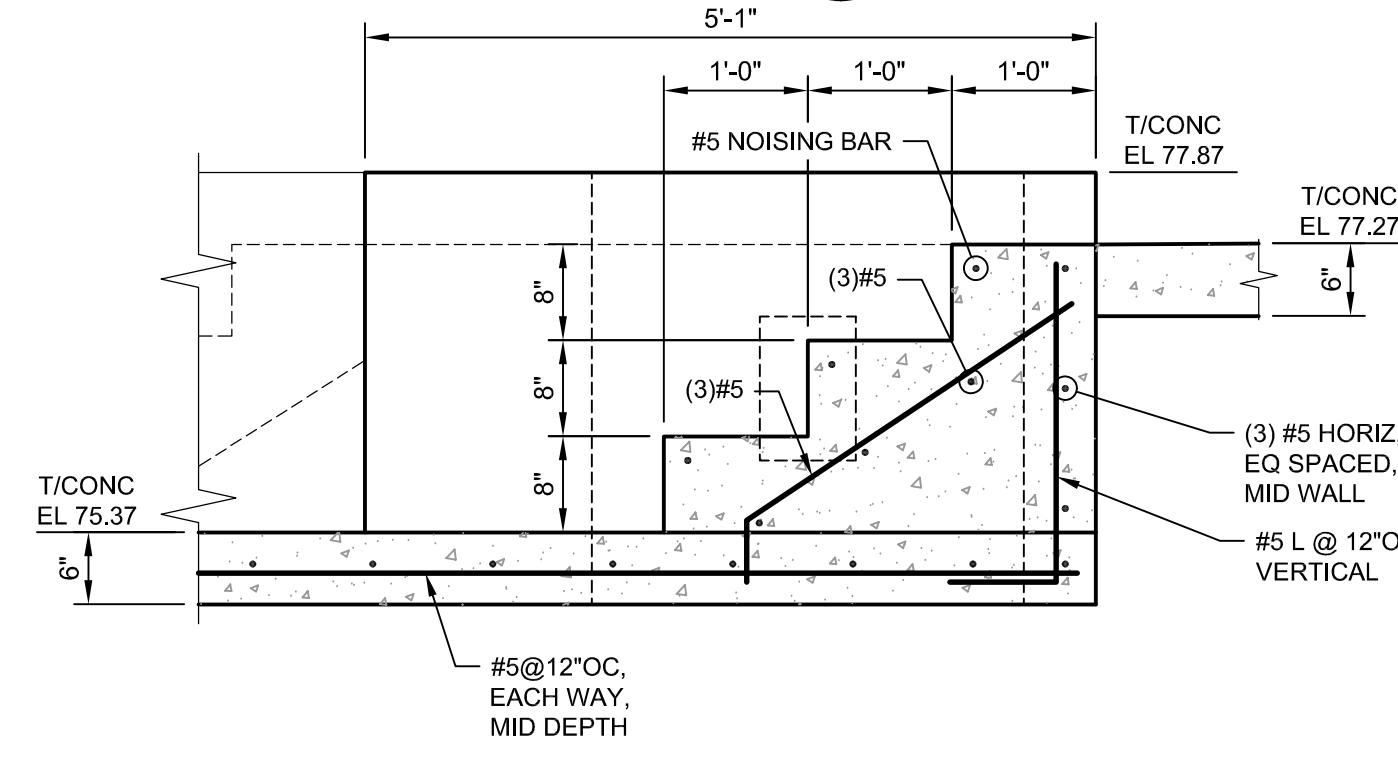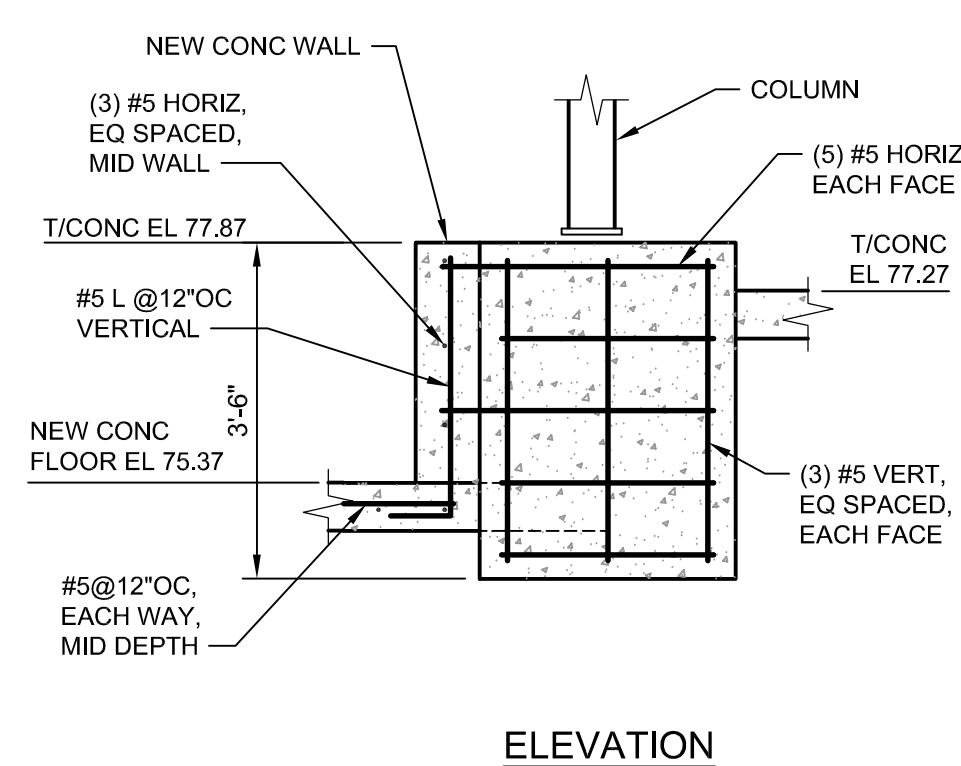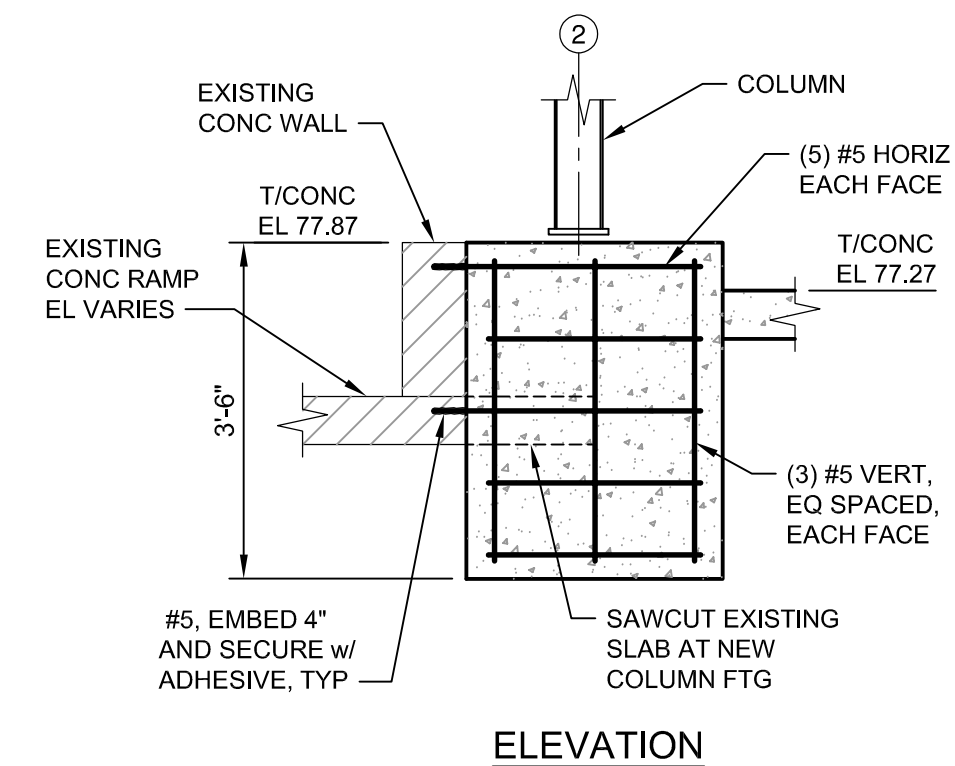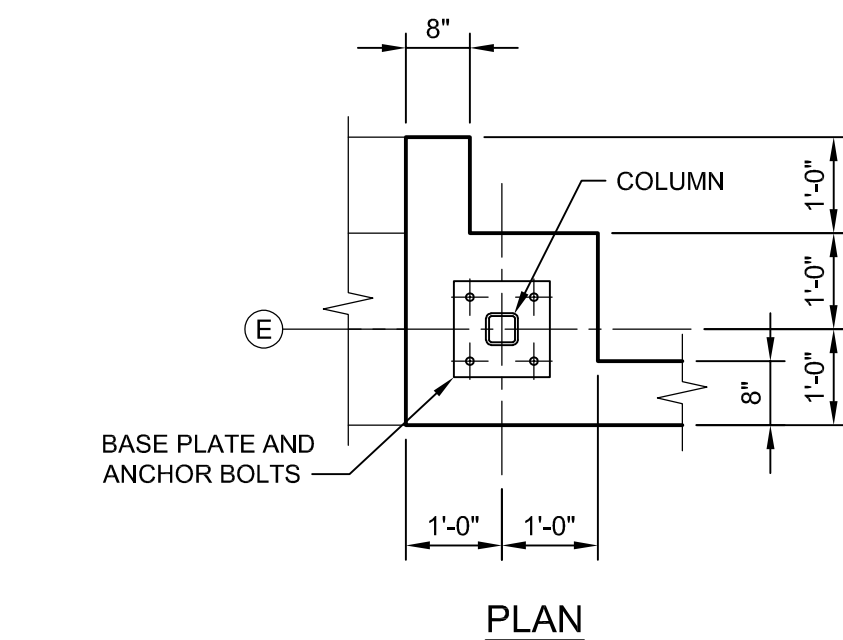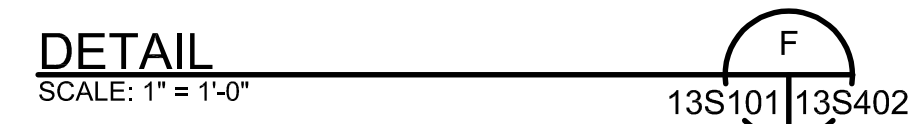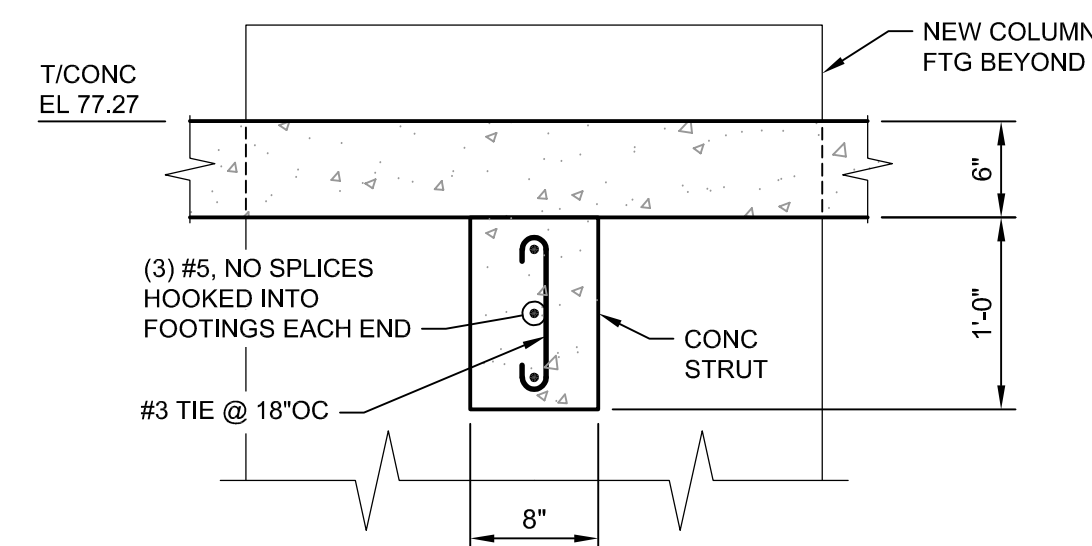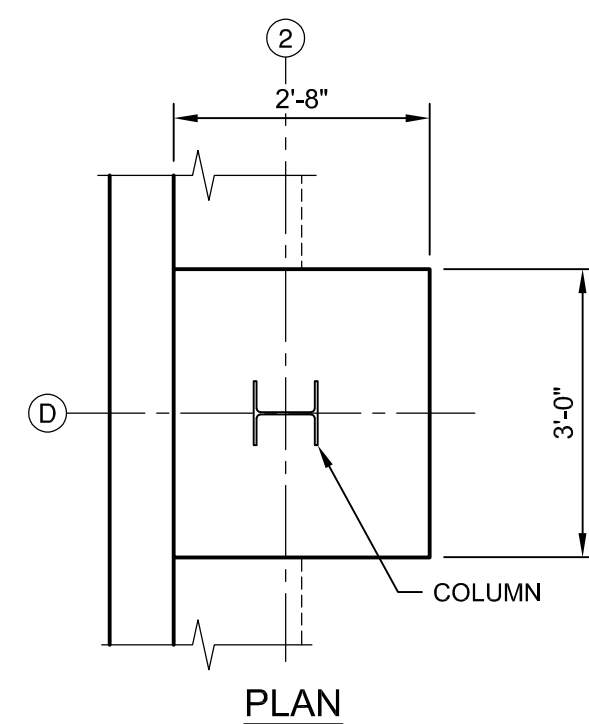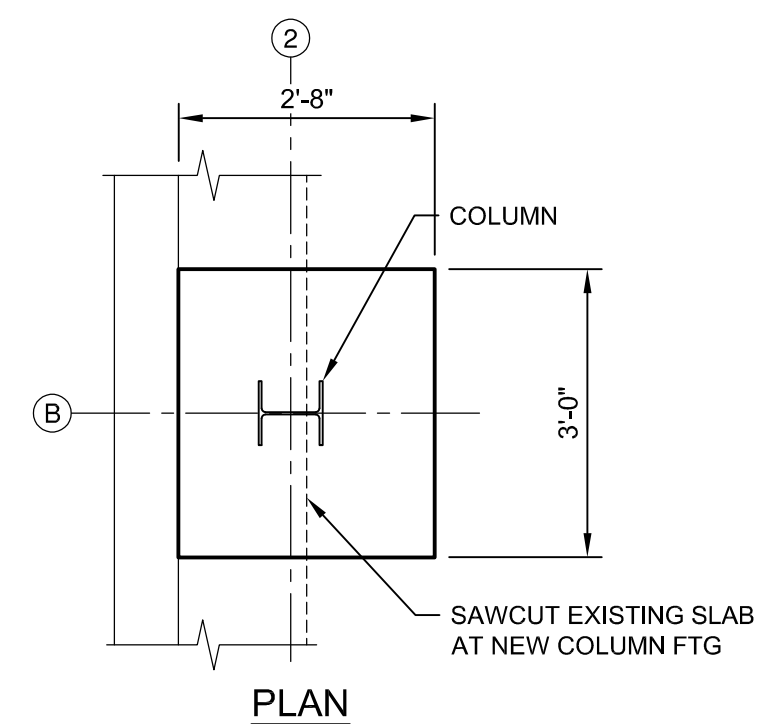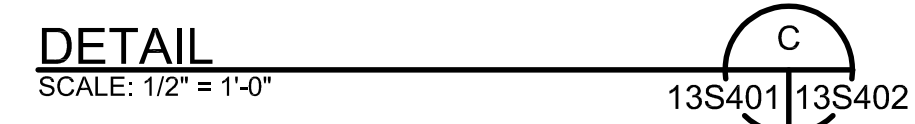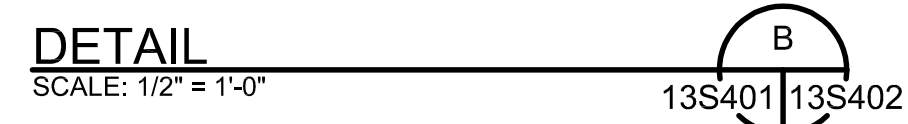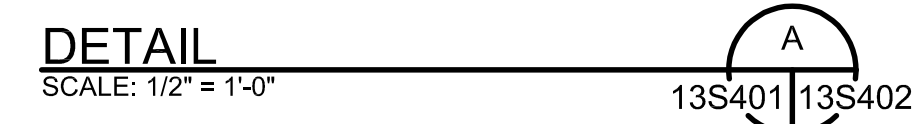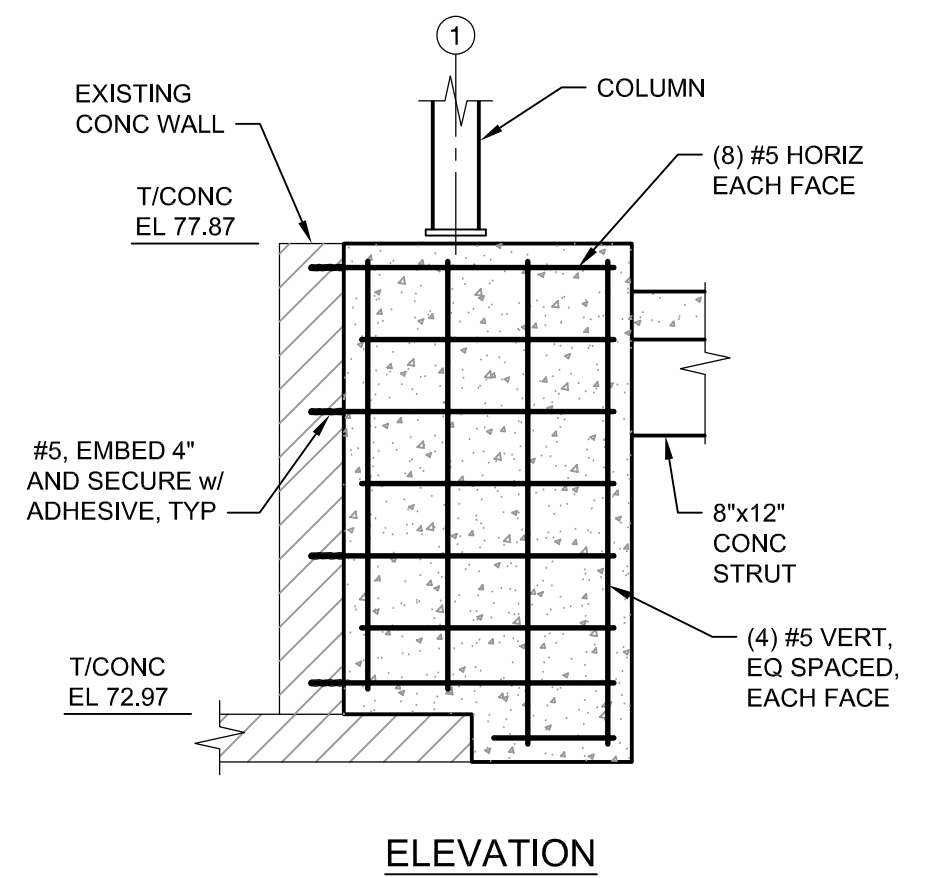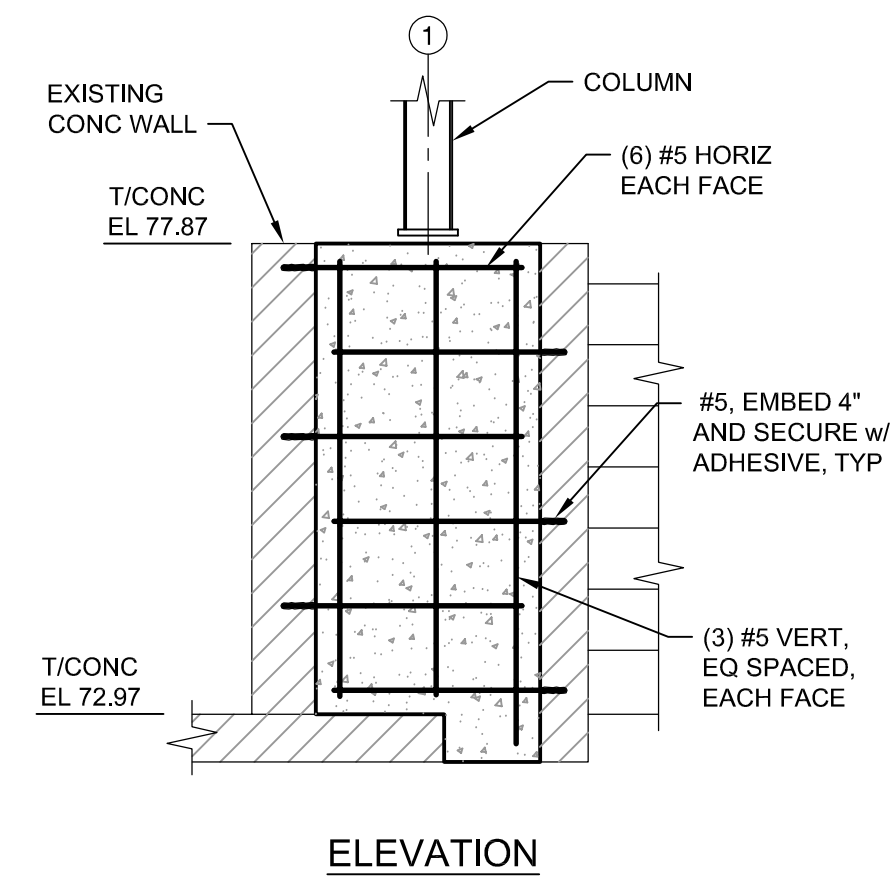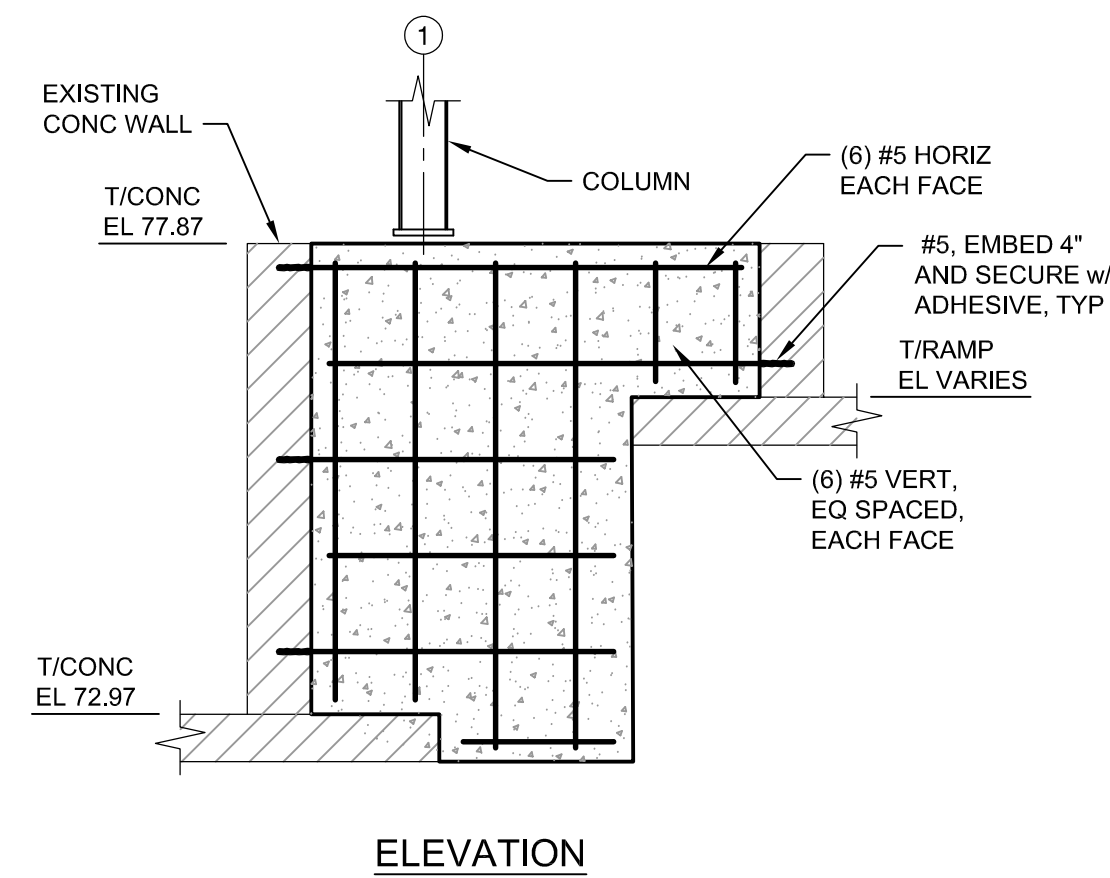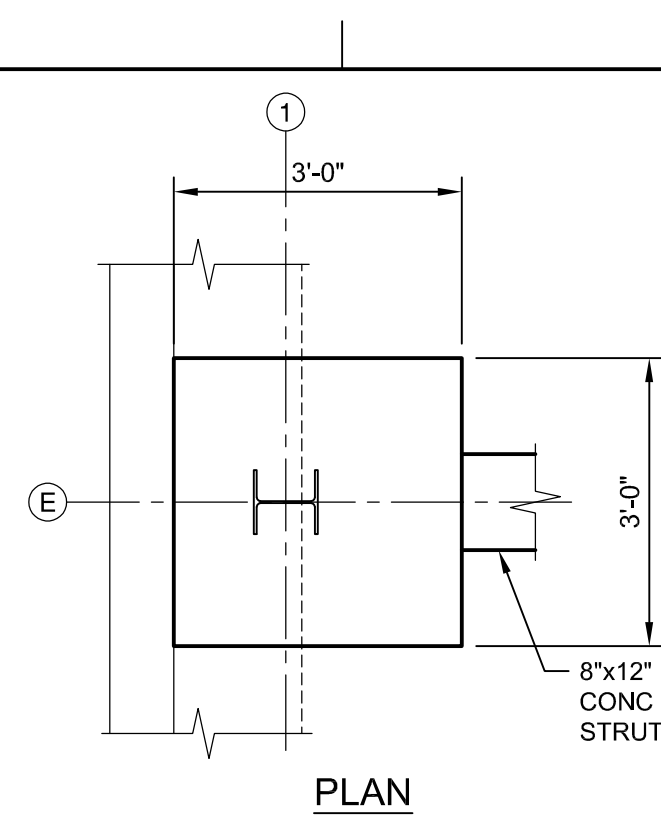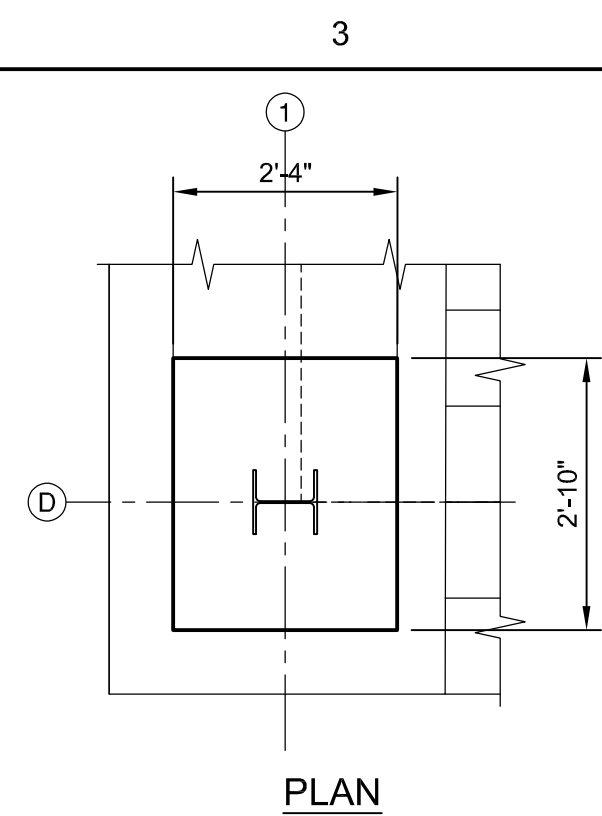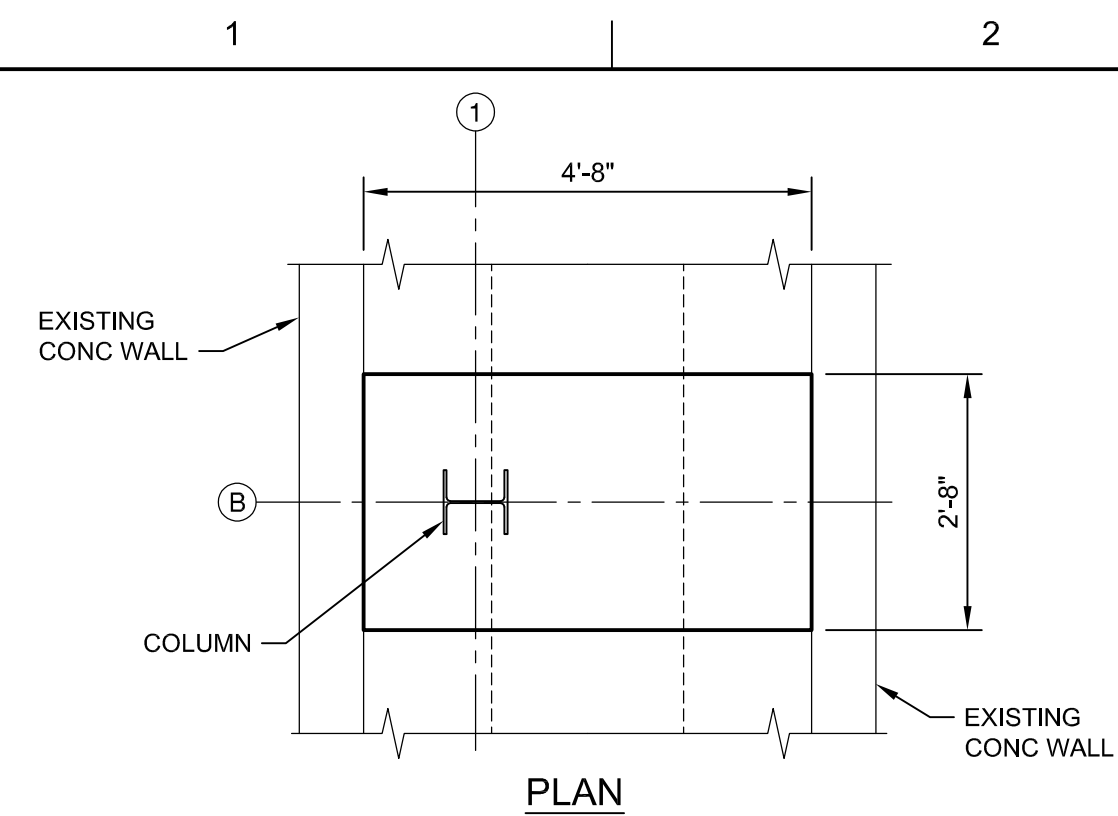[illegible]

PROJECT MANAGER	ERIC ORTON	P.E.
DESIGN BY	JLH	
DESIGN BY		
CHECKED BY		
DRAWN BY	ACB	
PLOT DATE	May 18, 2023	
PROJECT NUMBER	10176455	



KALAMA CREEK HATCHERY PHASE 2

**NATURAL RESOURCES DEPARTMENT
NISQUALLY INDIAN TRIBE
EDA AWARD NUMBER 07-79-07880**


ADULT HANDLING BUILDING

SECTIONS




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SCALE	AS NOTED

SHEET
13S402

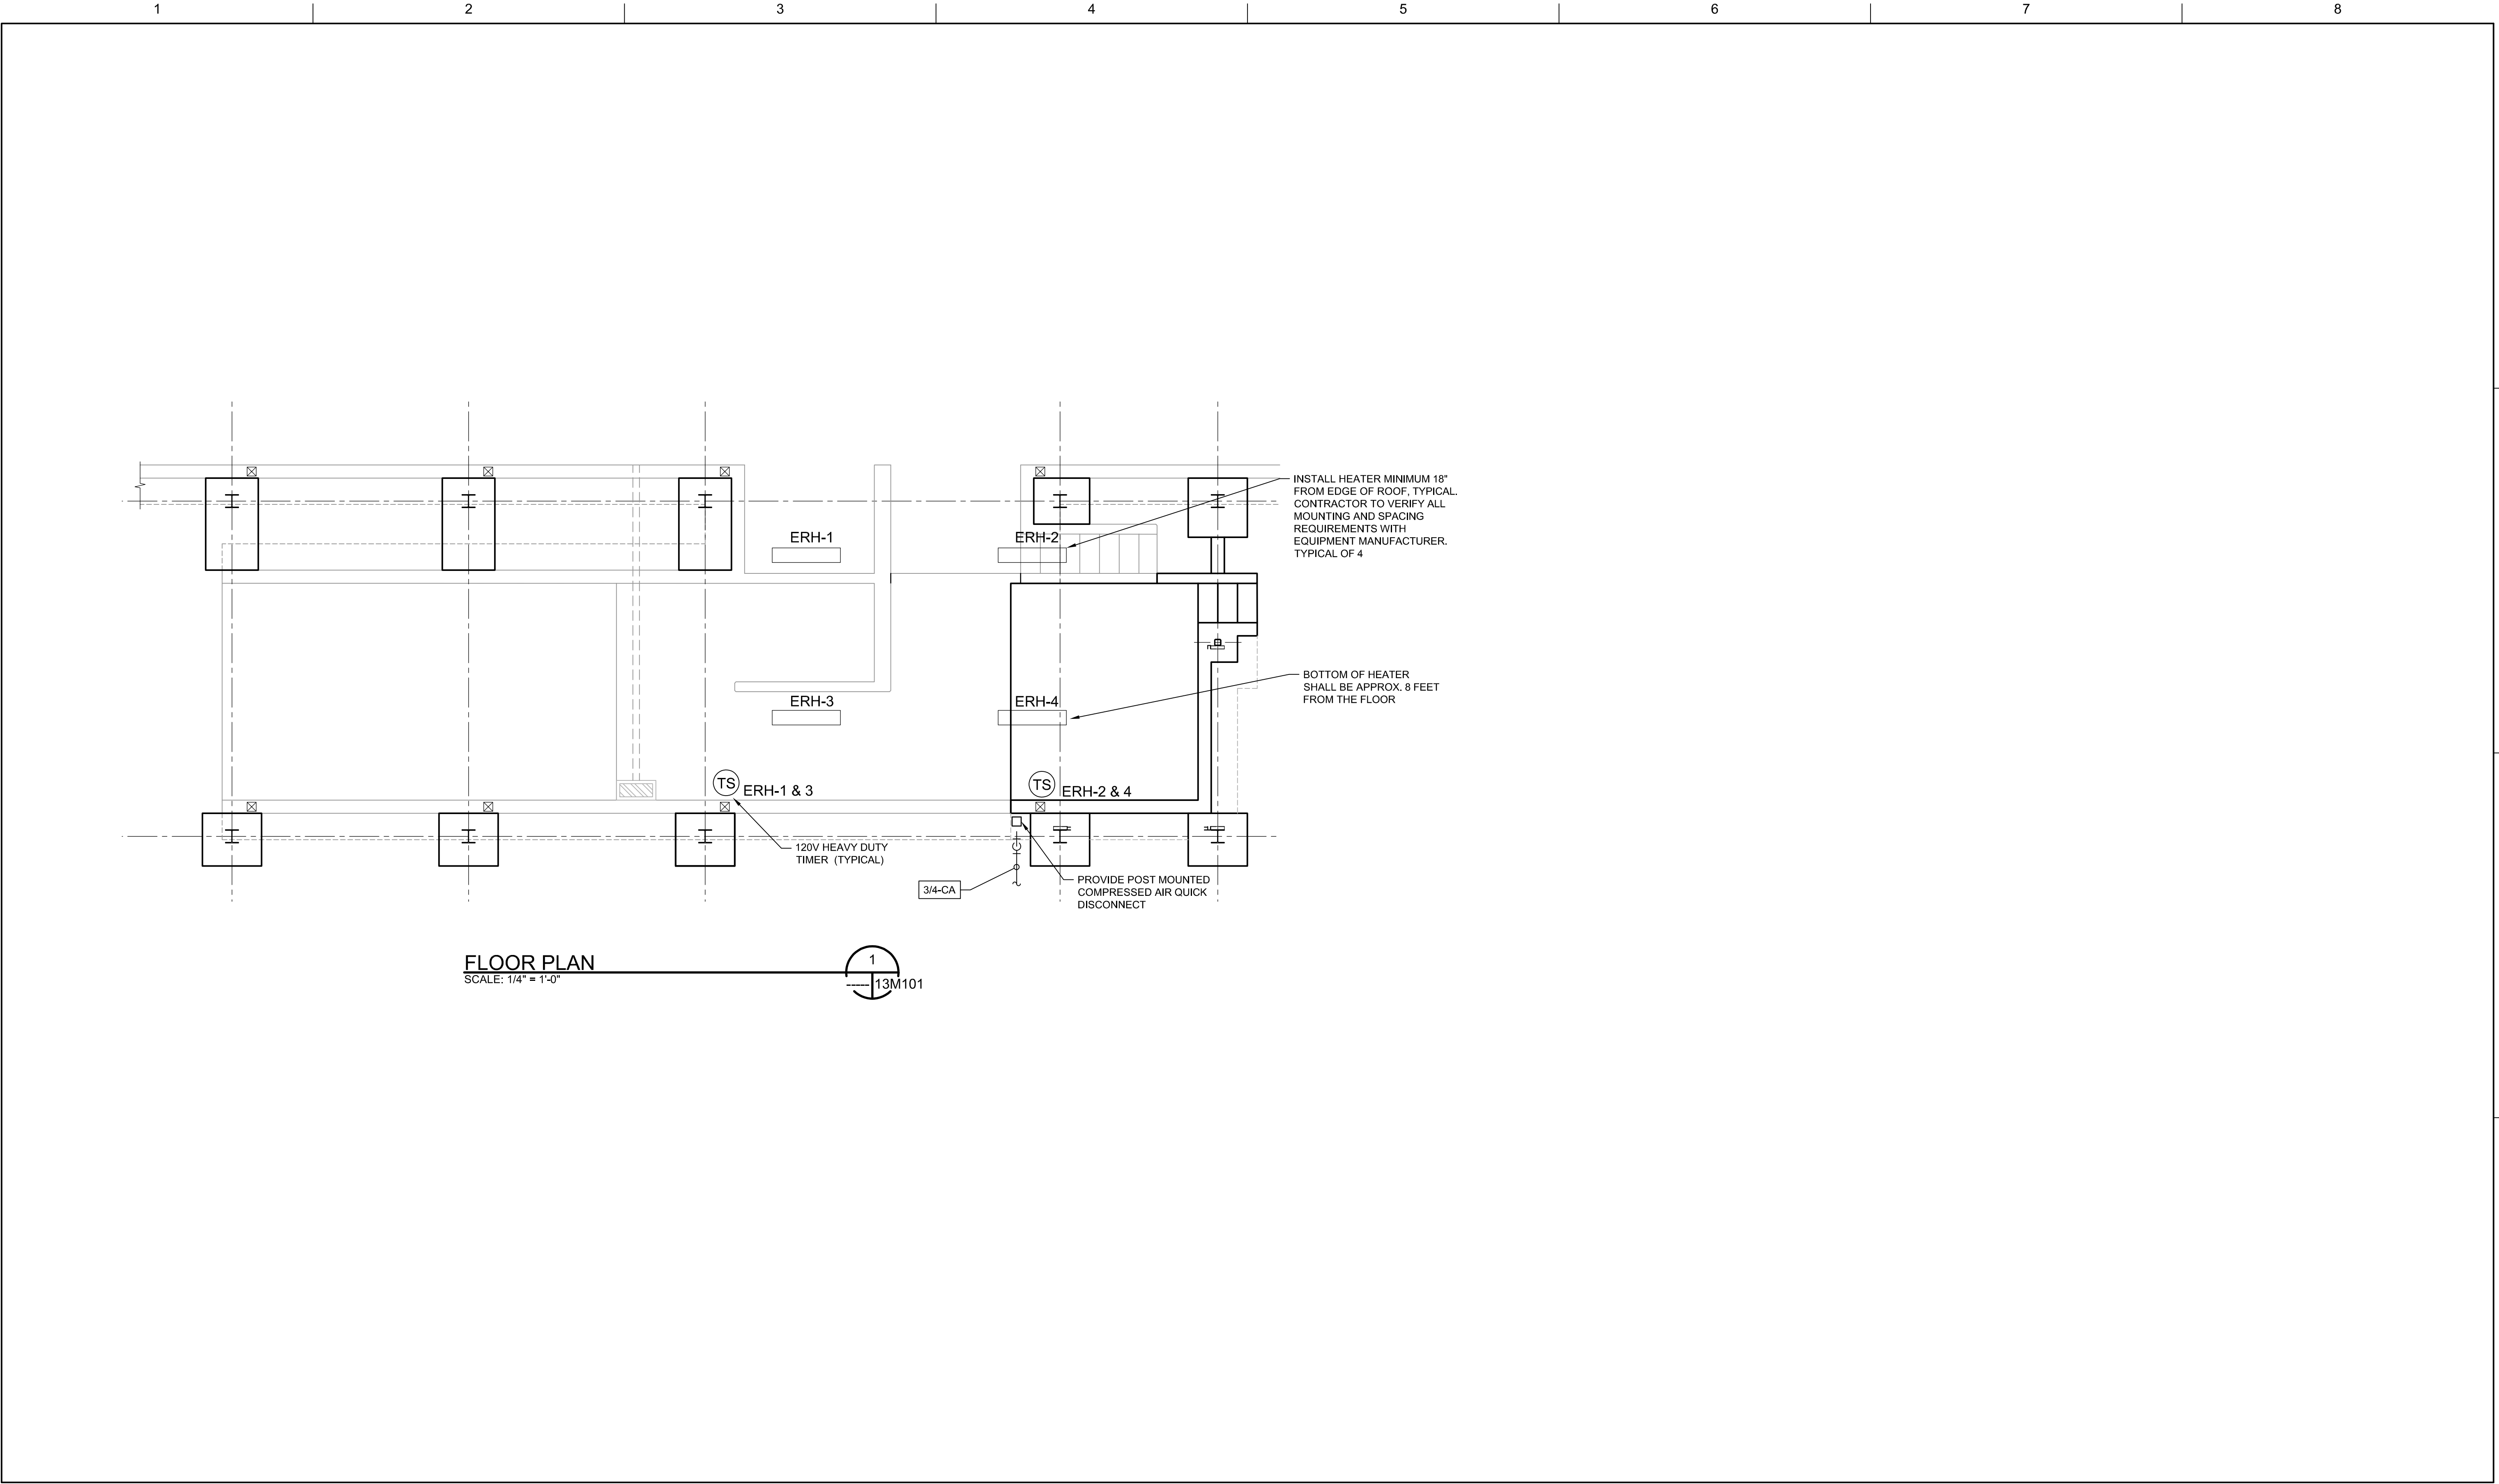

ISSUE	DATE	DESCRIPTION

PROJECT MANAGER	ERIC ORTON P.E.
DESIGN BY	KCC
DESIGN BY	
CHECKED BY	
DRAWN BY	ACB
PLOT DATE	May 18, 2023
PROJECT NUMBER	10176455

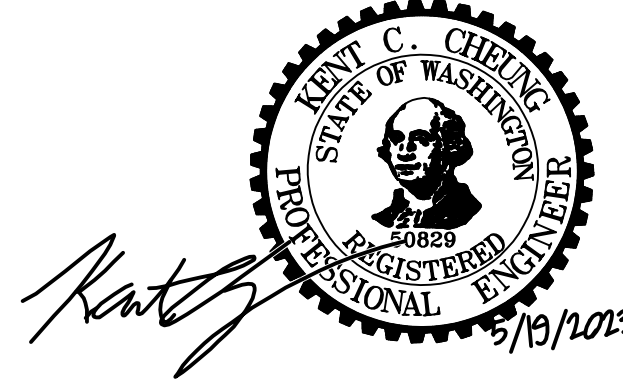



KALAMA CREEK HATCHERY
PHASE 2
NATURAL RESOURCES DEPARTMENT
NISQUALLY INDIAN TRIBE
EDA AWARD NUMBER 07-79-07880

ADULT HANDLING BUILDING
MECHANICAL
FLOOR PLAN

0 1" 2"

FILENAME | 13M101.DWG
SCALE | AS NOTED

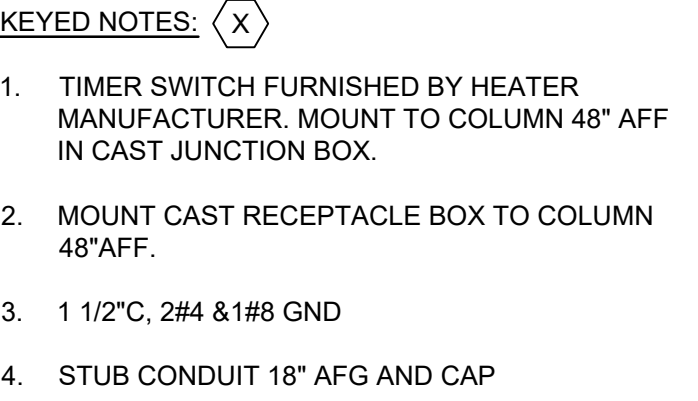

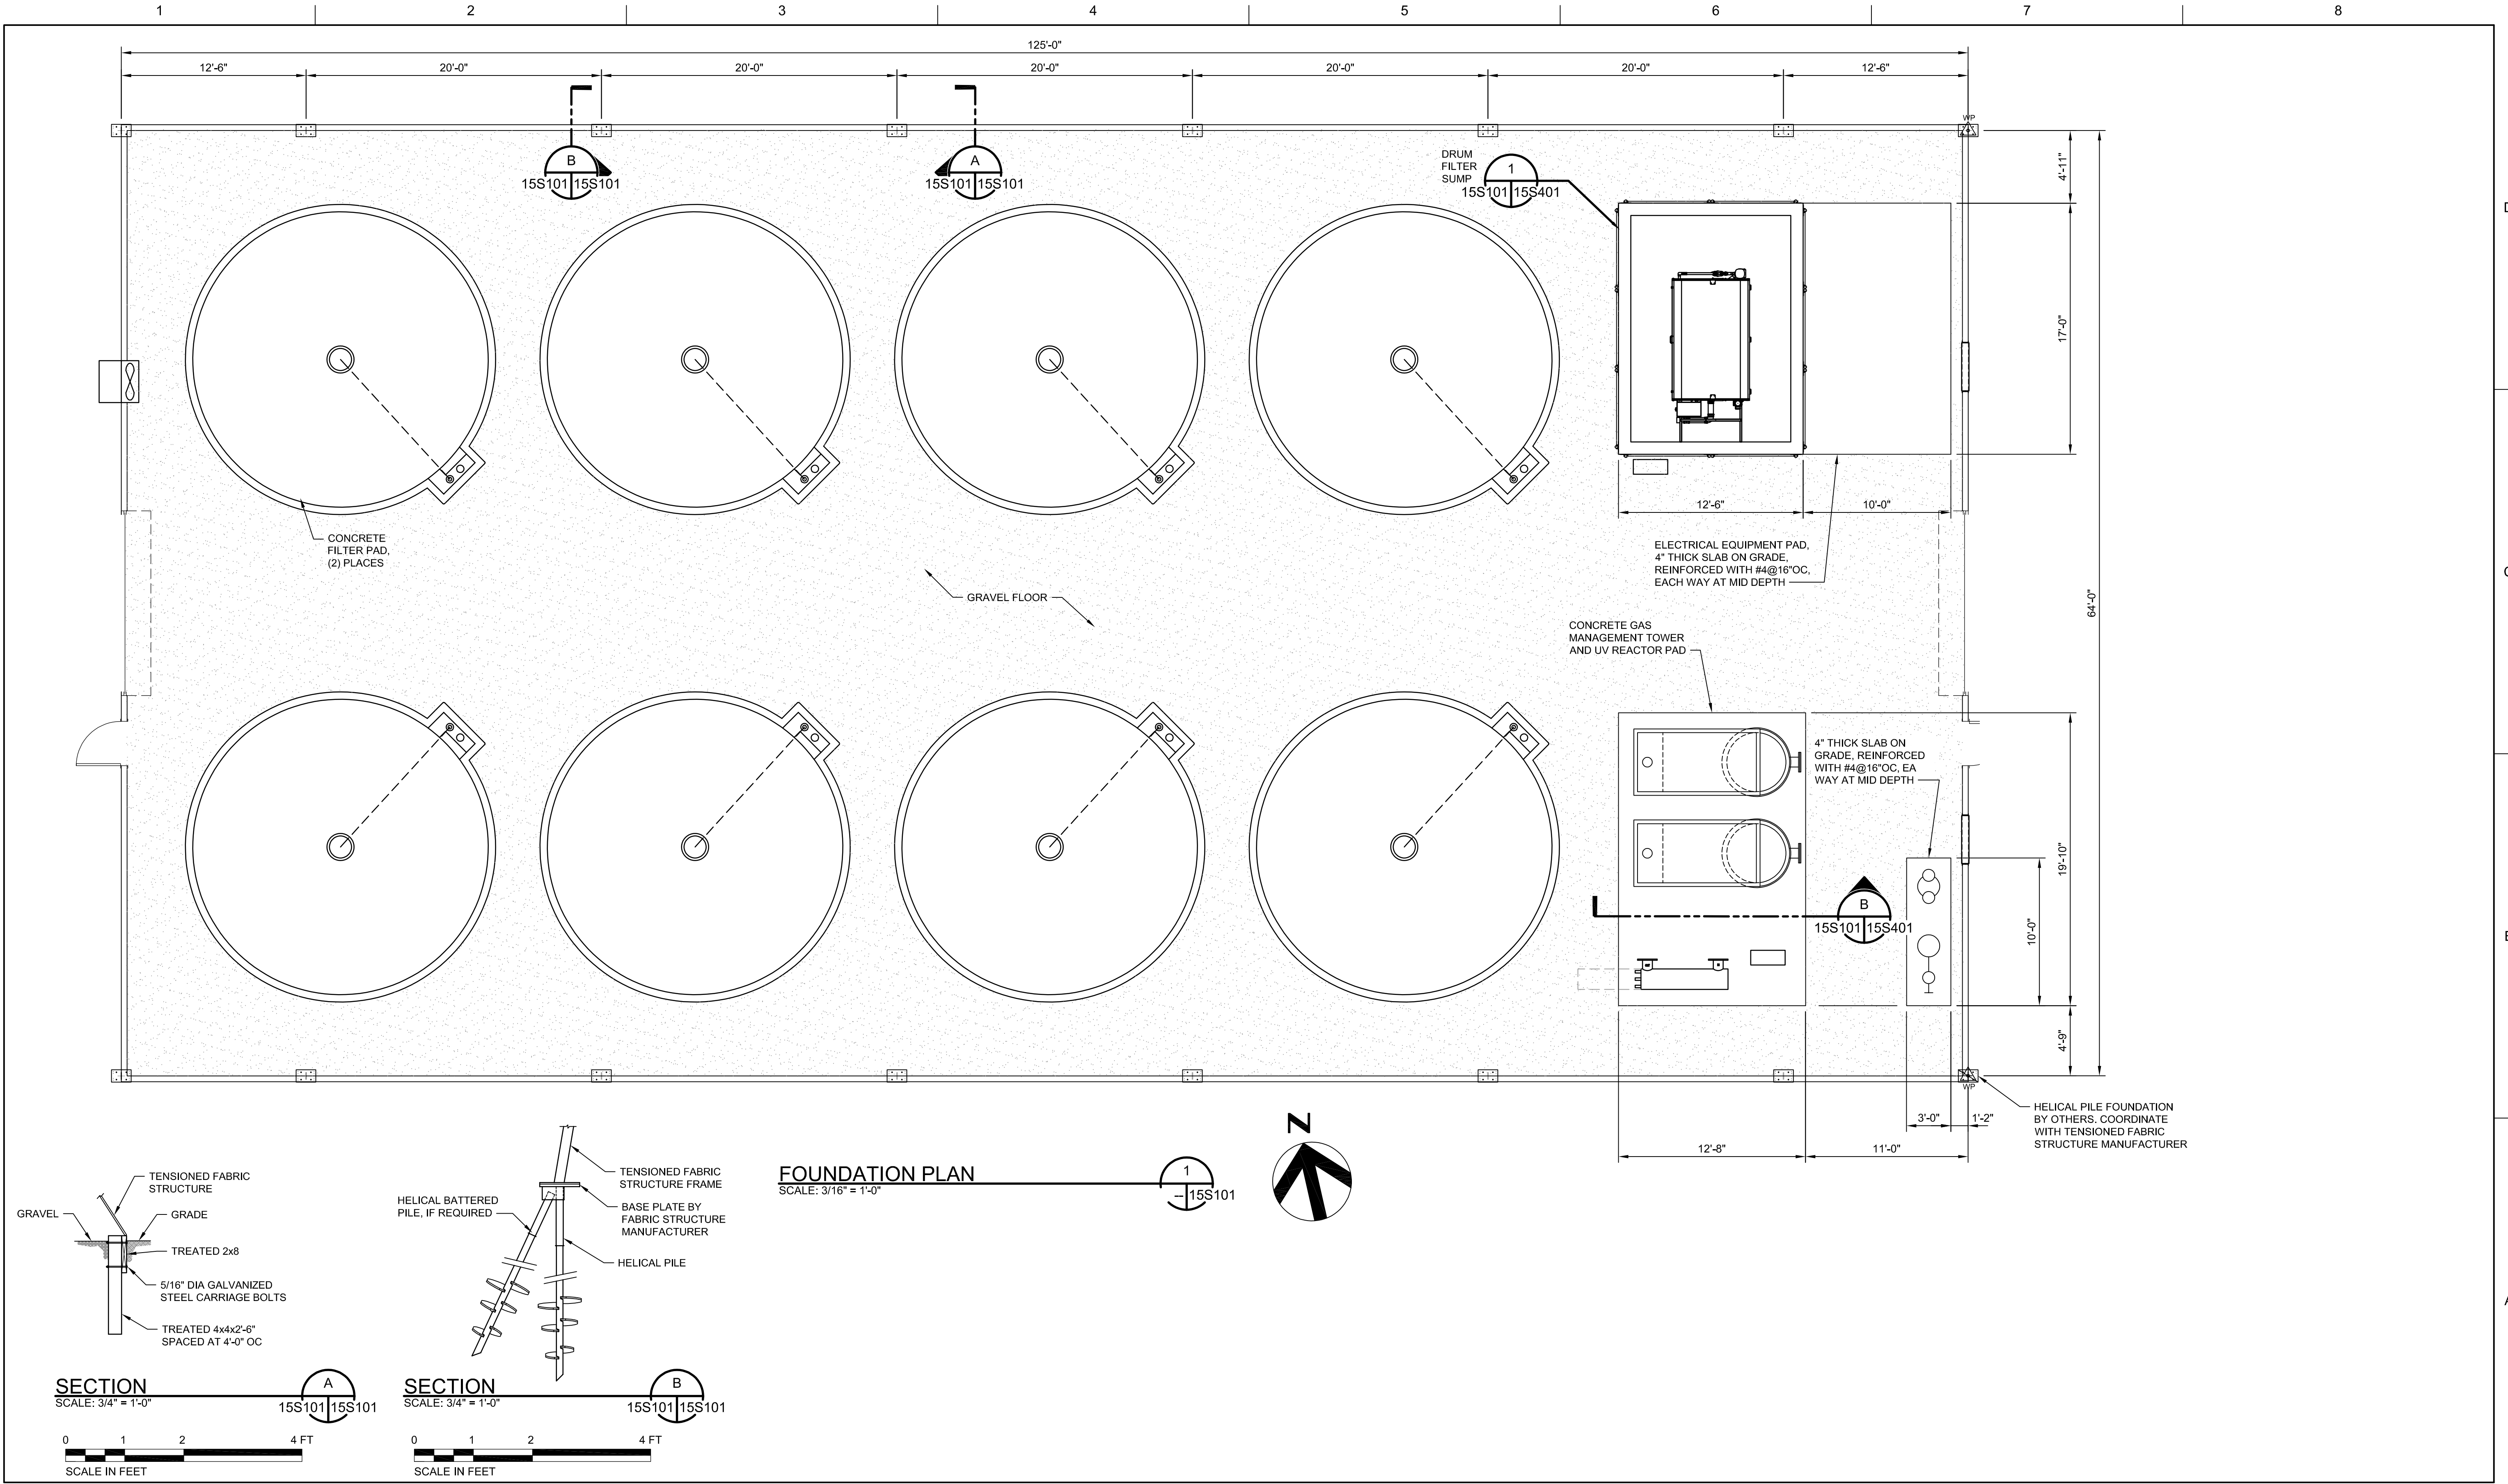


ISSUE	DATE	DESCRIPTION

PROJECT MANAGER	ERIC ORTON P.E.
DESIGN BY	EEO
DESIGN BY	JLH
CHECKED BY	
DRAWN BY	ACB
PLOT DATE	May 18, 2023
PROJECT NUMBER	10176455




**KALAMA CREEK HATCHERY
PHASE 2**
**NATURAL RESOURCES DEPARTMENT
NISQUALLY INDIAN TRIBE**
EDA AWARD NUMBER 07-79-07880

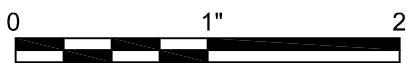

**CIRCULAR TANK BUILDING
FOUNDATION PLAN
AND SECTIONS**


FILENAME	15S101.DWG
SCALE	AS NOTED

SHEET
15S101

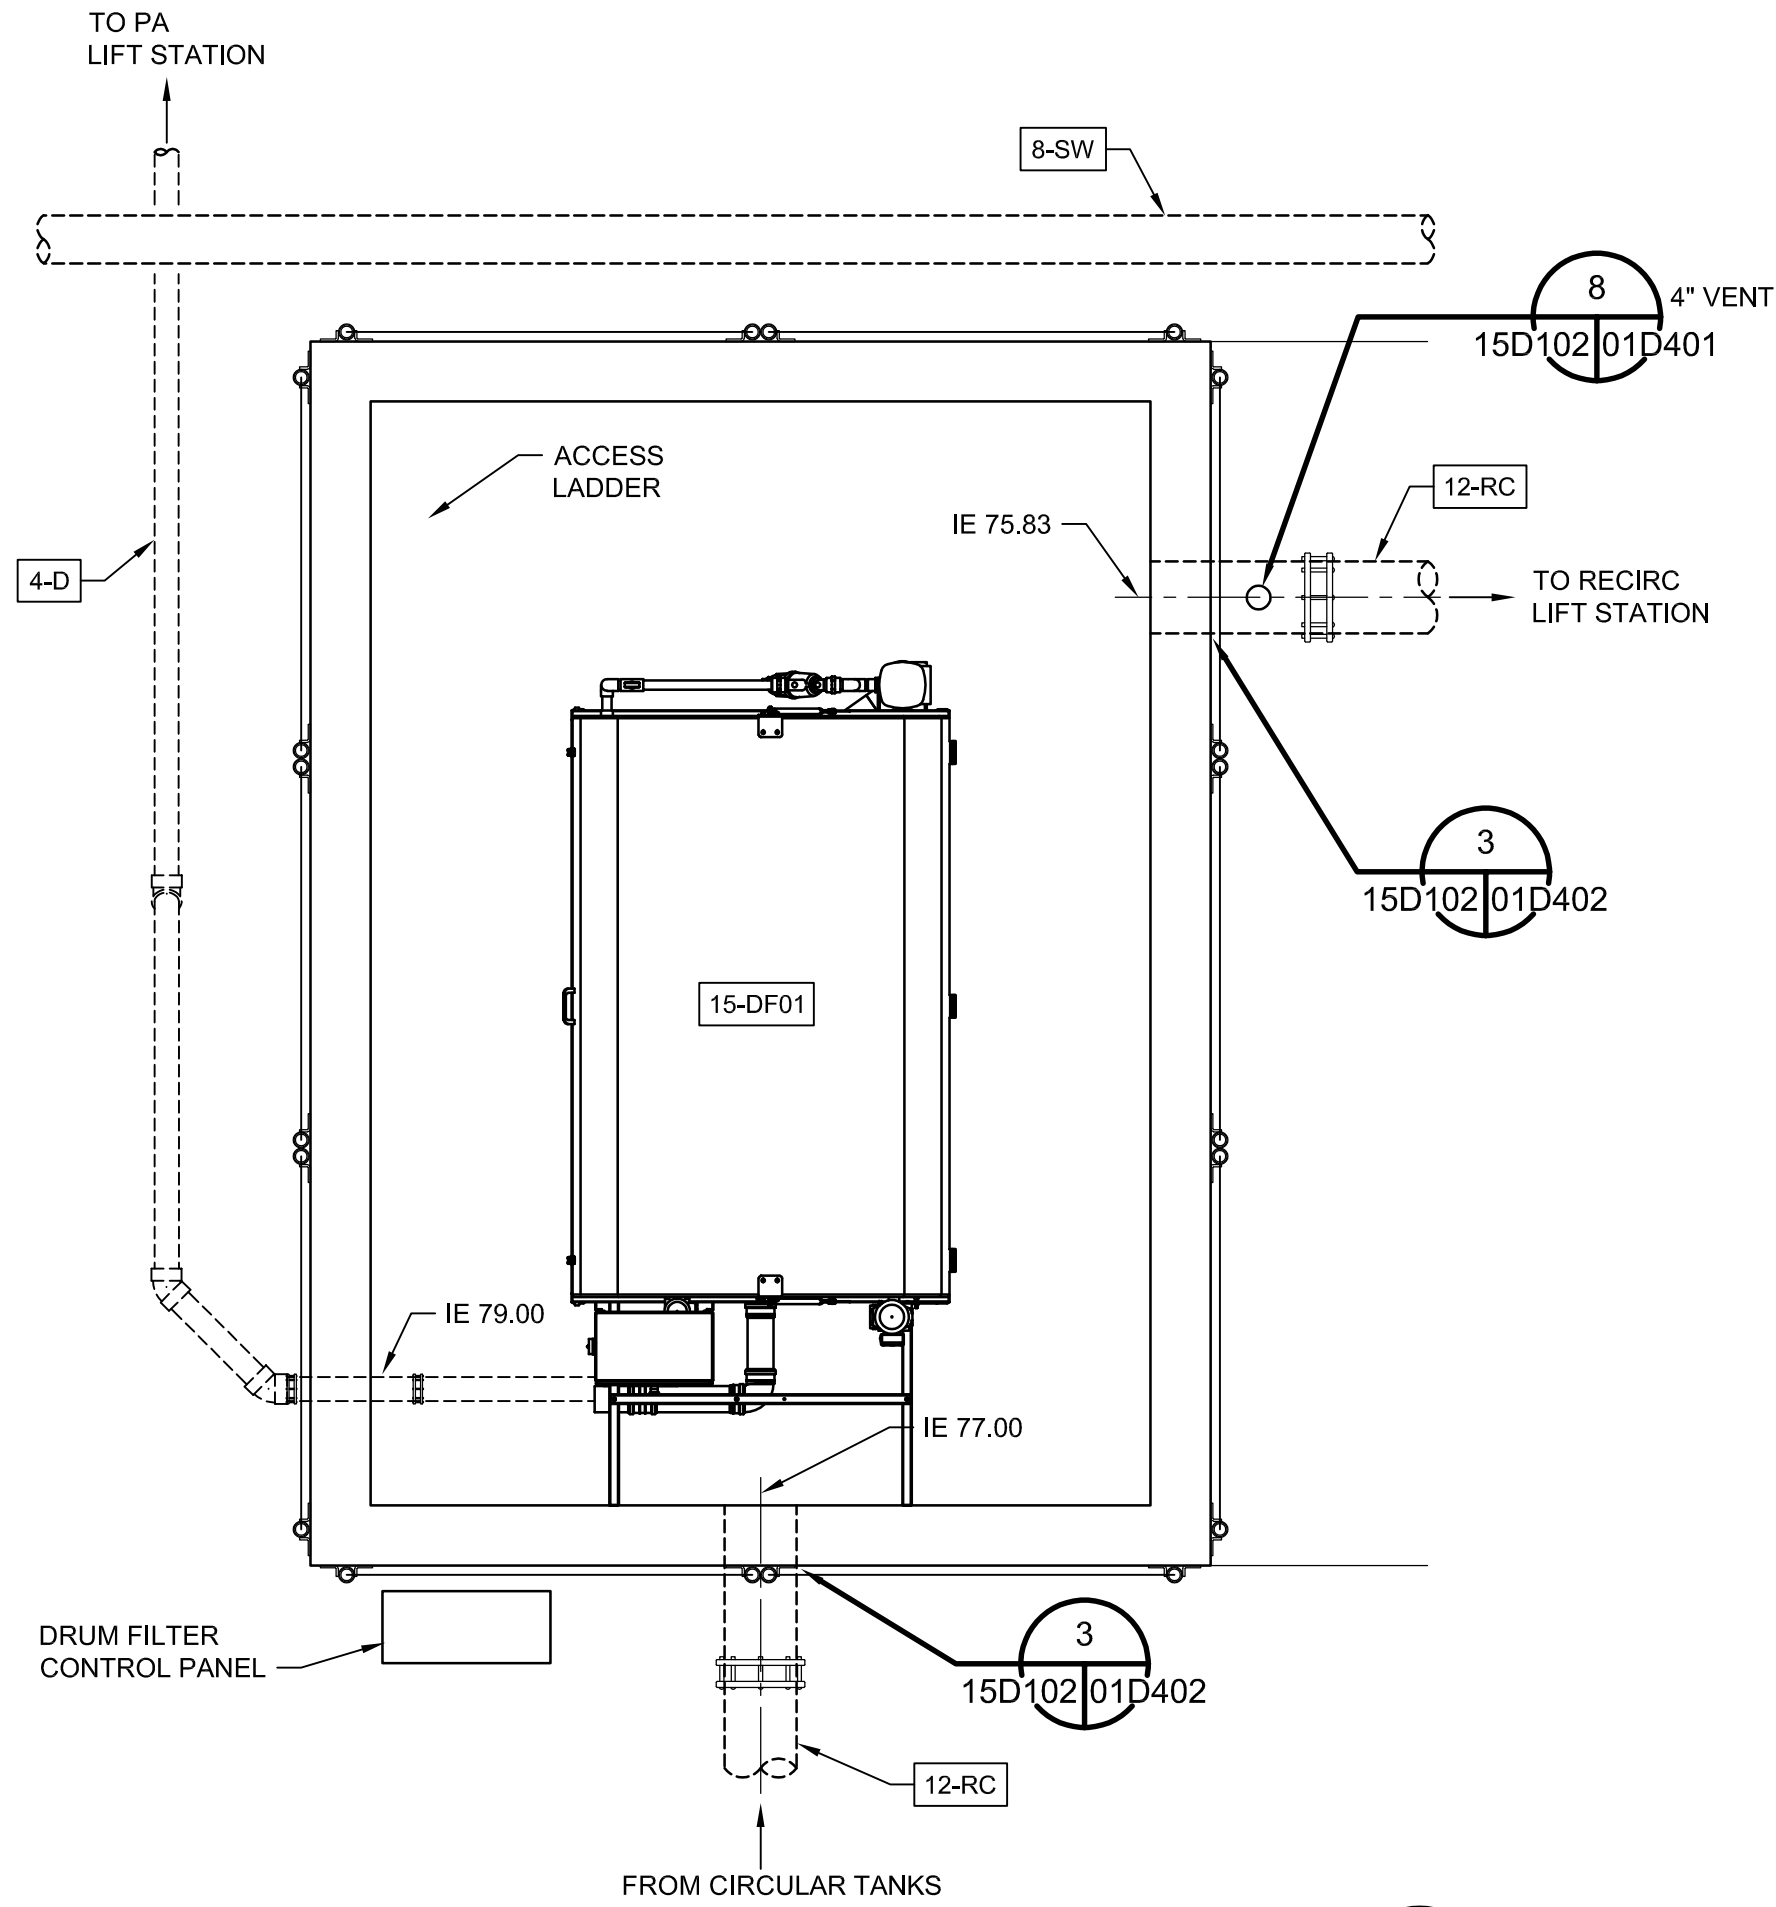

PARTIAL PLAN - DRUM FILTER SUMP

SCALE: 3/8" = 1'-0"

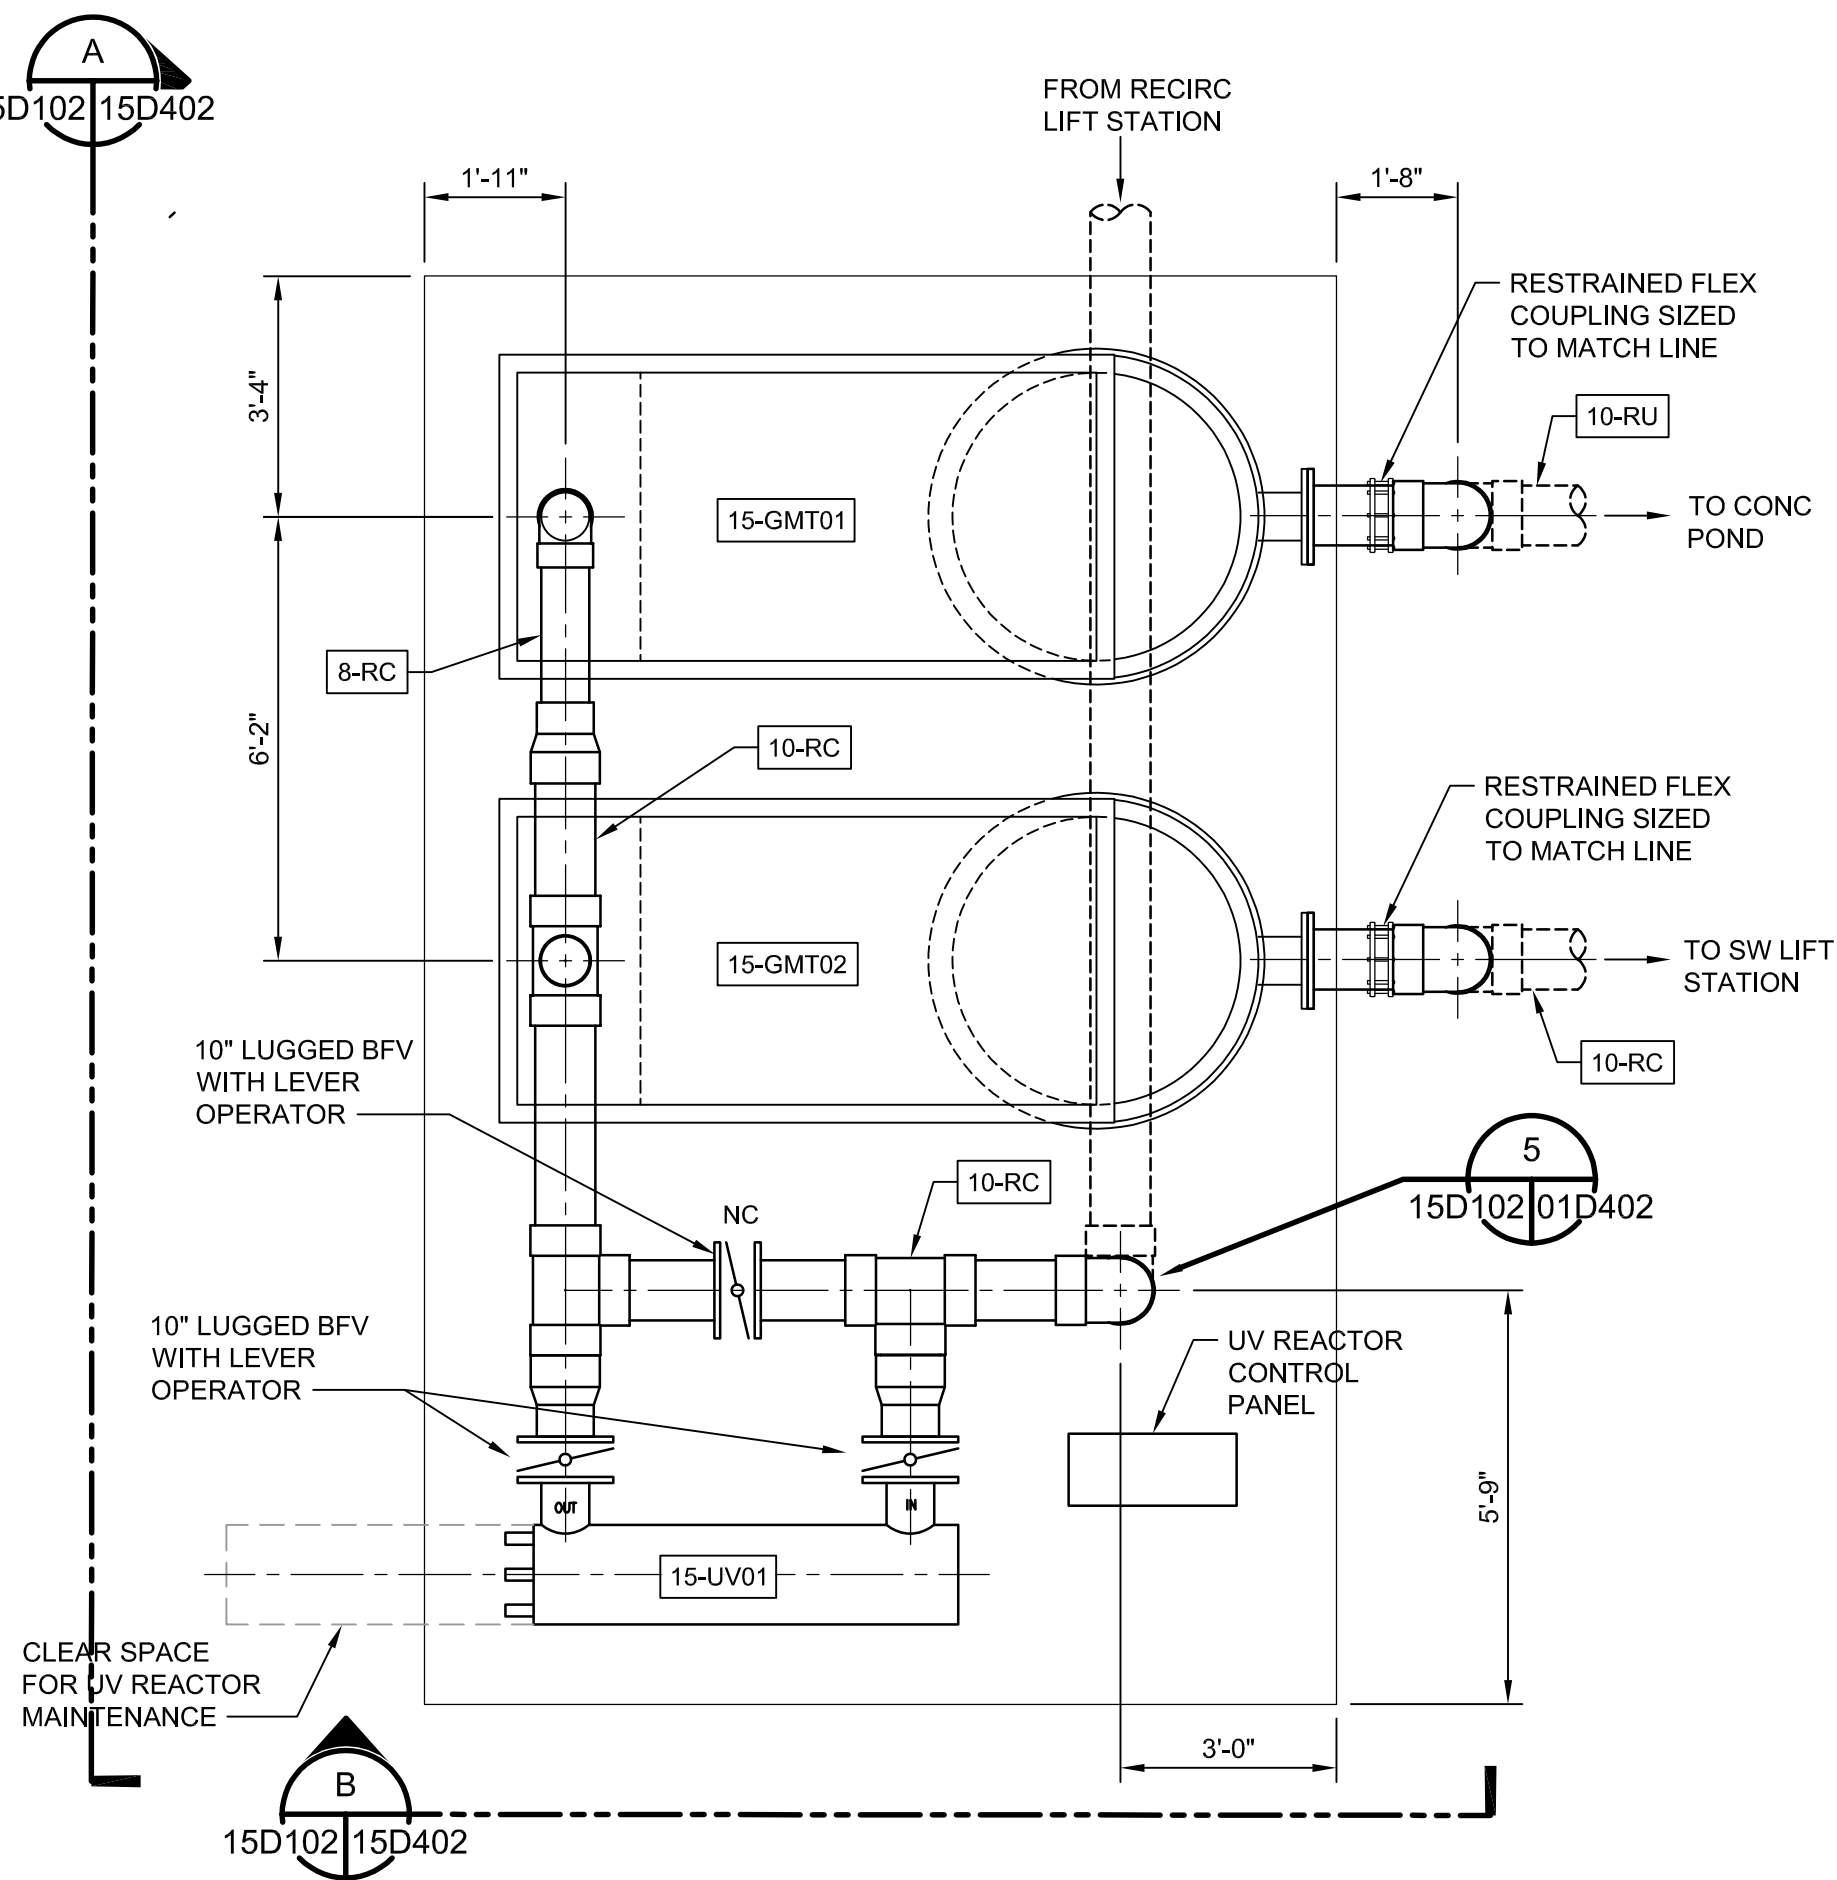

PARTIAL PLAN - MECHANICAL FILTER EQUIPMENT SLAB


SCALE: 3/8" = 1'-0"

NOTE:
COAT ALL EXPOSED PLASTIC PIPE FOR UV PROTECTION.




ISSUE	DATE	DESCRIPTION

PROJECT MANAGER	ERIC ORTON P.E.
DESIGN BY	EEO
DESIGN BY	
CHECKED BY	
DRAWN BY	ACB
PLOT DATE	May 18, 2023
PROJECT NUMBER	10176455

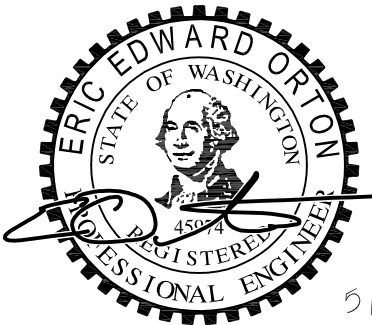





KALAMA CREEK HATCHERY
PHASE 2
NATURAL RESOURCES DEPARTMENT
NISQUALLY INDIAN TRIBE
EDA AWARD NUMBER 07-79-07880

CIRCULAR TANK BUILDING
PARTIAL PIPING PLANS

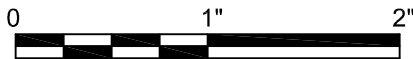


FILENAME	15D102.DWG
SCALE	AS NOTED

SHEET
15D102

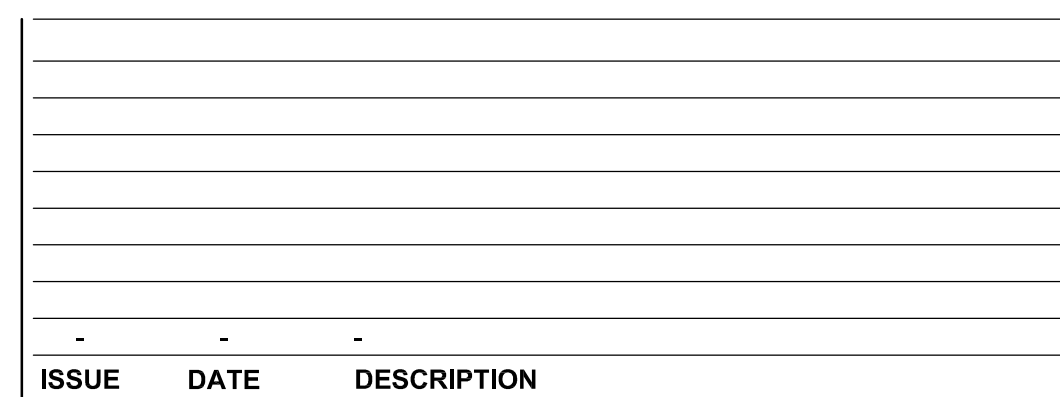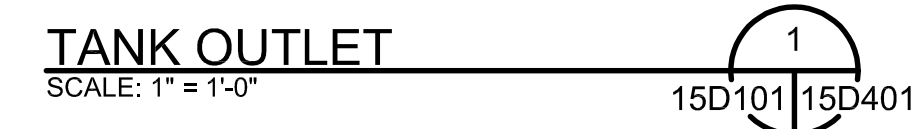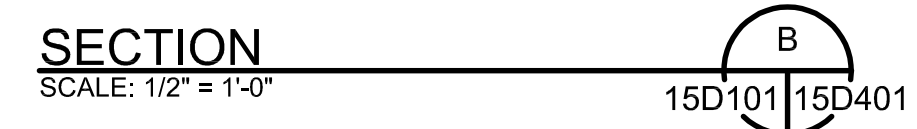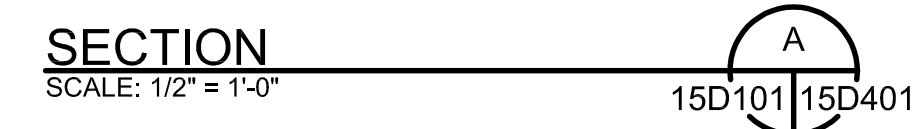

PROJECT MANAGER	ERIC ORTON	P.E.
DESIGN BY	EEO	
DESIGN BY		
CHECKED BY		
DRAWN BY	ACB	
PLOT DATE	May 18, 2023	
PROJECT NUMBER	10176455	

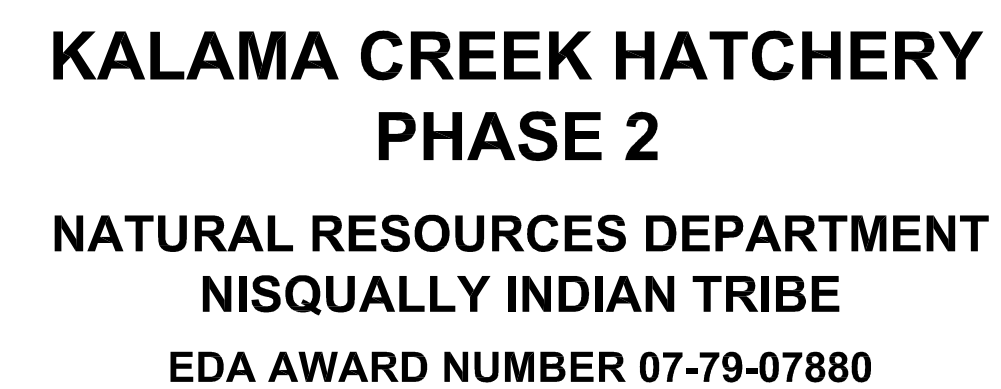


CIRCULAR TANK BUILDING

25' DIA TANK SECTIONS AND DETAILS




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SCALE	AS NOTED

HEET
15D401

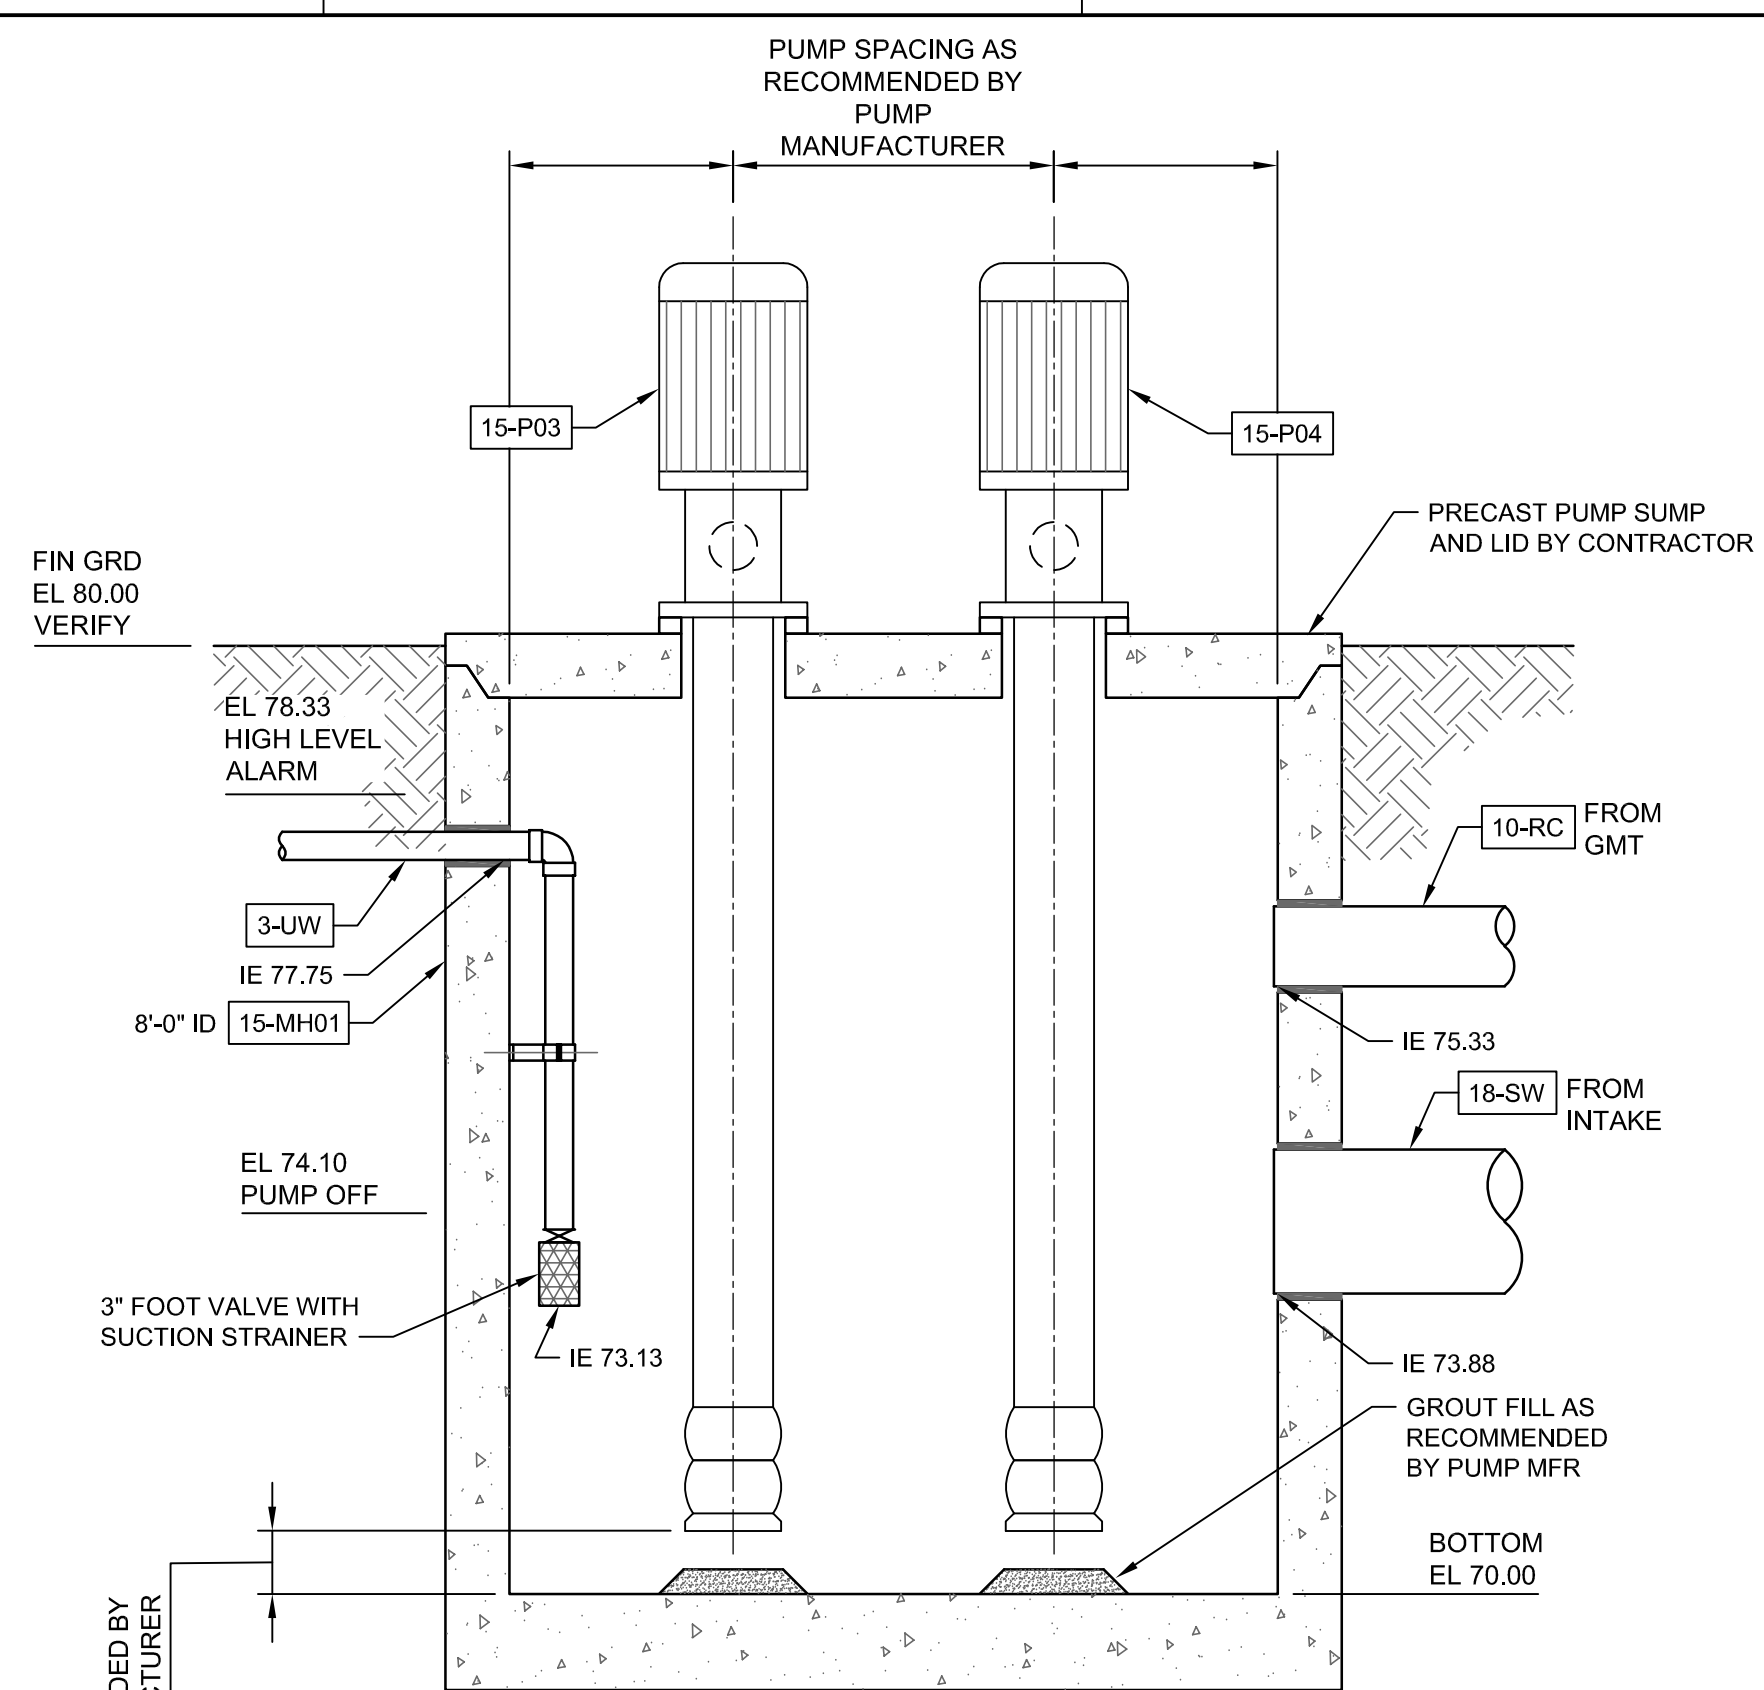


SECTION
SCALE: 1/8" = 1'-0"



15D403 15D403

SECTION
SCALE: 1/8" = 1'-0"

15D403 15D403

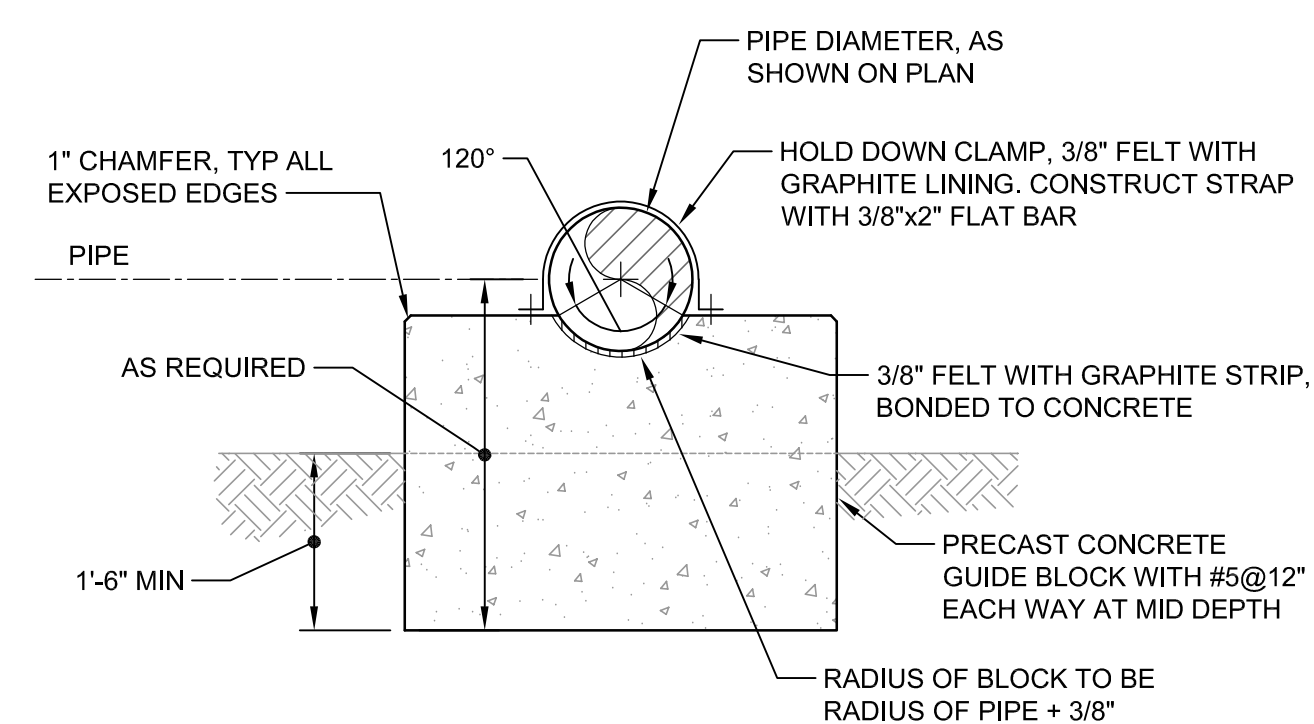


PLAN - PIPE SADDLE
SCALE: 1/8" = 1'-0"


15D403 2 15D403

SECTION - PIPE SADDLE
SCALE: 1/8" = 1'-0"

PLAN
SCALE: 1/8" = 1'-0"

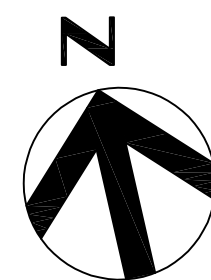[illegible]

PROJECT MANAGER	ERIC ORTON	P.E.
DESIGN BY	EEO	
DESIGN BY		
CHECKED BY		
DRAWN BY	ACB	
PLOT DATE	May 18, 2023	
PROJECT NUMBER	10176455	

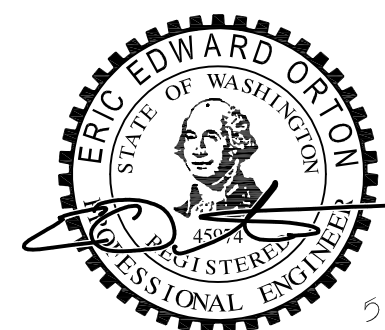

5/19/2023

KALAMA CREEK HATCHERY PHASE 2

**NATURAL RESOURCES DEPARTMENT
NISQUALLY INDIAN TRIBE
EDA AWARD NUMBER 07-79-07880**


CIRCULAR TANK BUILDING

PARTIAL PIPING PLAN AND MANHOLE SECTIONS




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SCALE	AS NOTED

15D403

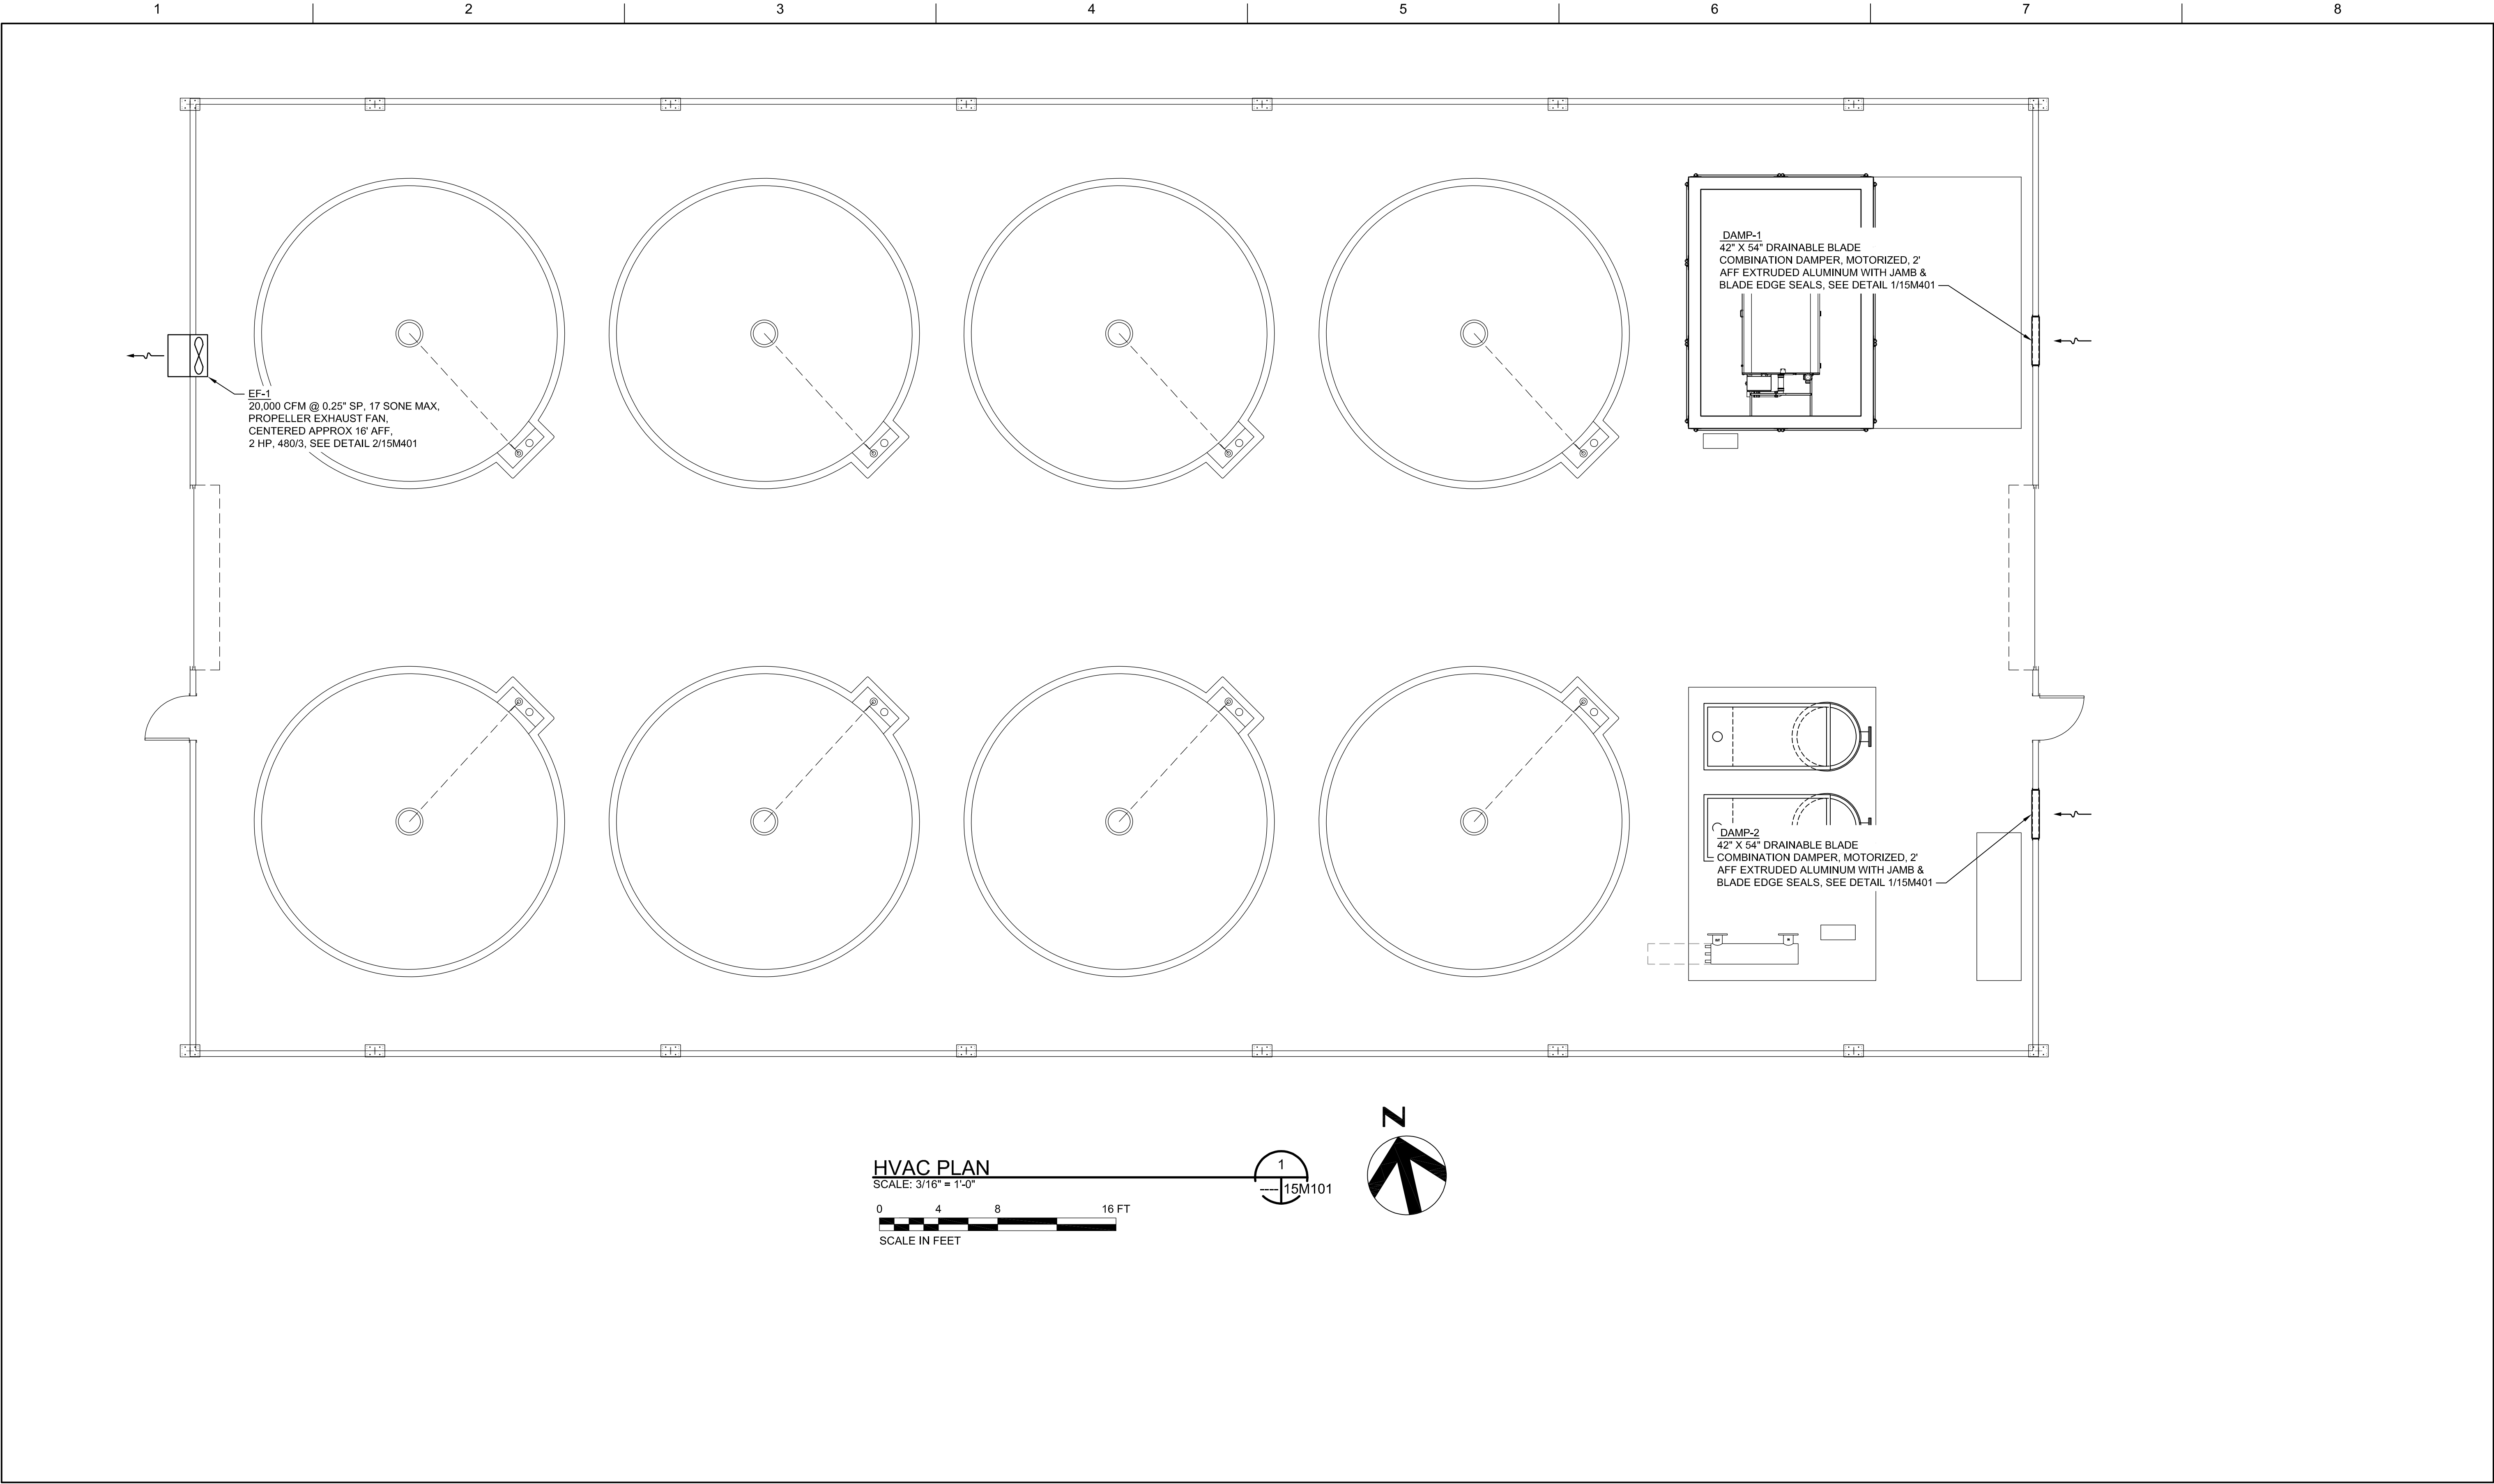


ISSUE	DATE	DESCRIPTION

PROJECT MANAGER	ERIC ORTON P.E.
DESIGN BY	EEO
DESIGN BY	
CHECKED BY	
DRAWN BY	ACB
PLOT DATE	May 18, 2023
PROJECT NUMBER	10176455

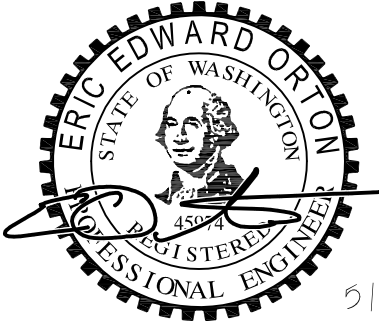


5/19/2023

**KALAMA CREEK HATCHERY
PHASE 2**
**NATURAL RESOURCES DEPARTMENT
NISQUALLY INDIAN TRIBE**
EDA AWARD NUMBER 07-79-07880

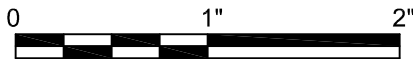

CIRCULAR TANK BUILDING
MECHANICAL PLAN
FILENAME | 15M101.DWG
SCALE | AS NOTED

SHEET
15M101

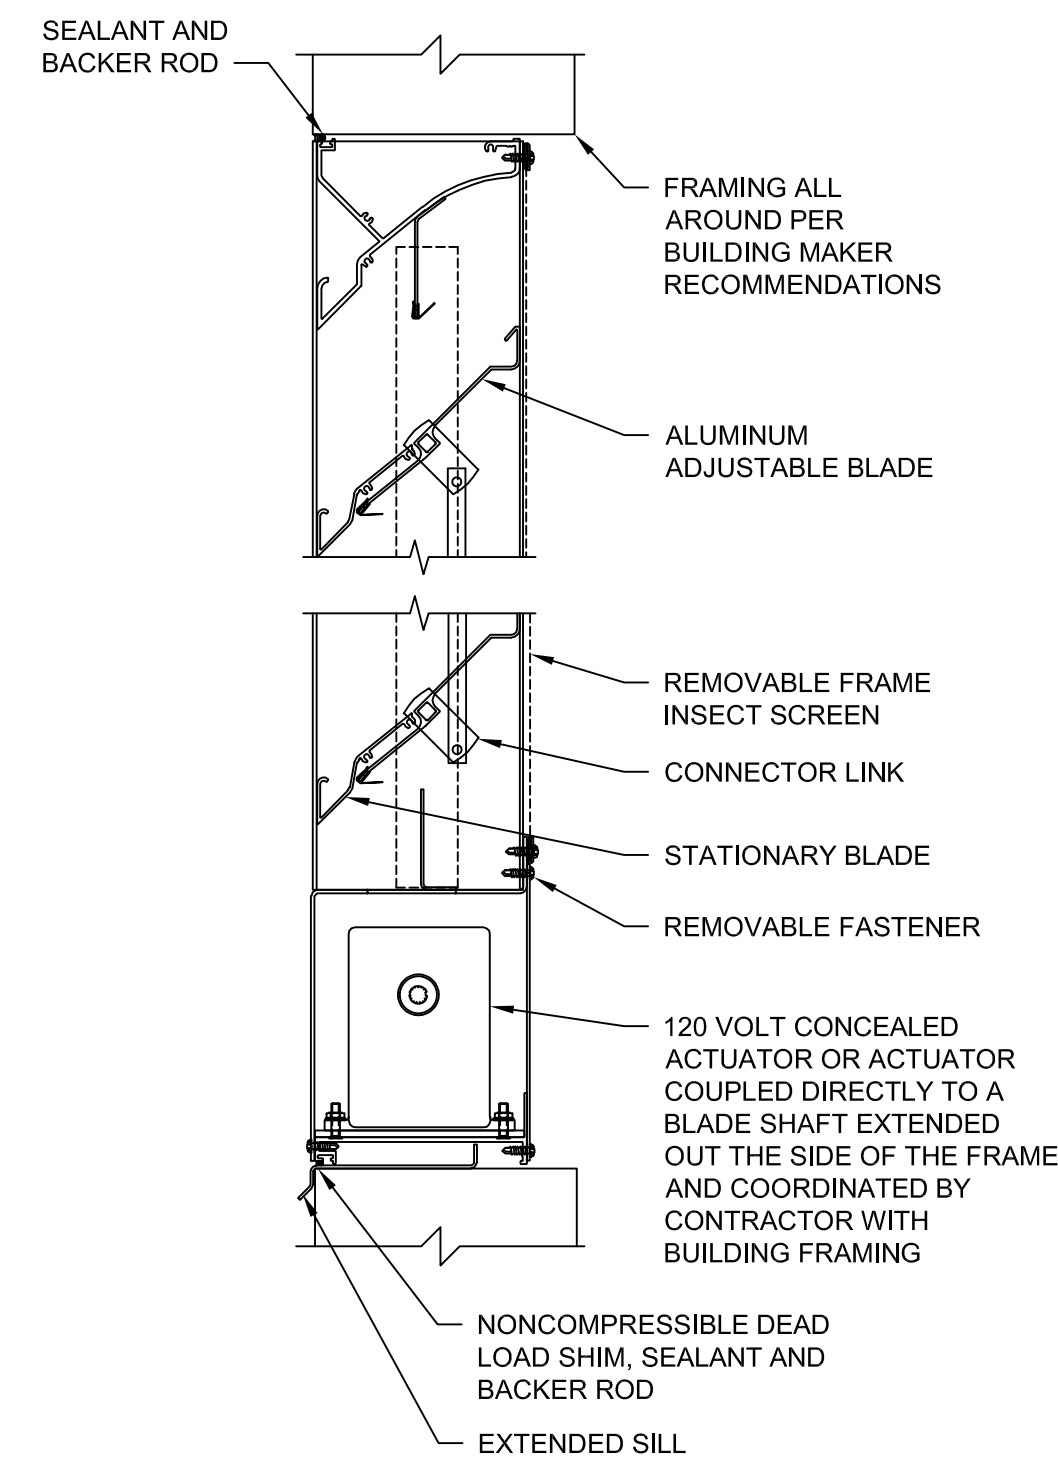

- FRAMING ALL AROUND PER BUILDING MAKER RECOMMENDATIONS

- ALUMINUM
ADJUSTABLE BLADE

- REMOVABLE FRAME
INSECT SCREEN

- CONNECTOR LINK

— STATIONARY BLADE

— REMOVABLE FASTENER

— 120 VOLT CONCEALED ACTUATOR OR ACTUATOR COUPLED DIRECTLY TO A BLADE SHAFT EXTENDED OUT THE SIDE OF THE FRAME AND COORDINATED BY CONTRACTOR WITH BUILDING FRAMING


- NONCOMPRESSIBLE DEAD LOAD SHIM, SEALANT AND BACKER ROD

- EXTENDED SILL

COMBINATION LOUVER SECTION
NOT TO SCALE

NOT TO SCALE

15M101	15M401
--------	--------

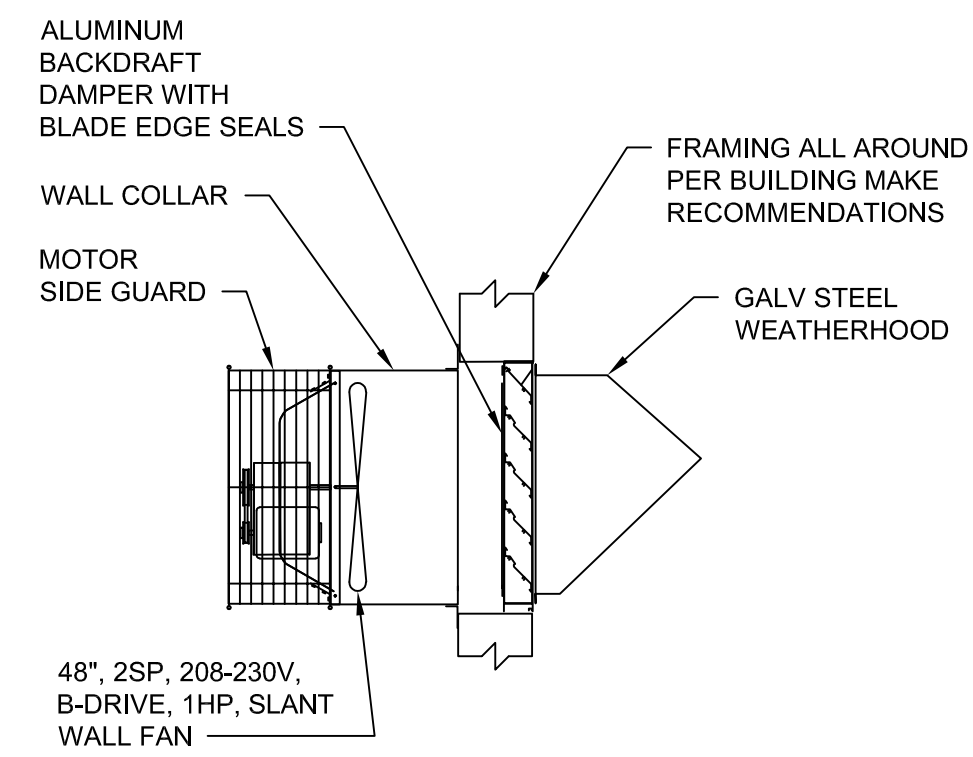

WALL COLLAR

MOTOR
SIDE GUARD -

48", 2SP, 208-230V,
B-DRIVE, 1HP, SLANT
WALL FAN _____

- FRAMING ALL AROUND PER BUILDING MAKE RECOMMENDATIONS

- GALV STEEL
WEATHERHOOD


EXHAUST FAN SECTION
NOT TO SCALE

NOT TO SCALE

15M101	15M401
--------	--------

[illegible]

PROJECT MANAGER	ERIC ORTON	P.E.
DESIGN BY	EEO	
DESIGN BY		
CHECKED BY		
DRAWN BY	ACB	
PLOT DATE	May 18, 2023	
PROJECT NUMBER	10176455	

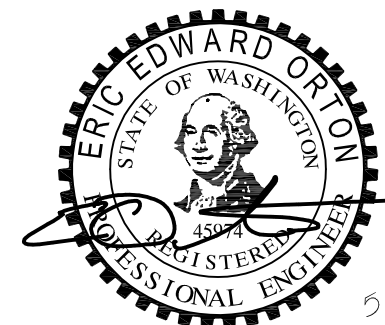

5/19/2022

**KALAMA CREEK HATCHERY
PHASE 2**

**NATURAL RESOURCES DEPARTMENT
NISQUALLY INDIAN TRIBE**

EDA AWARD NUMBER 07-79-07880

PHASE 2

**NATURAL RESOURCES DEPARTMENT
NISQUALLY INDIAN TRIBE**

EDA AWARD NUMBER 07-79-07880

POLLUTION ABATEMENT POND

SECTIONS



FILENAME	15M401.DWG
SCALE	AS NOTED


SHEET
15M401

GENERAL NOTES:

1. ALL INDOOR ELECTRICAL ENCLOSURES SHALL BE RATED NEMA 4, PAINTED STEEL, UNLESS NOTED OTHERWISE.
2. ALL OUTSIDE ELECTRICAL ENCLOSURES SHALL BE RATED NEMA 4X, STAINLESS STEEL.
3. ALL RECEPTACLES SHALL BE GFCI TYPE, MOUNTED IN A CAST BOX, AND WITH W.P. COVER. INSTALL 24" AFF WITH SUITABLE MOUNT.

KEYED NOTES: (X)



1. SEE ONE-LINE DIAGRAM ON SHEET 04E401 FOR CONDUIT AND CONDUCTORS.
2. MANUFACTURER SUPPLIED CONTROLS.
3. MANUFACTURER SUPPLIED CABLES.
4. ARRANGE RACK-MOUNTED EQUIPMENT AS REQUIRED TO SUITE SITE CONDITIONS. SEE DETAIL 9 ON SHEET 01E401 FOR MODULAR SUPPORTS.
5. MOUNT RECEPTACLE ON EQUIPMENT RACK.
6. PROVIDE COMBINATION MOTOR STARTER (SIZE NEMA 1) WITH LOCKABLE DISCONNECT, CONTROL POWER TRANSFORMER, AND CONTROL SWITCHES IN NEMA 4 ENCLOSURE. SEE 15E105 FOR CONTROL SCHEMATICS
7. DRY-TYPE TRANSFORMER WITH NEMA 3R ENCLOSURE.
8. SEE SHEET 04E101 FOR FEED TO MDP201.

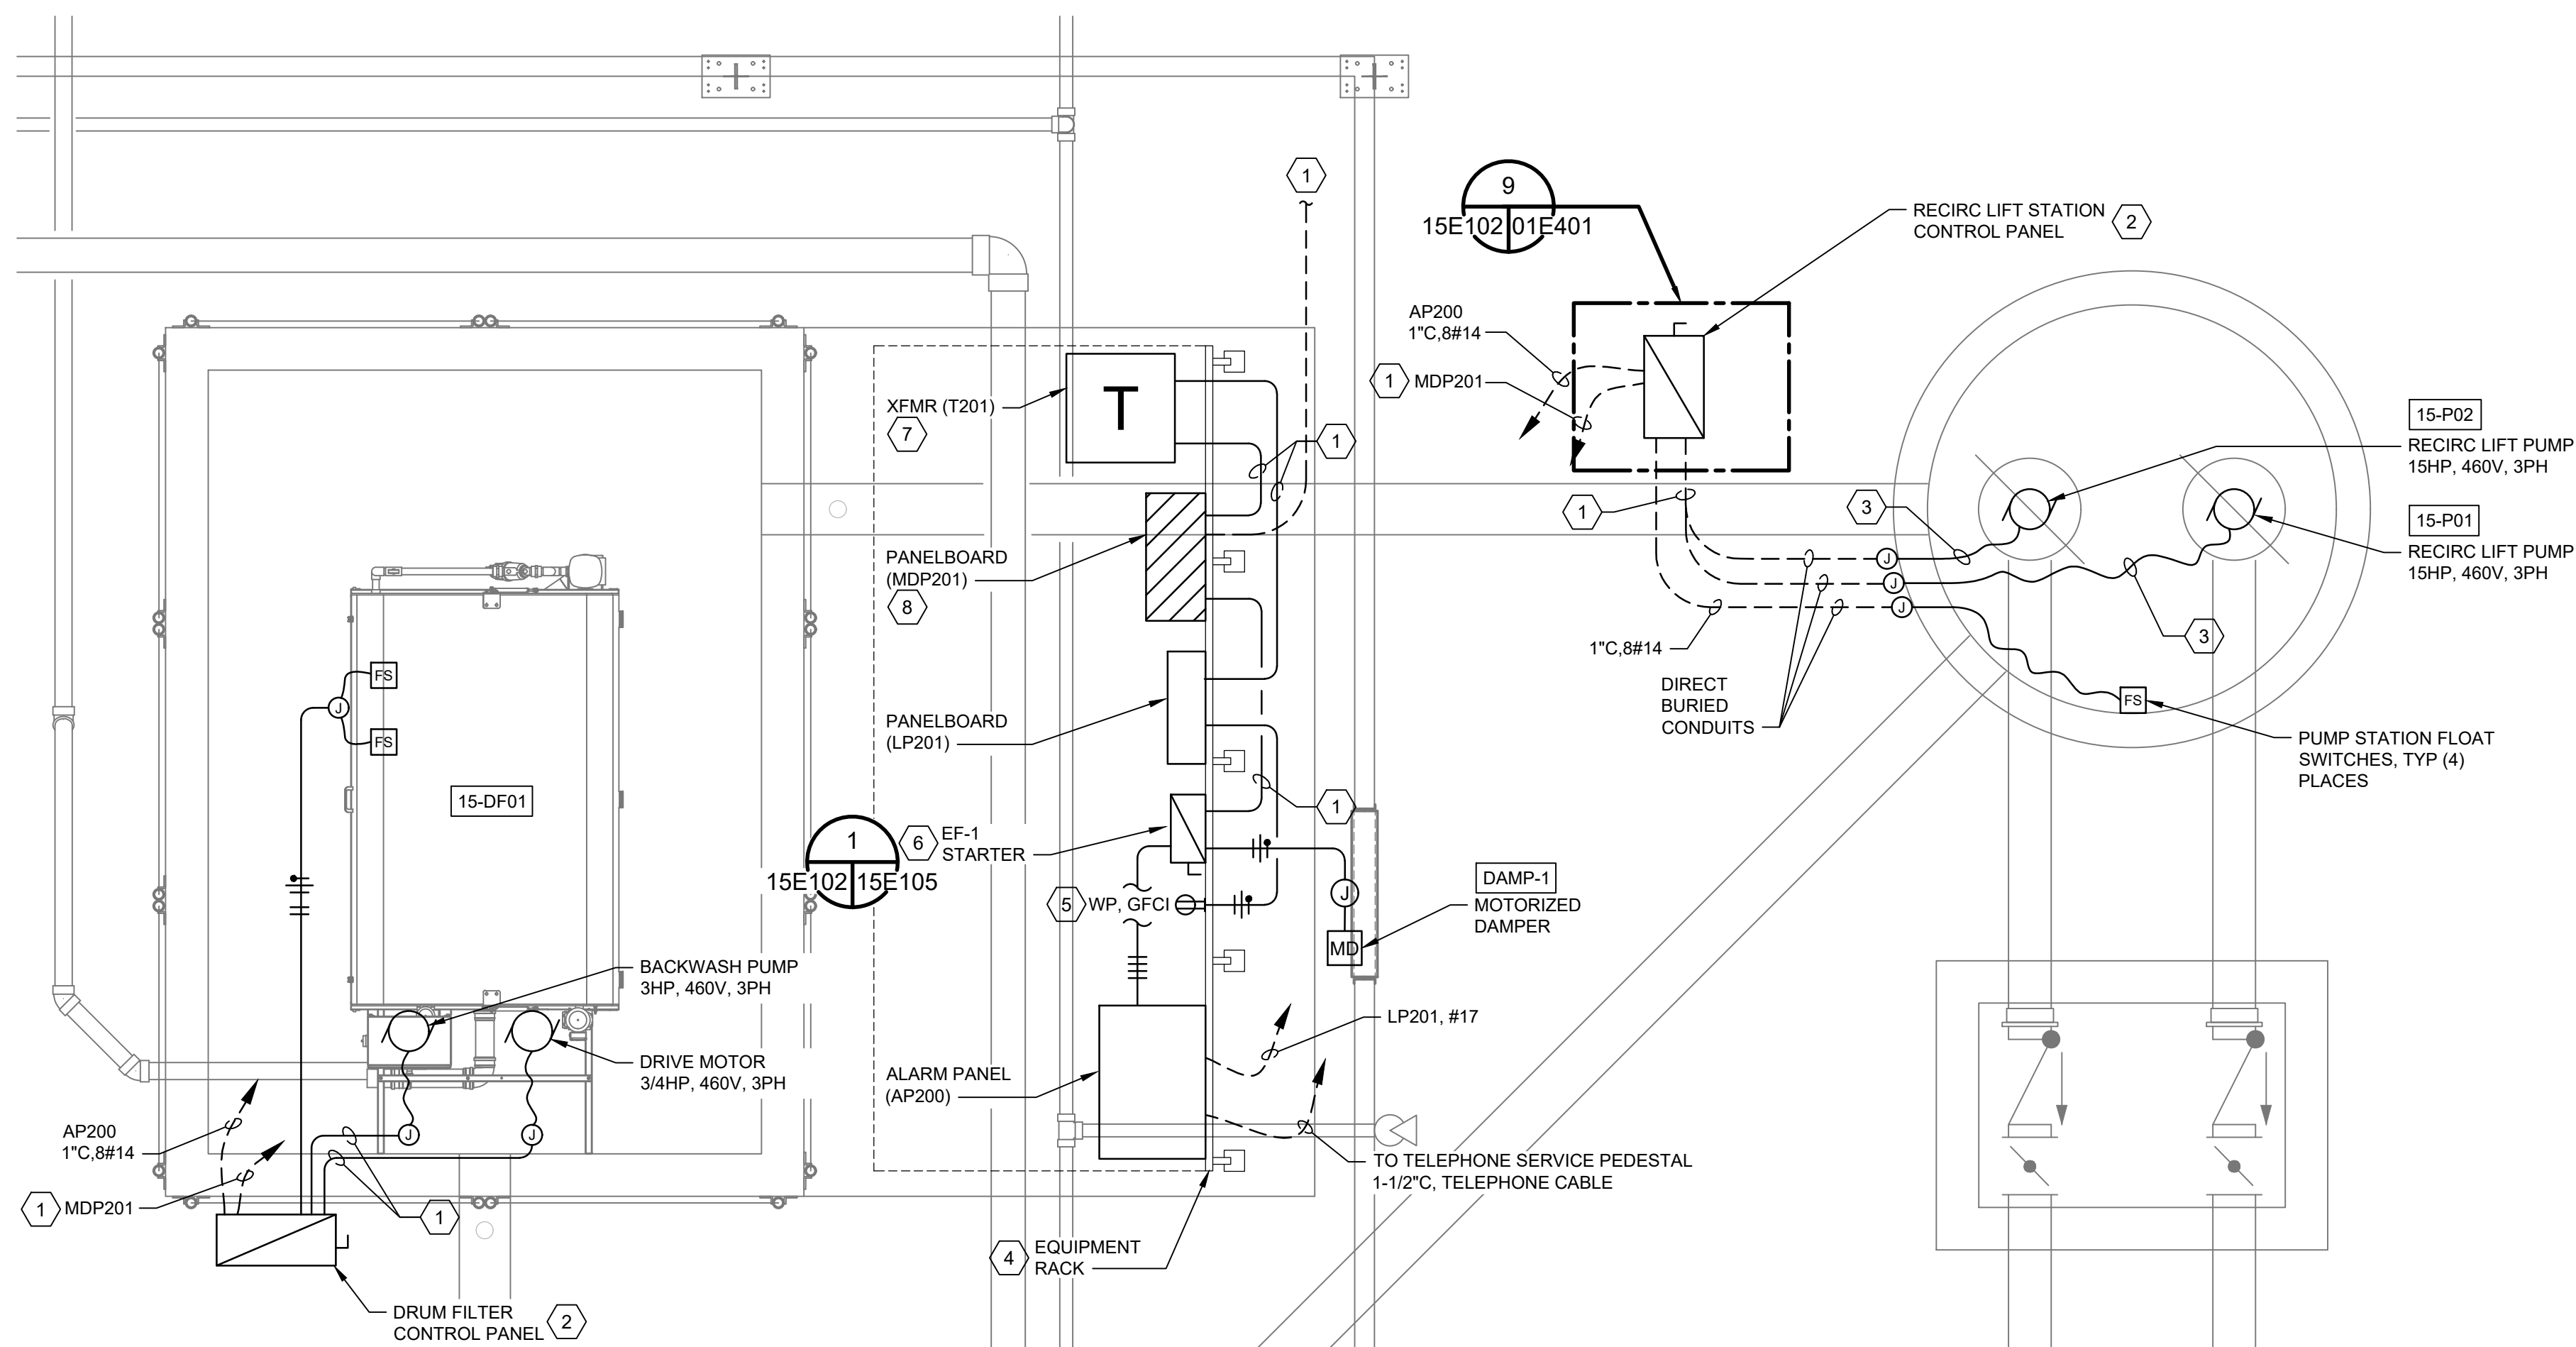

PARTIAL ELECTRICAL PLAN

SCALE: 3/8" = 1'-0"

15E101 15E102

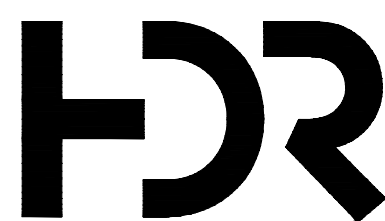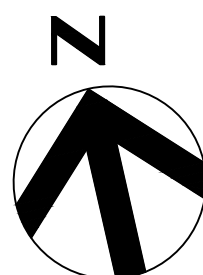

ISSUE	DATE	DESCRIPTION

PROJECT MANAGER ERIC ORTON, P.E.

DESIGN BY DB


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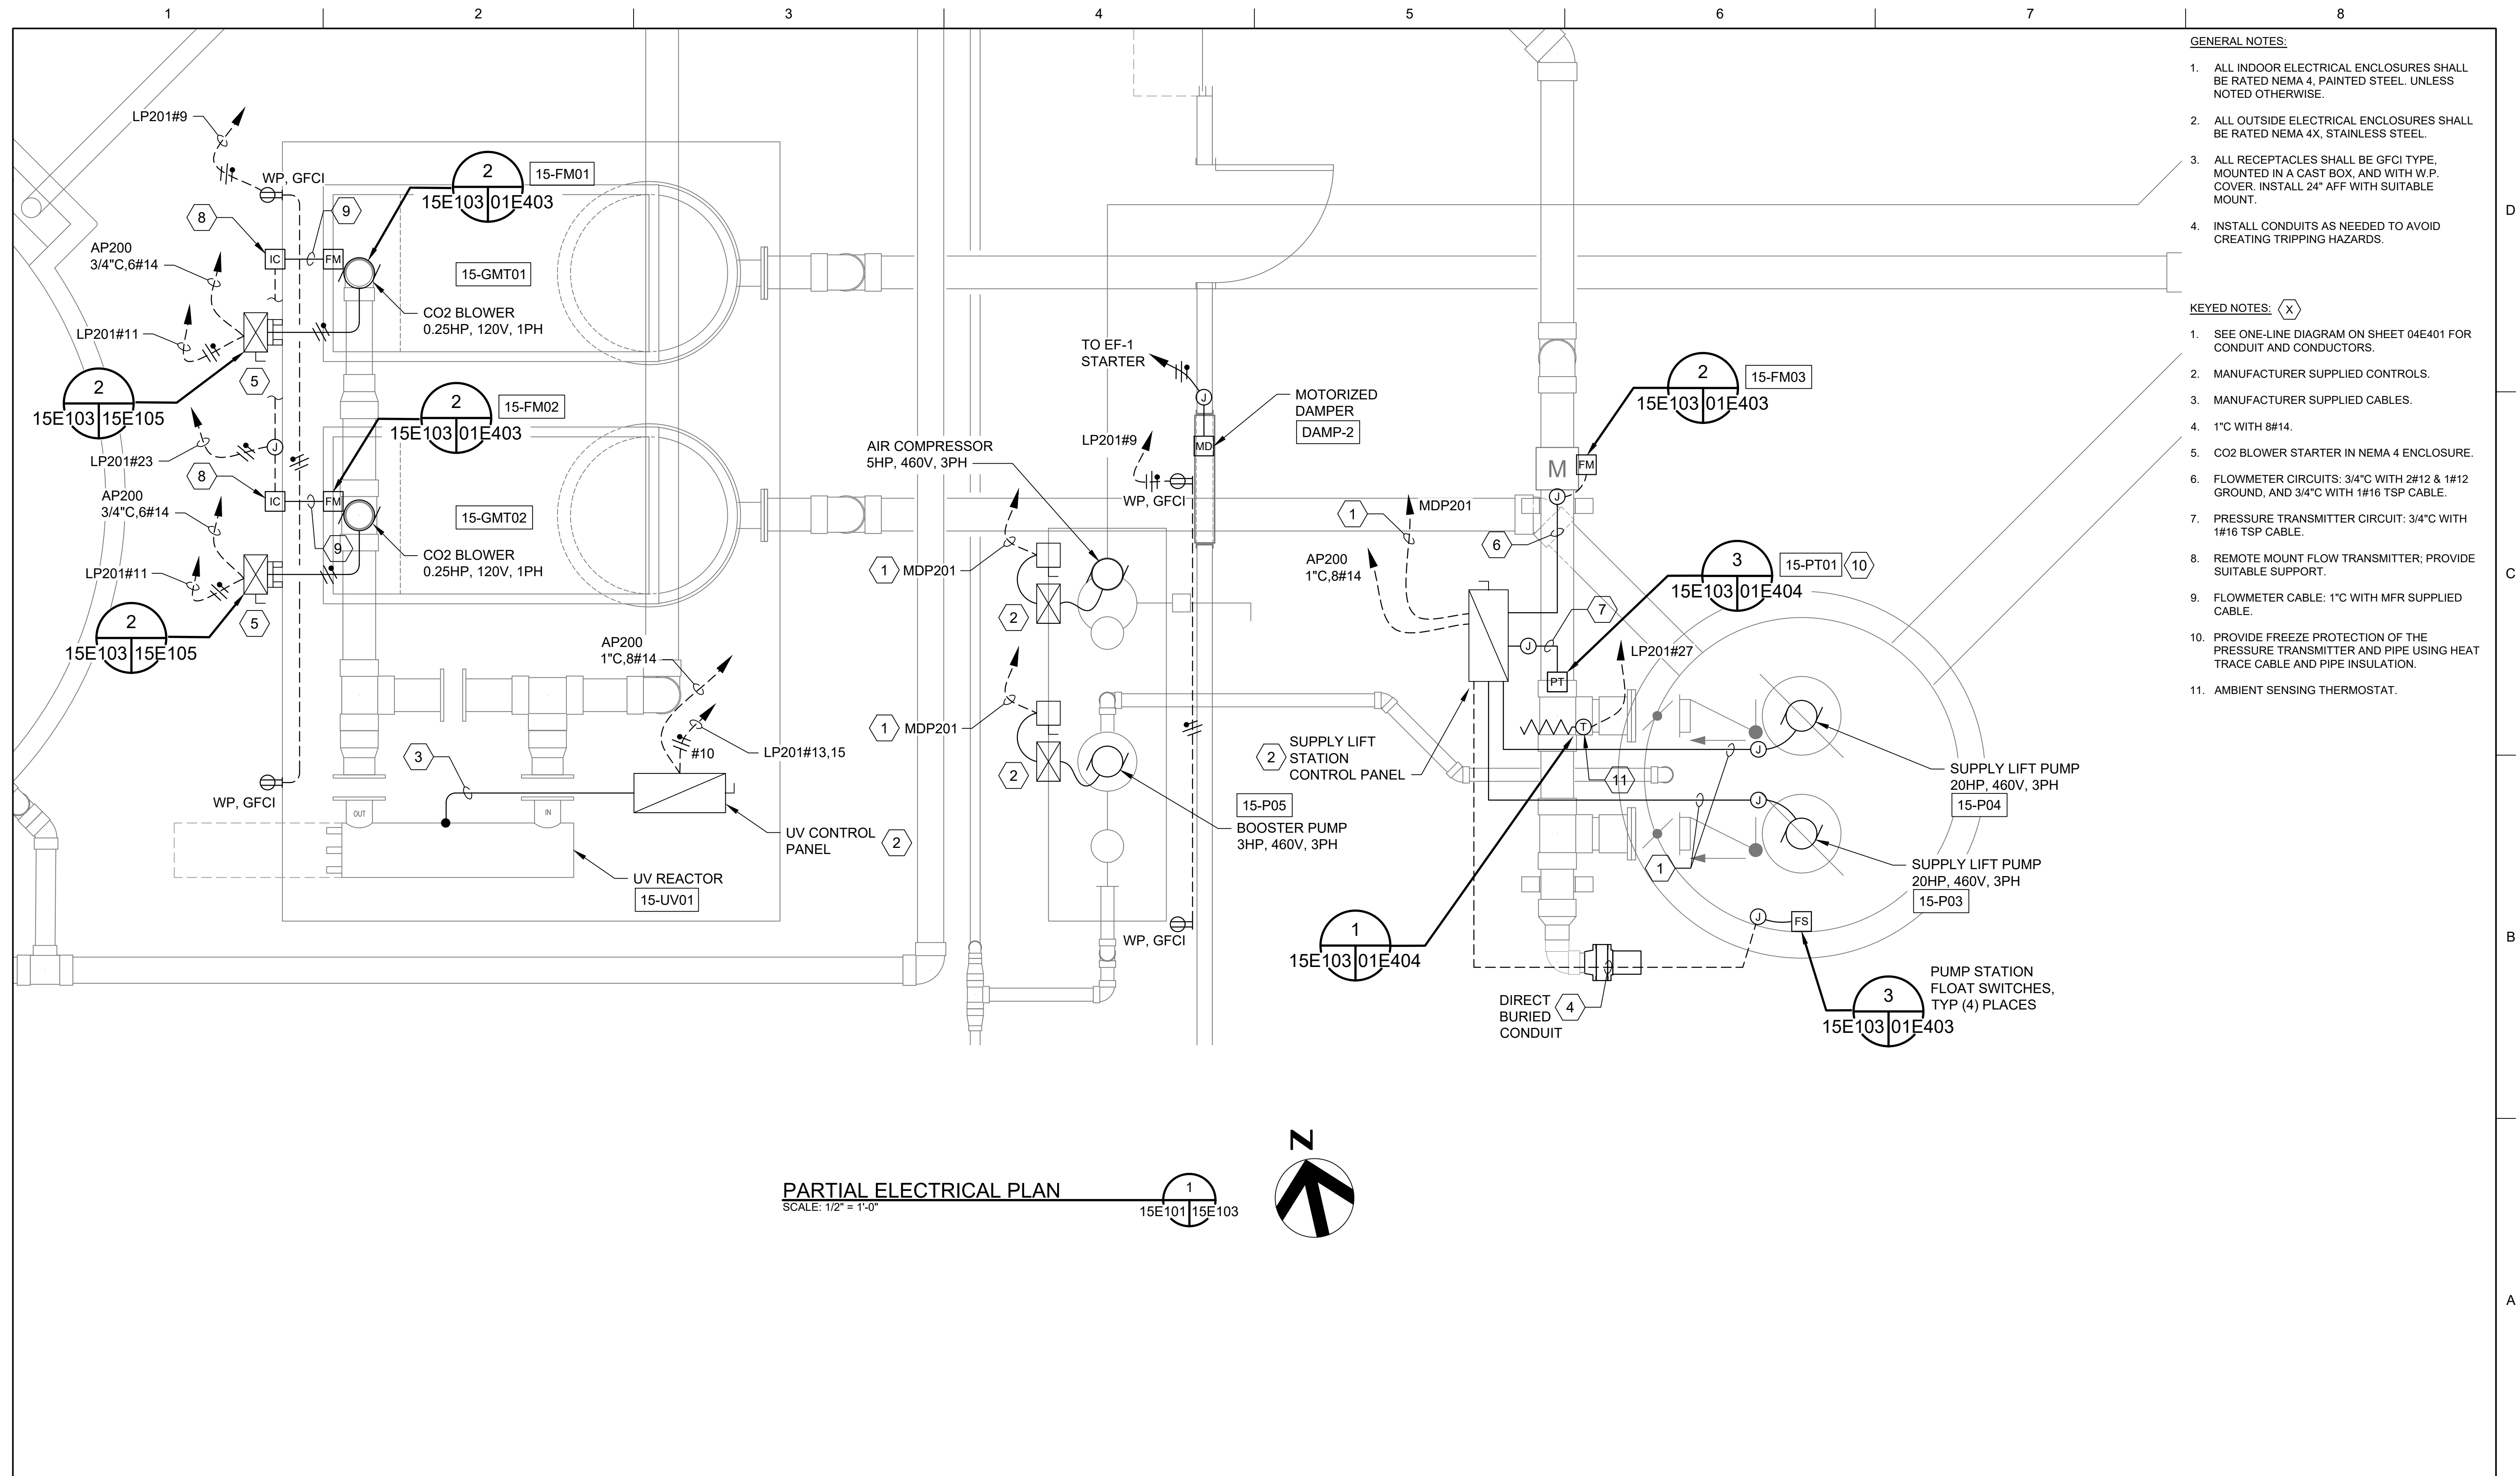
CHECKED BY TM

DRAWN BY EP

PLOT DATE May 18, 2023


PROJECT NUMBER 10176455

KALAMA CREEK HATCHERY
PHASE 2NATURAL RESOURCES DEPARTMENT
NISQUALLY INDIAN TRIBE
EDA AWARD NUMBER 07-79-07880CIRCULAR TANK BUILDING
PARTIAL ELECTRICAL PLAN 1FILENAME 15E102.DWG
SCALE AS NOTEDSHEET
15E102

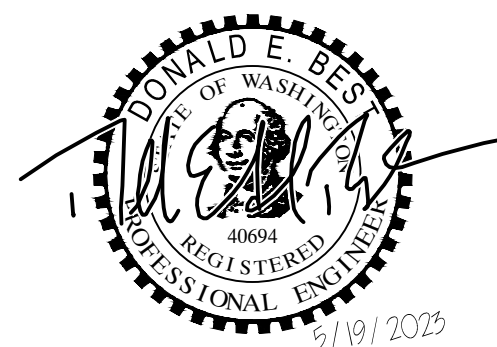


-	-	-
ISSUE	DATE	DESCRIPTION

PROJECT MANAGER	ERIC ORTON	P.E.
DESIGN BY	DB	
DESIGN BY		
CHECKED BY	TM	
DRAWN BY	EP	
PLOT DATE	May 18, 2023	
PROJECT NUMBER	10176455	

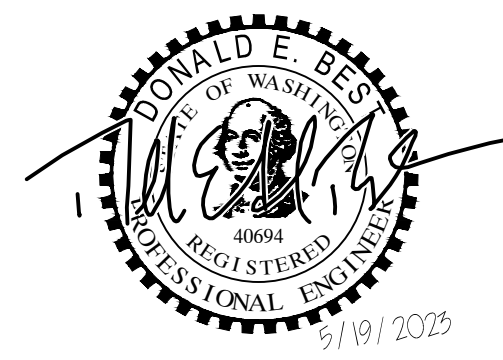


**KALAMA CREEK HATCHERY
PHASE 2
NATURAL RESOURCES DEPARTMENT
NISQUALLY INDIAN TRIBE
EDA AWARD NUMBER 07-79-07880**

CIRCULAR TANK BUILDING
PARTIAL ELECTRICAL PLAN 2

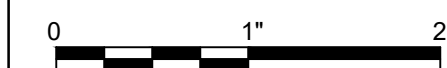

FILENAME	15E103.DWG
SCALE	AS NOTED

SHEET
15E103

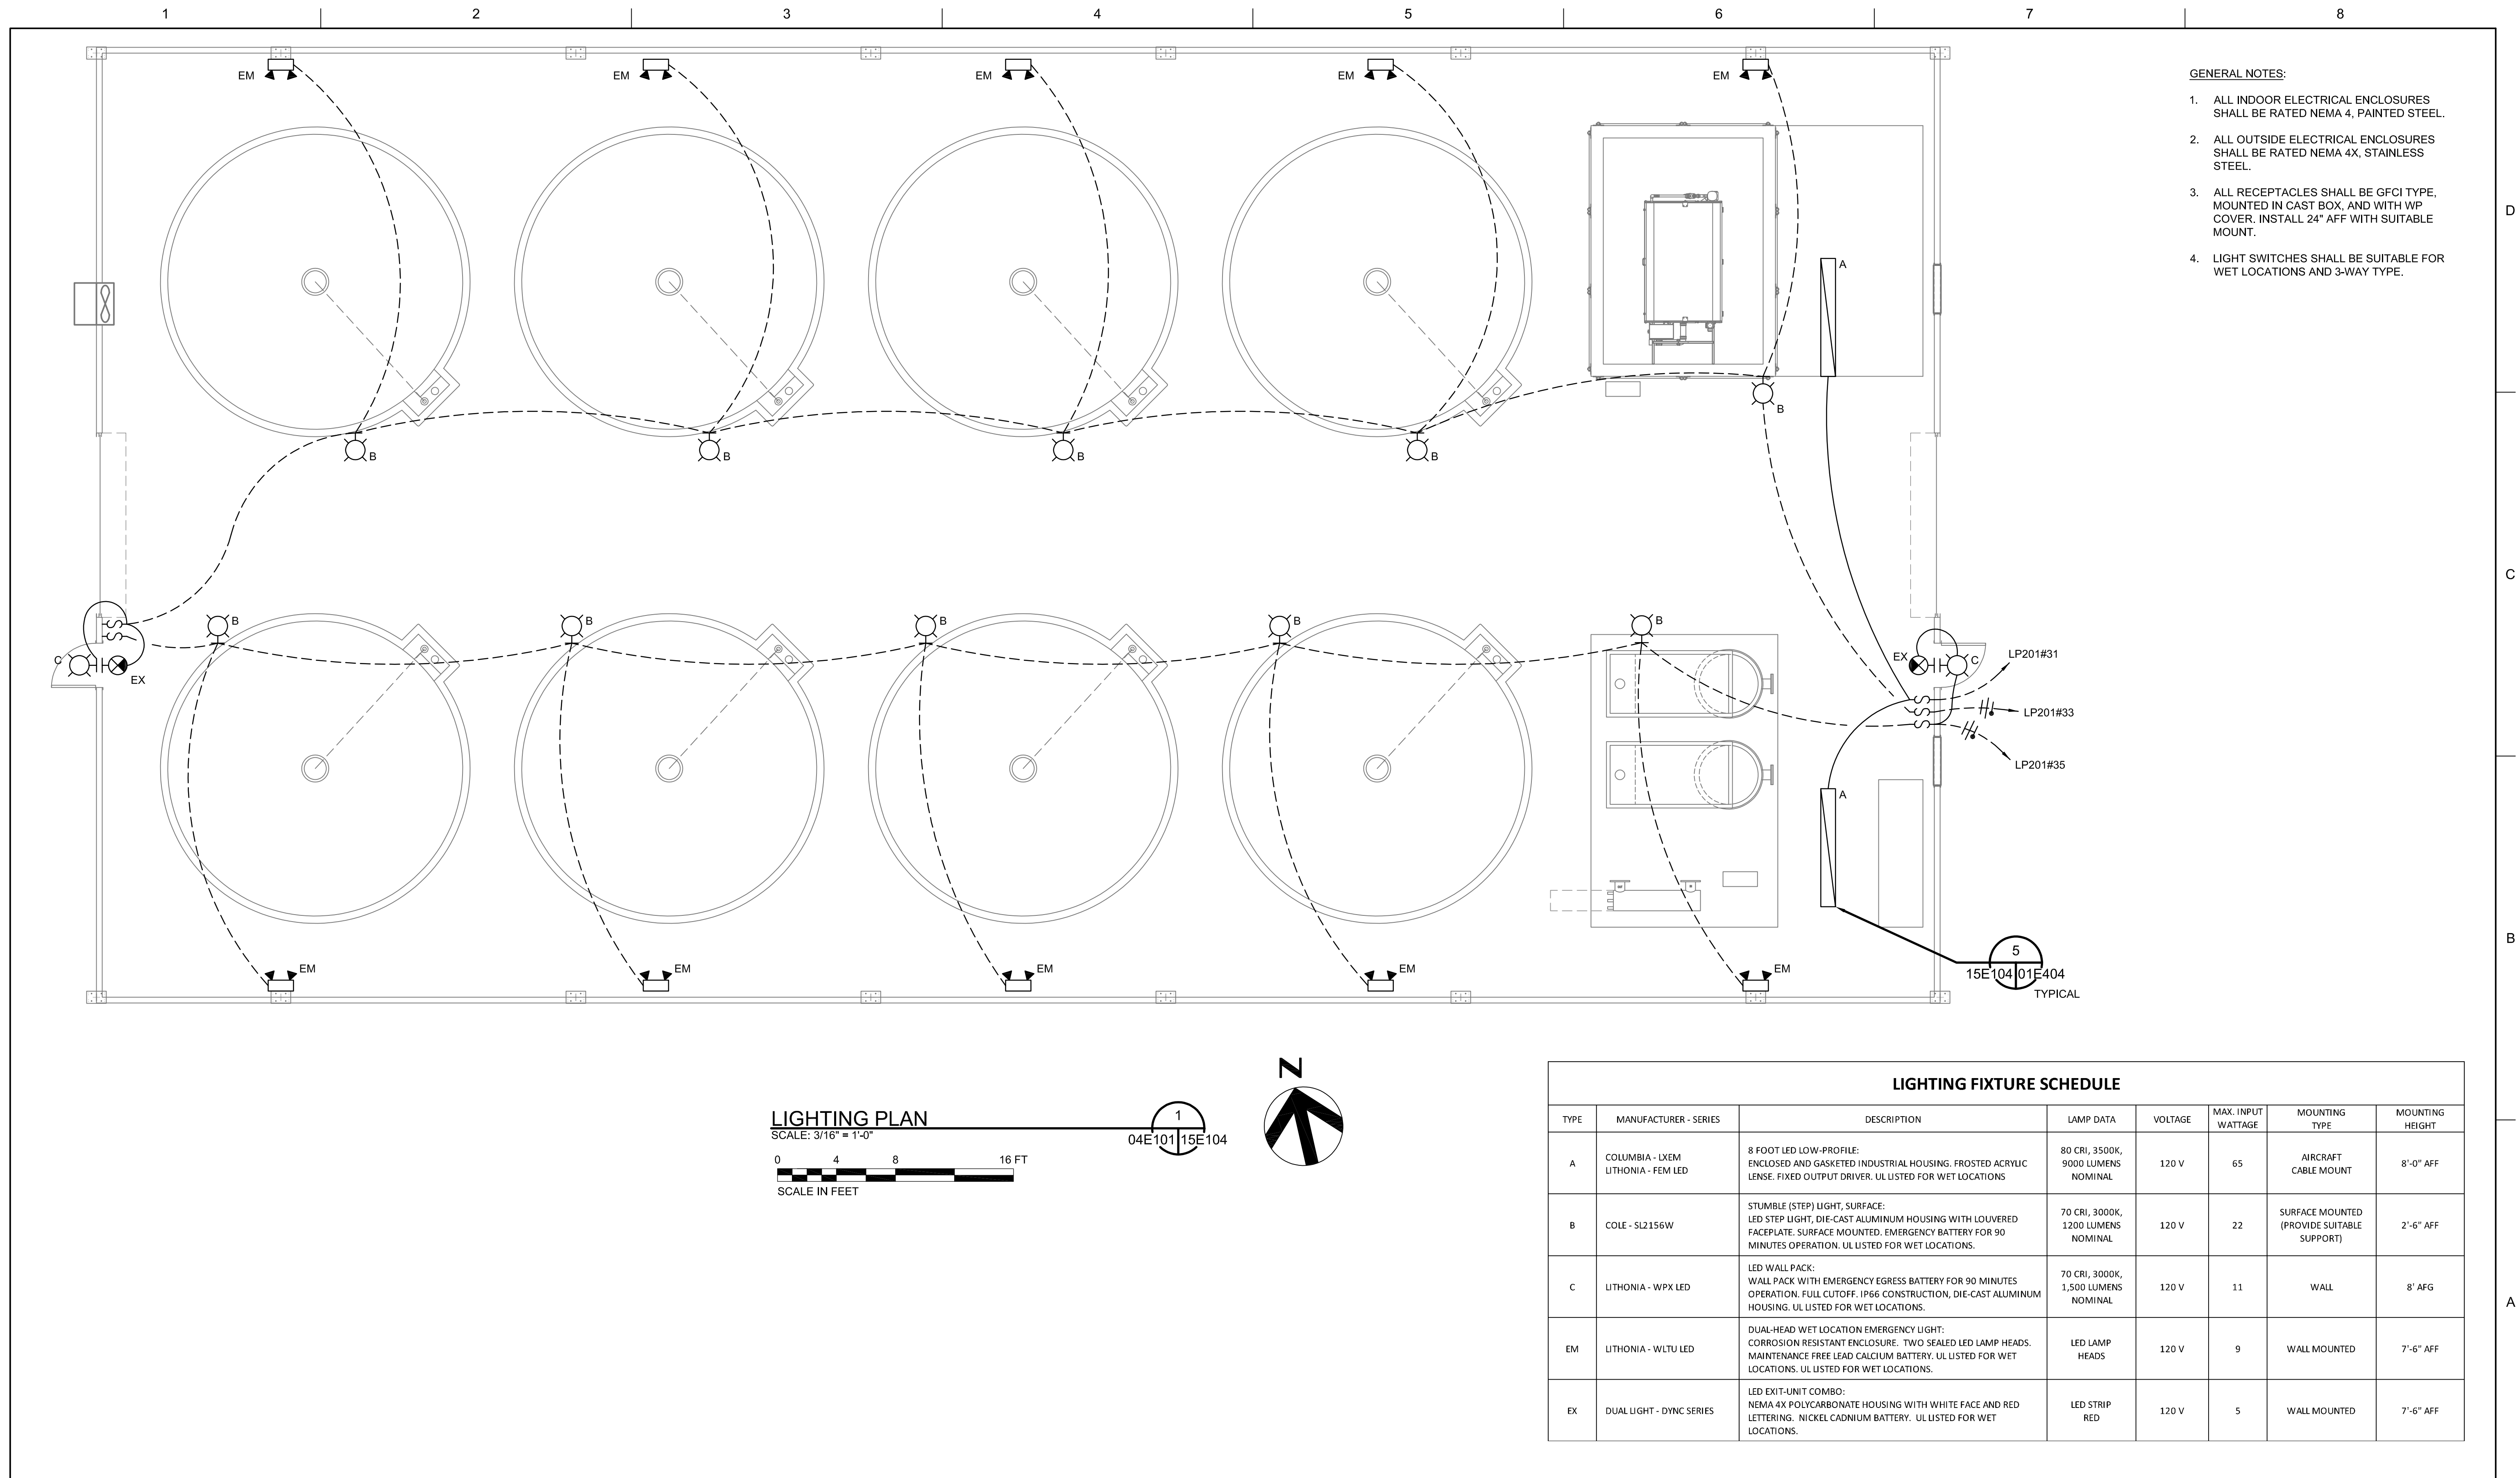[illegible]

PROJECT MANAGER	ERIC ORTON	P.E.
DESIGN BY		
DESIGN BY		
CHECKED BY		
DRAWN BY	JLC	
PLOT DATE	May 18, 2023	
PROJECT NUMBER	10176455	



**KALAMA CREEK HATCHERY
PHASE 2
NATURAL RESOURCES DEPARTMENT
NISQUALLY INDIAN TRIBE
EDA AWARD NUMBER 07-79-07880**


CIRCULAR TANK BUILDING

LIGHTING PLAN



FILENAME	15E104.DWG
SCALE	AS NOTED


HEET
15E104

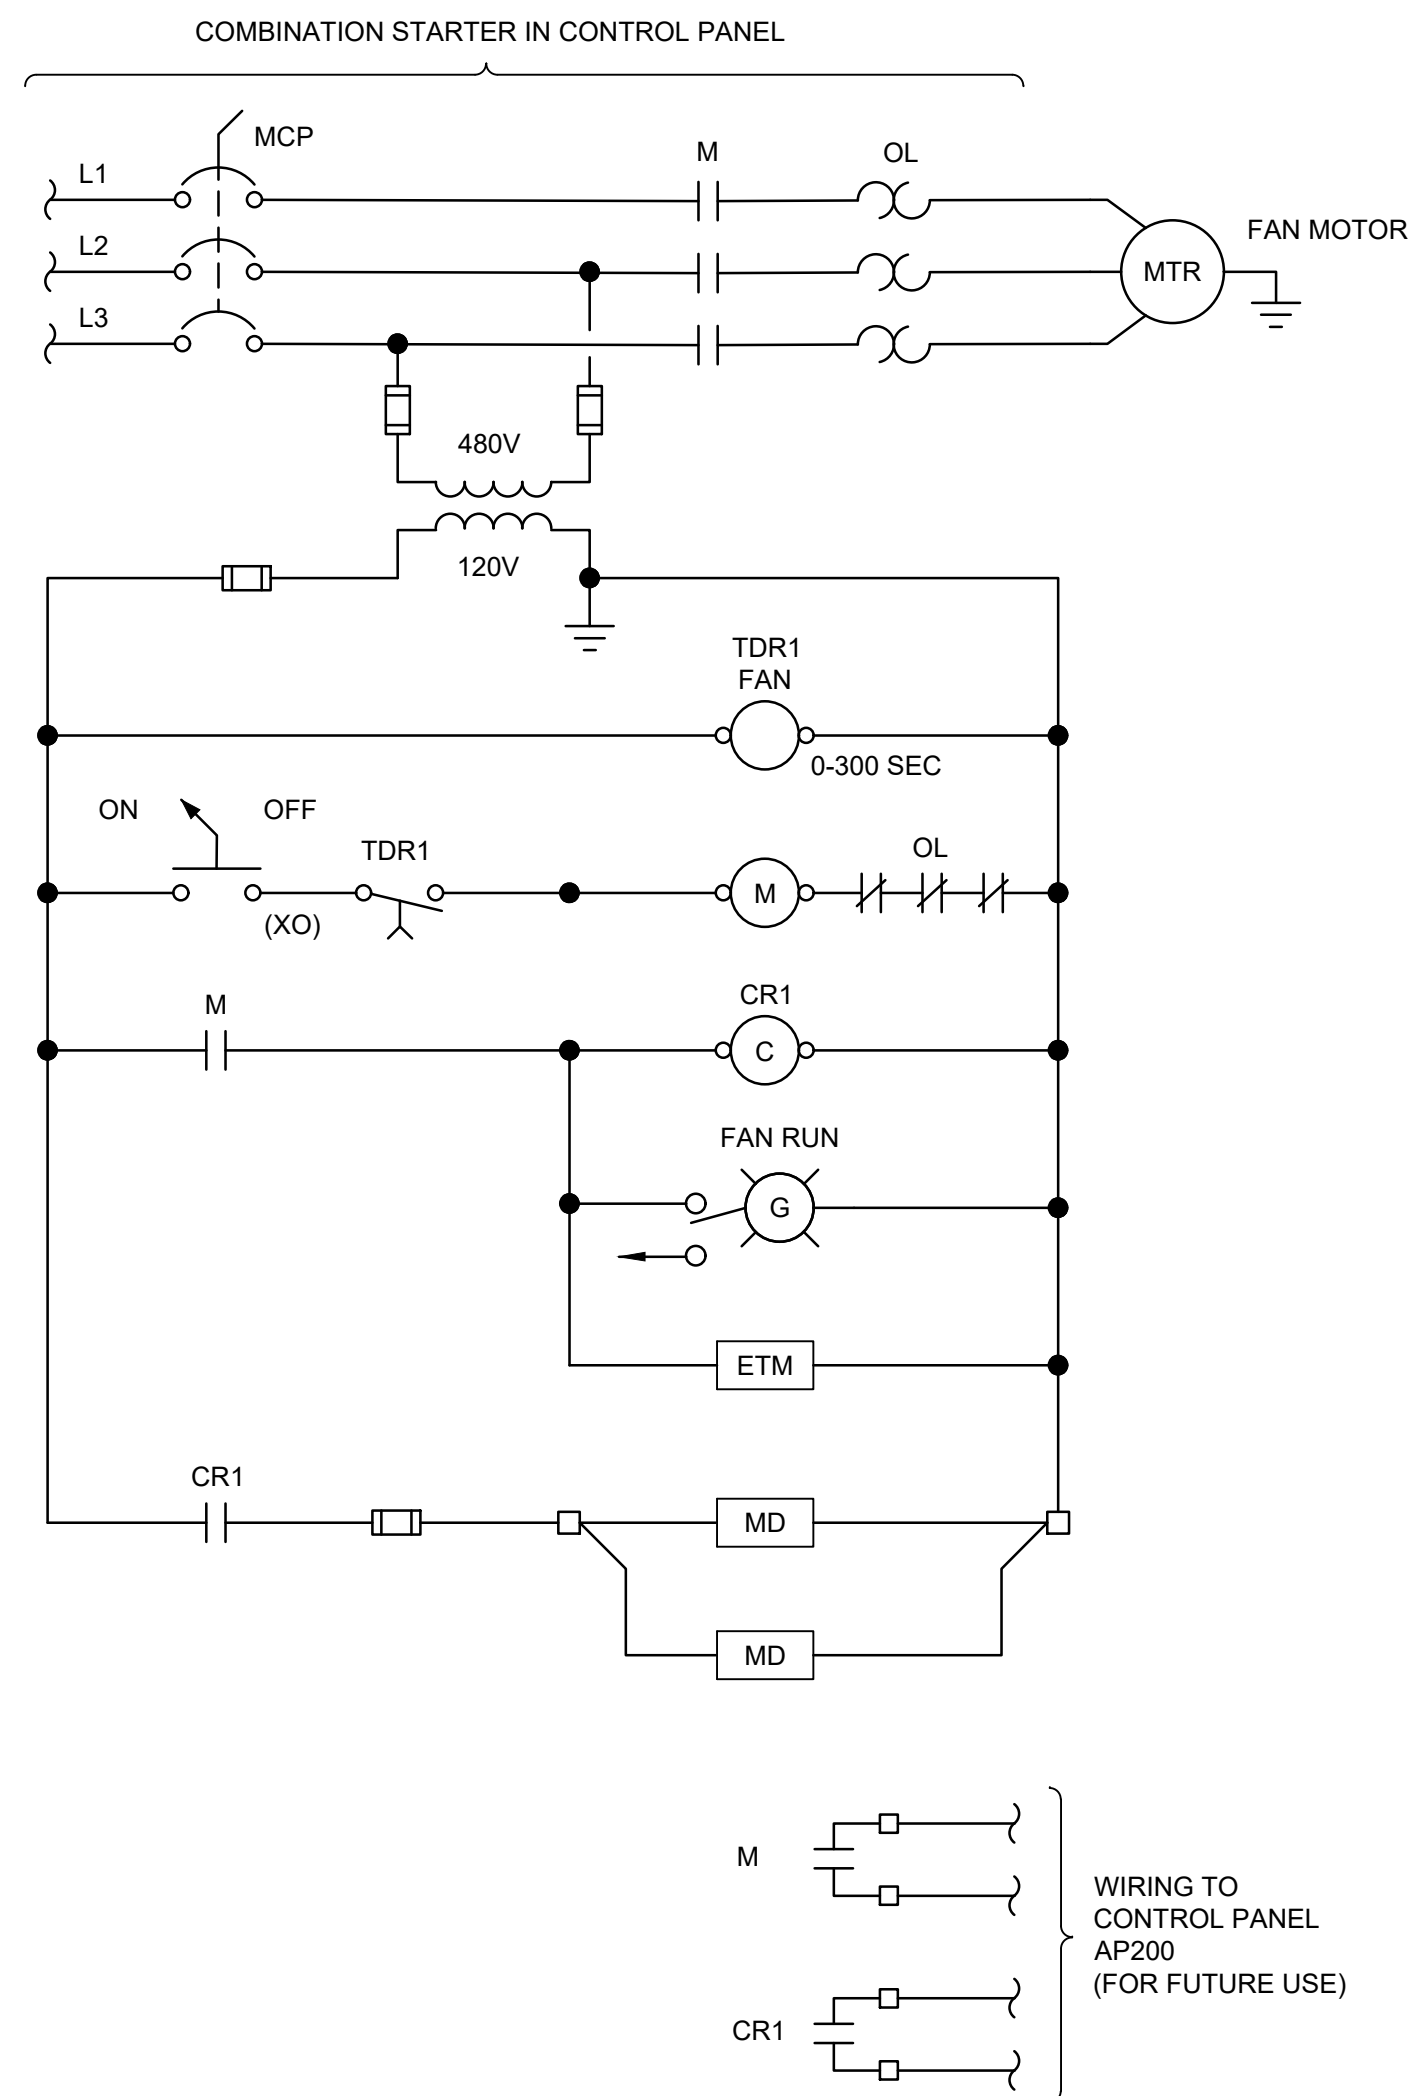

TYPICAL EXHAUST FAN EF-1
CONTROL DIAGRAM

SCALE: NONE


15E102 15E105

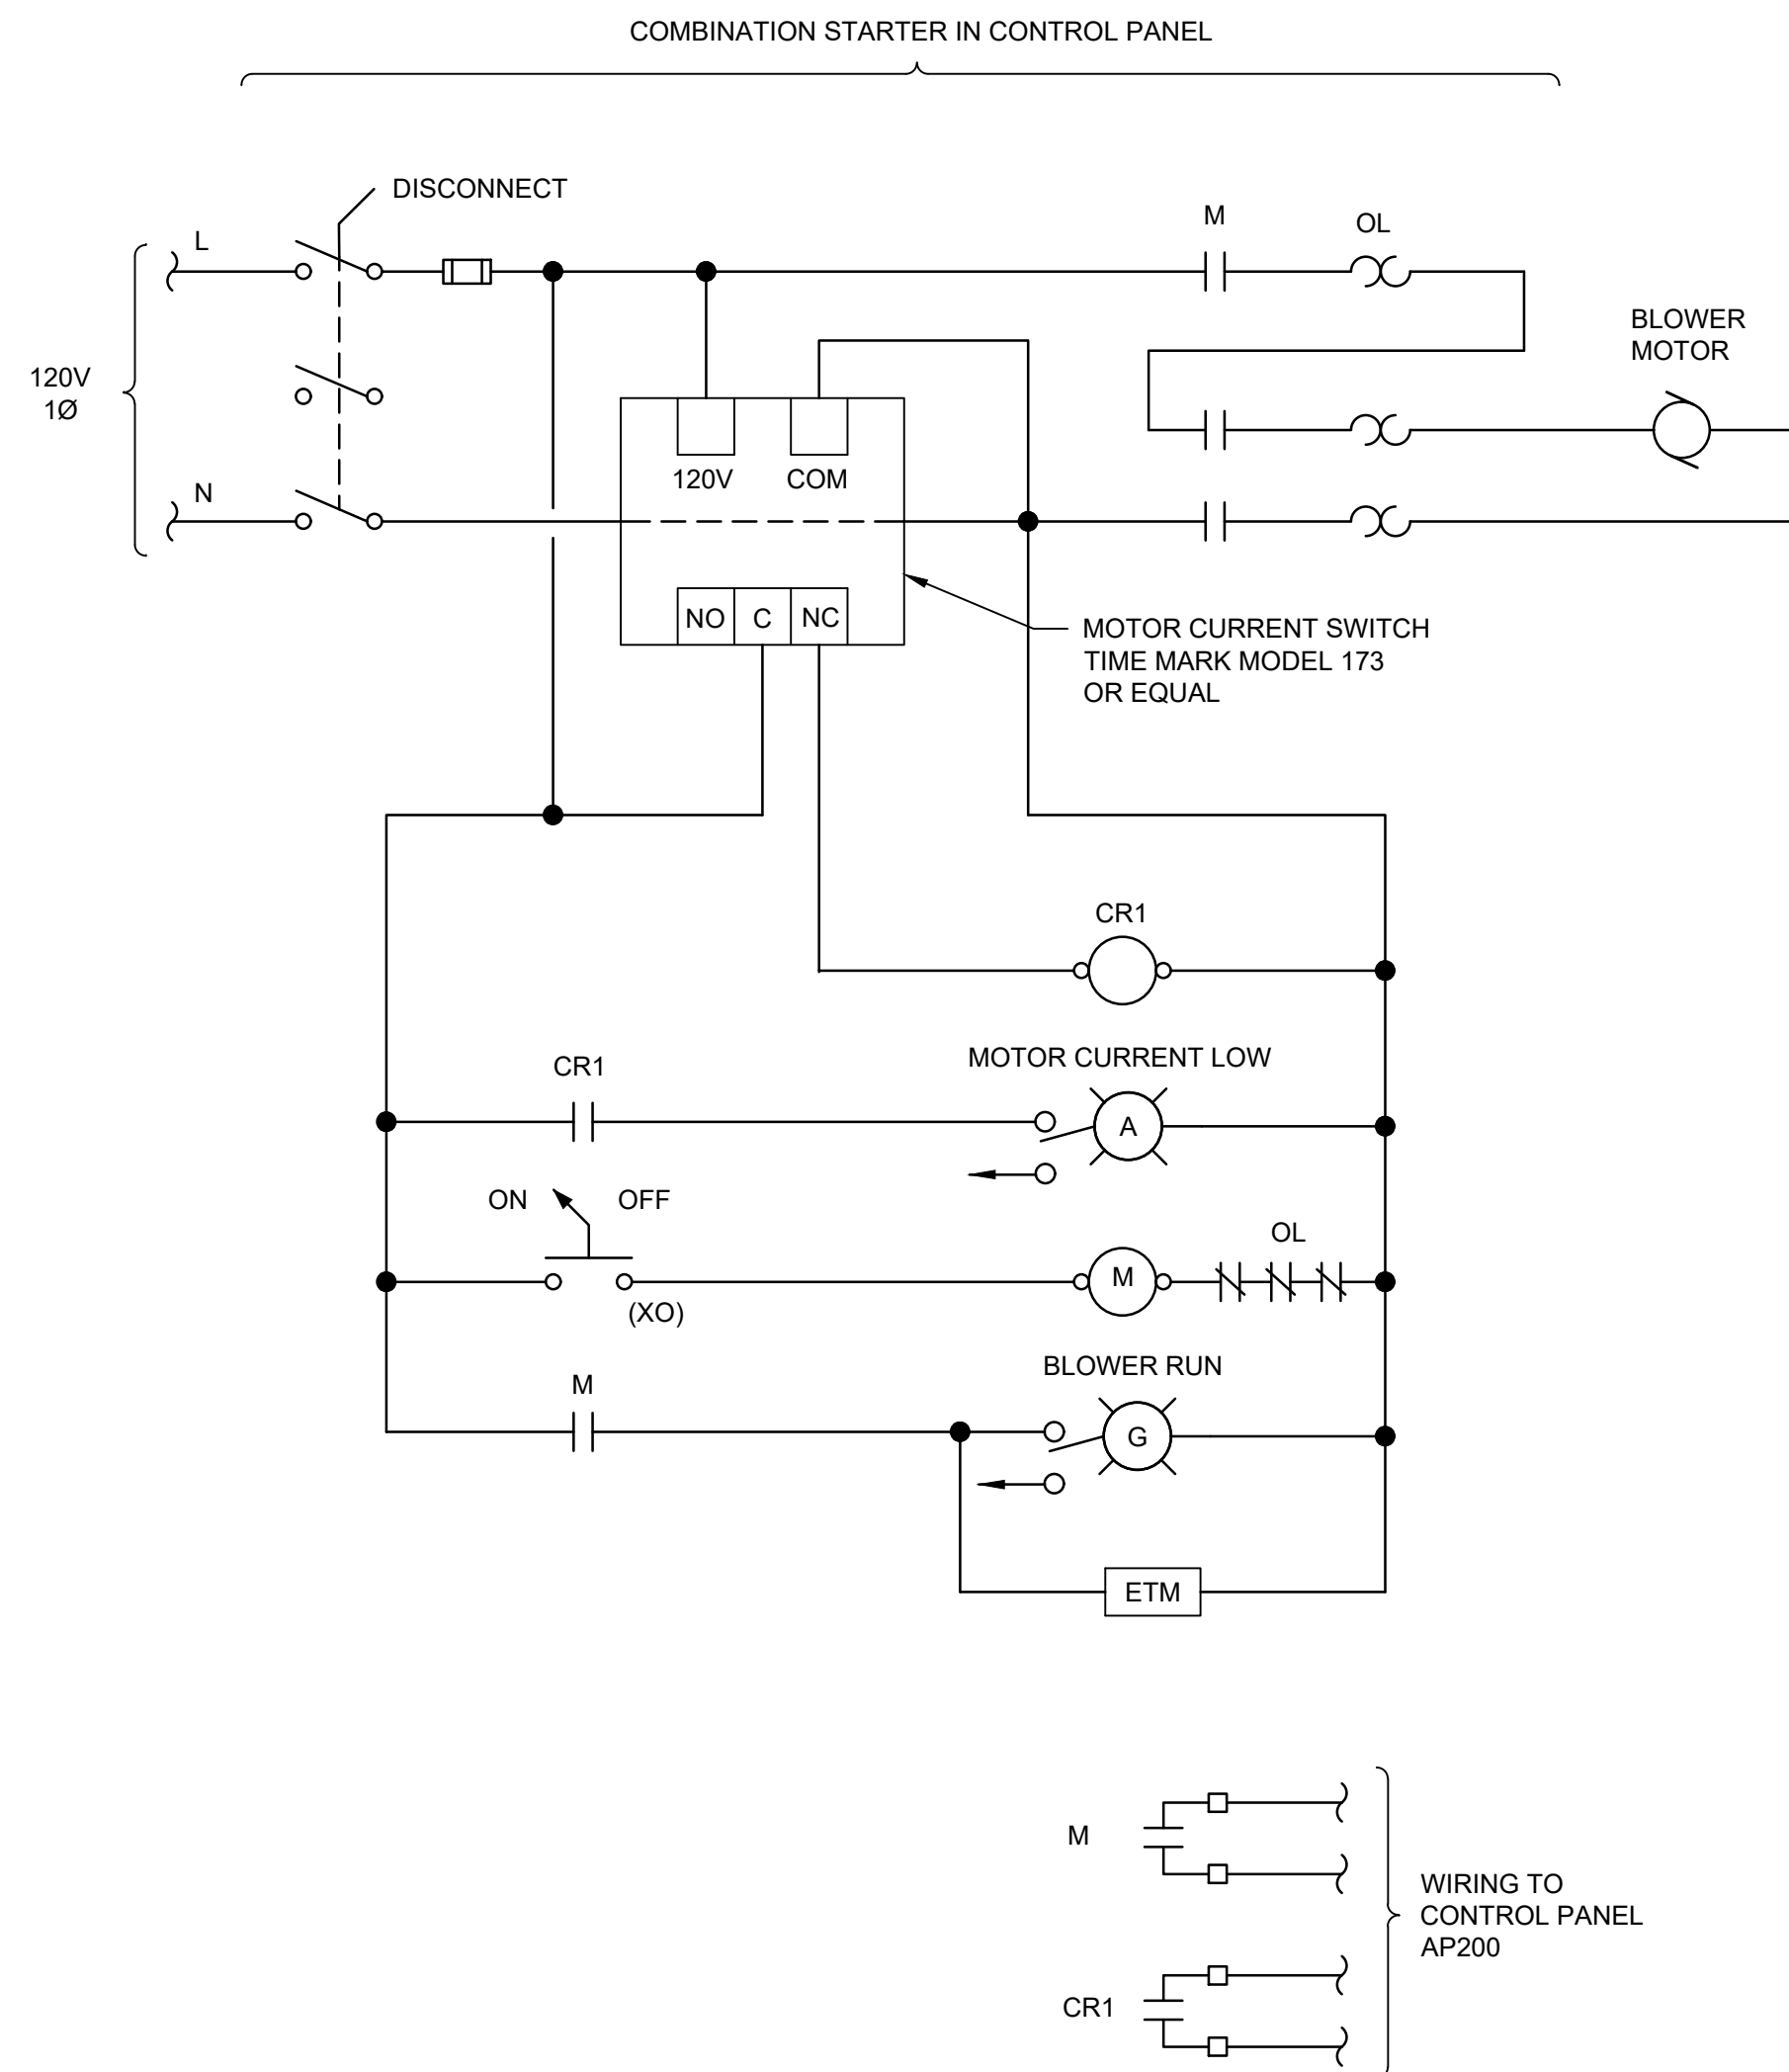

TYPICAL GAS BALANCING COLUMN
CO2 BLOWER CONTROL DIAGRAM


SCALE: NONE

15E102 15E105

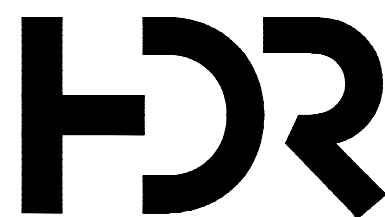

ISSUE	DATE	DESCRIPTION

PROJECT MANAGER	ERIC ORTON P.E.
DESIGN BY	DB
DESIGN BY	
CHECKED BY	TM
DRAWN BY	EP
PLOT DATE	May 18, 2023
PROJECT NUMBER	10176455

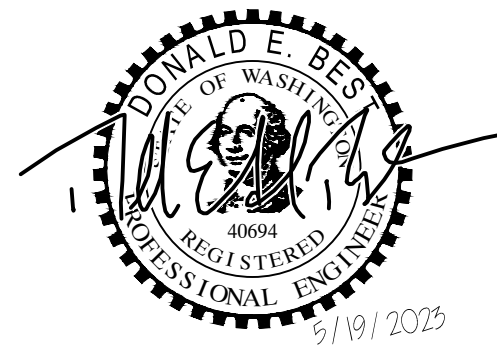


**KALAMA CREEK HATCHERY
PHASE 2**

**NATURAL RESOURCES DEPARTMENT
NISQUALLY INDIAN TRIBE**


EDA AWARD NUMBER 07-79-07880

**CIRCULAR TANK BUILDING
ELECTRICAL CONTROL DIAGRAMS**

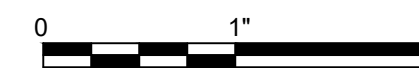

FILENAME | 15E105.DWG
SCALE | AS NOTED

SHEET
15E105

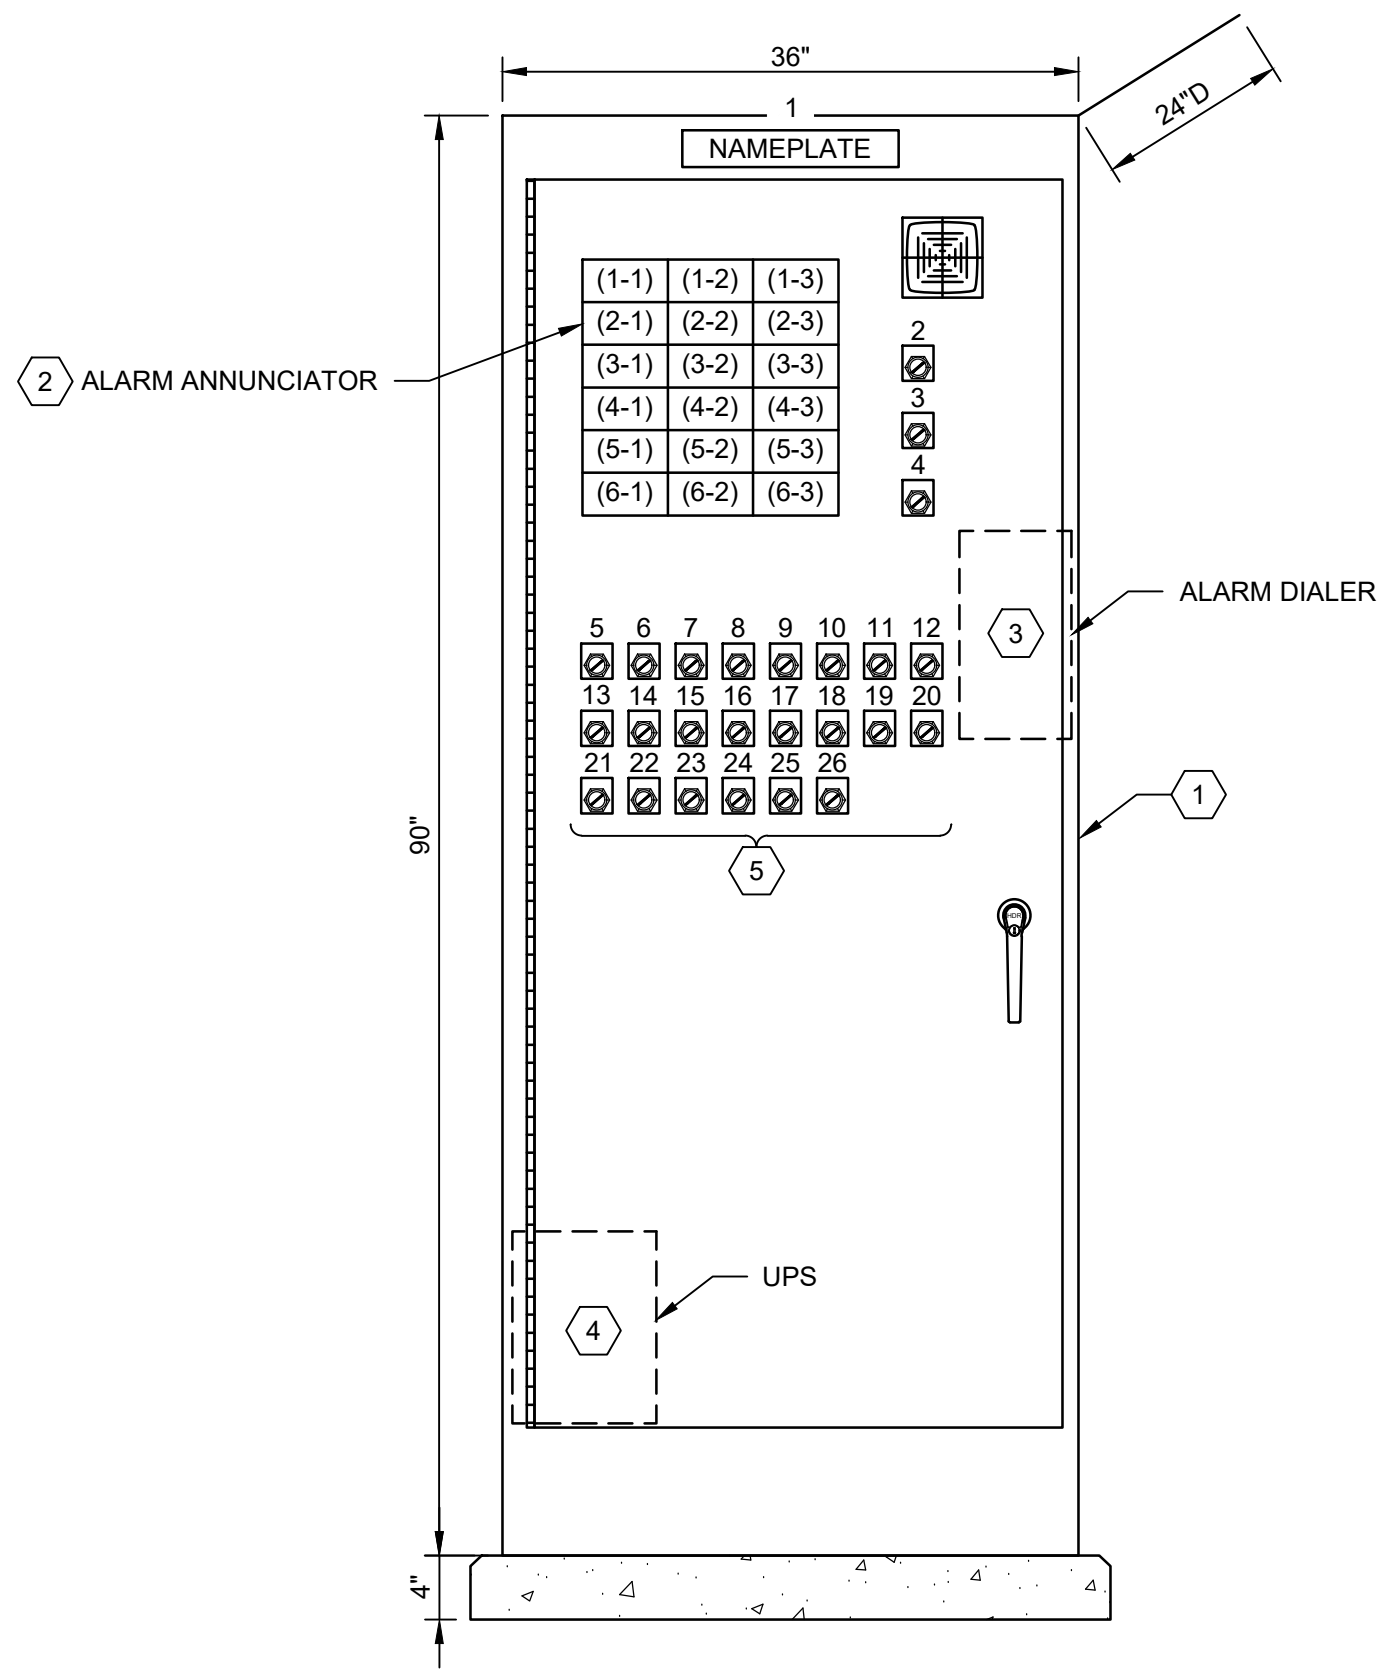

ANNUNCIATOR SCHEDULE		
ROW-COLUMN	FIRST LINE	SECOND LINE
1-1	CIRCULATION TANKS	LOW LEVEL
1-2	GAS TOWER	CO2 BLOWER FAULT
1-3	ELECTRIC UTILITY	LOSS OF POWER
2-1	CIRCULATION TANKS	LOW DISSOLVED OXYGEN
2-2	UV DISINFECTION	UNIT FAULT
2-3	DIESEL STANDBY	GENERATOR FAULT
3-1	SUPPLY LIFT	STATION FAULT
3-2	DRUM FILTER	FAULT
3-3	ATS IN STANDBY	POSITION
4-1	RECIRC LIFT	STATION FAULT
4-2	CONCRETE POND	LOW LEVEL
4-3	INTRUSION	ALARM
5-1	PA LIFT	STATION FAULT
5-2	(BLANK)	(BLANK)
5-3	(BLANK)	(BLANK)
6-1	(BLANK)	(BLANK)
6-2	(BLANK)	(BLANK)
6-3	(BLANK)	(BLANK)

AP200 CONTROL PANEL SCHEDULE			
ITEM	DESCRIPTION	SERVICE LEGEND	NAMEPLATE INSCRIPTION
1	NAMEPLATE		ALARM PANEL (AP200)
2	PUSHBUTTON	TEST	ANNUNCIATOR
3	PUSHBUTTON	ACK	ANNUNCIATOR
4	PUSHBUTTON	RESET	ANNUNCIATOR
5	SELECTOR, 2-POS	ENABLE/DISABLE	TANK 1 LOW LEVEL
6	SELECTOR, 2-POS	ENABLE/DISABLE	TANK 2 LOW LEVEL
7	SELECTOR, 2-POS	ENABLE/DISABLE	TANK 3 LOW LEVEL
8	SELECTOR, 2-POS	ENABLE/DISABLE	TANK 4 LOW LEVEL
9	SELECTOR, 2-POS	ENABLE/DISABLE	TANK 5 LOW LEVEL
10	SELECTOR, 2-POS	ENABLE/DISABLE	TANK 6 LOW LEVEL
11	SELECTOR, 2-POS	ENABLE/DISABLE	TANK 7 LOW LEVEL
12	SELECTOR, 2-POS	ENABLE/DISABLE	TANK 8 LOW LEVEL
13	SELECTOR, 2-POS	ENABLE/DISABLE	LOW DO 1
14	SELECTOR, 2-POS	ENABLE/DISABLE	LOW DO 2
15	SELECTOR, 2-POS	ENABLE/DISABLE	SUPPLY LS FAULT
16	SELECTOR, 2-POS	ENABLE/DISABLE	RECIRC LS FAULT
17	SELECTOR, 2-POS	ENABLE/DISABLE	PA LS FAULT
18	SELECTOR, 2-POS	ENABLE/DISABLE	CO2 BLWR 1 FAULT
19	SELECTOR, 2-POS	ENABLE/DISABLE	CO2 BLWR 2 FAULT
20	SELECTOR, 2-POS	ENABLE/DISABLE	UV DISINFECTION FAULT
21	SELECTOR, 2-POS	ENABLE/DISABLE	DRUM FILTER FAULT
22	SELECTOR, 2-POS	ENABLE/DISABLE	CONC. POND LOW LEVEL
23	SELECTOR, 2-POS	ENABLE/DISABLE	UTILITY POWER FAULT
24	SELECTOR, 2-POS	ENABLE/DISABLE	GENERATOR FAULT
25	SELECTOR, 2-POS	ENABLE/DISABLE	ATS IN STANDBY
26	SELECTOR, 2-POS	ENABLE/DISABLE	(BLANK)

GENERAL NOTES:



- CONTROL PANEL FABRICATED ACCORDING TO SPEC. 40 67 00.
- CONTROL AUXILIARIES PER SPEC 40 78 00. NOT ALL REQUIRED COMPONENTS ARE SHOWN ON THIS DRAWING.
- SECURE ENCLOSURE TO CONCRETE WITH CONCRETE ANCHORS.
- PROVIDE CONTROL PANEL WITH DOOR ACTIVATED, LED TYPE LIGHT FIXTURE.

KEYED NOTES:

- SINGLE-DOOR, FREE-STANDING, PAINTED STEEL ENCLOSURE WITH NEMA 4 ENCLOSURE RATING. PROVIDE WITH INTERNAL MOUNTING PANEL(S).
- ANNUNCIATOR WITH HINGED COVER FOR NEMA 4 RATING. EACH ANNUNCIATOR INPUT SHALL BE PROVIDED WITH A REPEAT RELAY CONFIGURED TO FOLLOW ALARM INPUT STATUS.
- ALARM DIALER MOUNTED TO INTERNAL SIDE PANEL. TELEPHONE SERVICE SHALL BE PROVIDED.
- SHELF MOUNTED UNINTERRUPTIBLE POWER SUPPLY TO PROVIDE PROTECTED POWER TO THE ANNUNCIATOR AND ALARM DIALER.
- EACH ALARM INPUT SHALL INCLUDE AN ENABLE/DISABLE SELECTOR SWITCH. ALARMS SHALL BE GROUPED AS REQUIRED TO PROVIDE INPUTS TO THE ALARM ANNUNCIATOR.

ALARM PANEL AP200
FRONT ELEVATION

SCALE: NONE

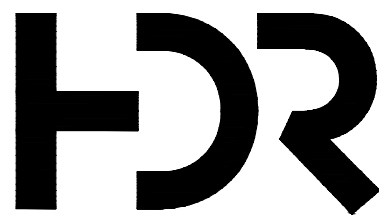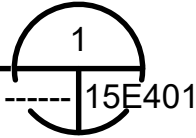


ISSUE	DATE	DESCRIPTION

PROJECT MANAGER	ERIC ORTON P.E.
DESIGN BY	DB
DESIGN BY	
CHECKED BY	TM
DRAWN BY	EP
PLOT DATE	May 18, 2023
PROJECT NUMBER	10176455





KALAMA CREEK HATCHERY
PHASE 2
NATURAL RESOURCES DEPARTMENT
NISQUALLY INDIAN TRIBE
EDA AWARD NUMBER 07-79-07880

CIRCULAR TANK BUILDING
ALARM PANEL (AP200)

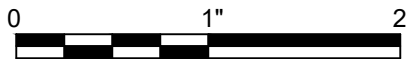


FILENAME	15E401.DWG
SCALE	AS NOTED

SHEET
15E401

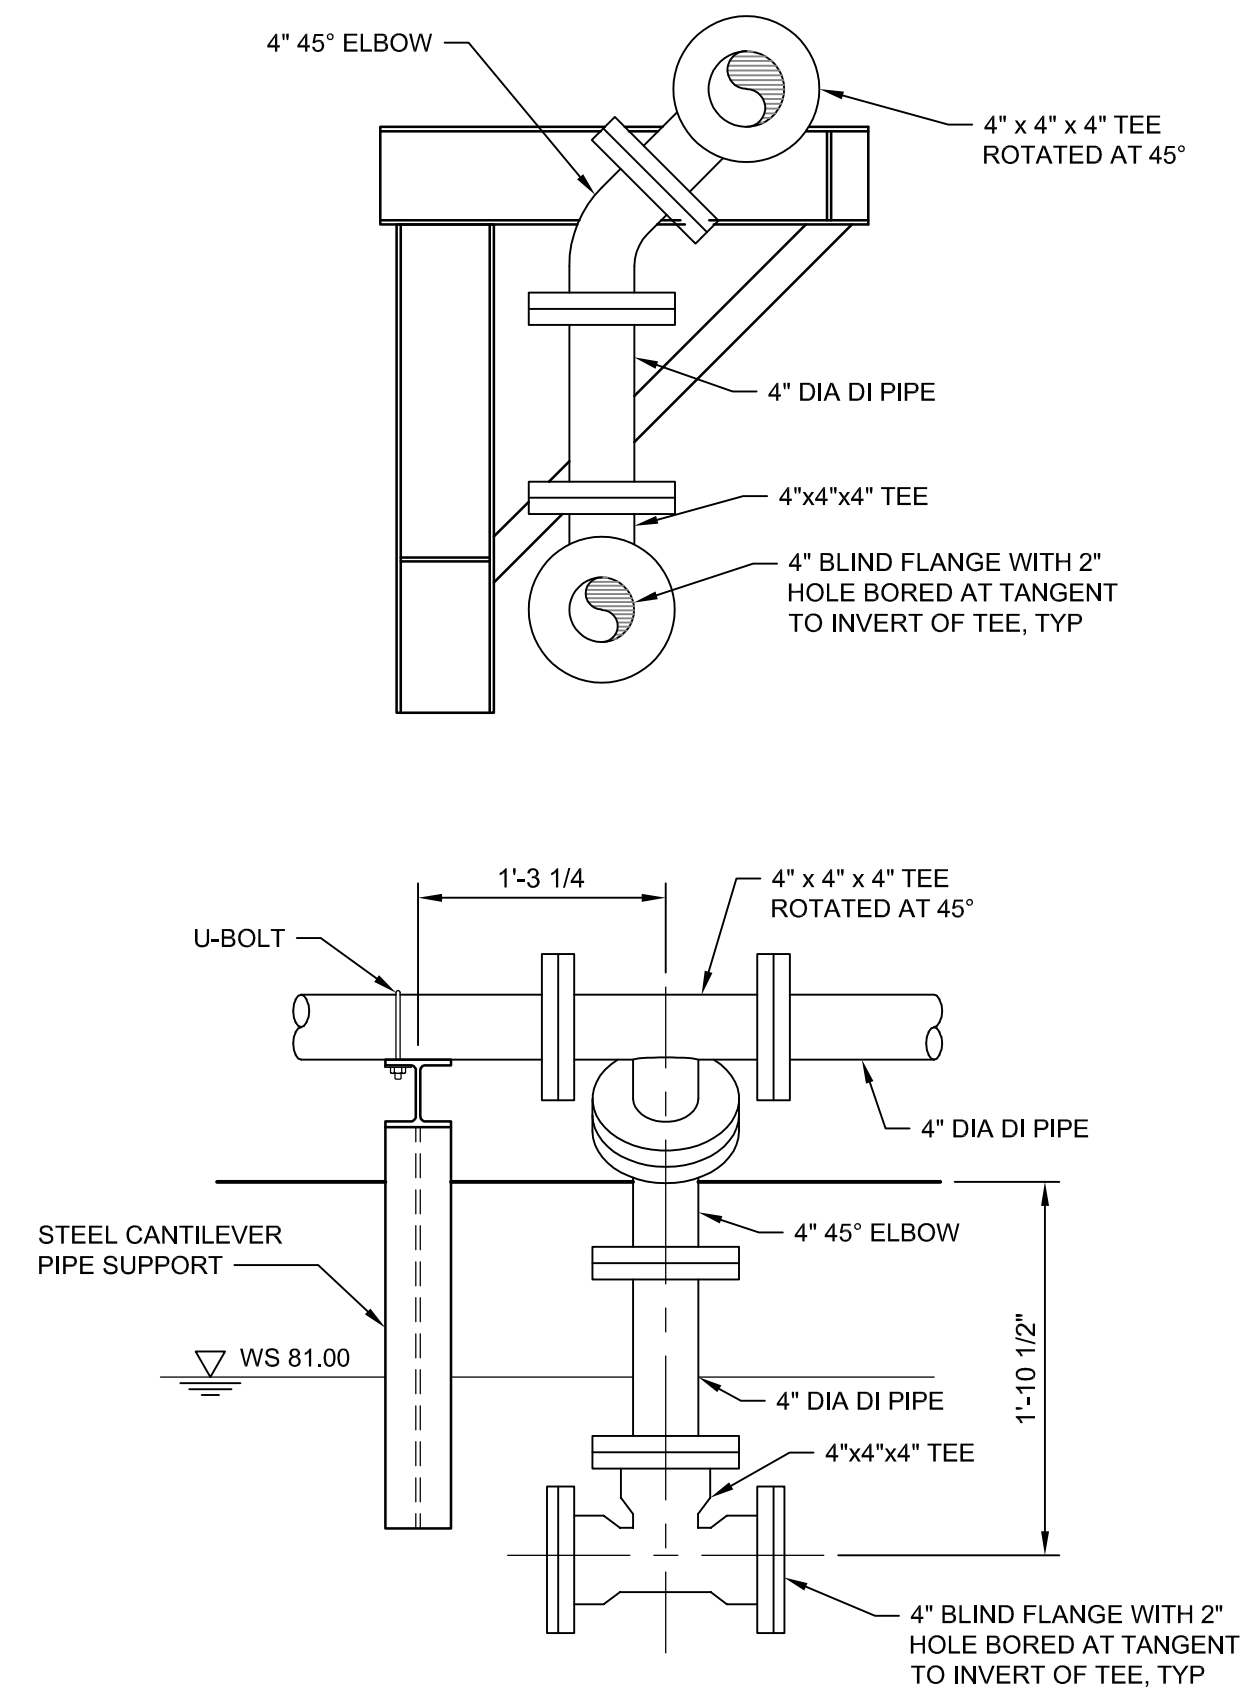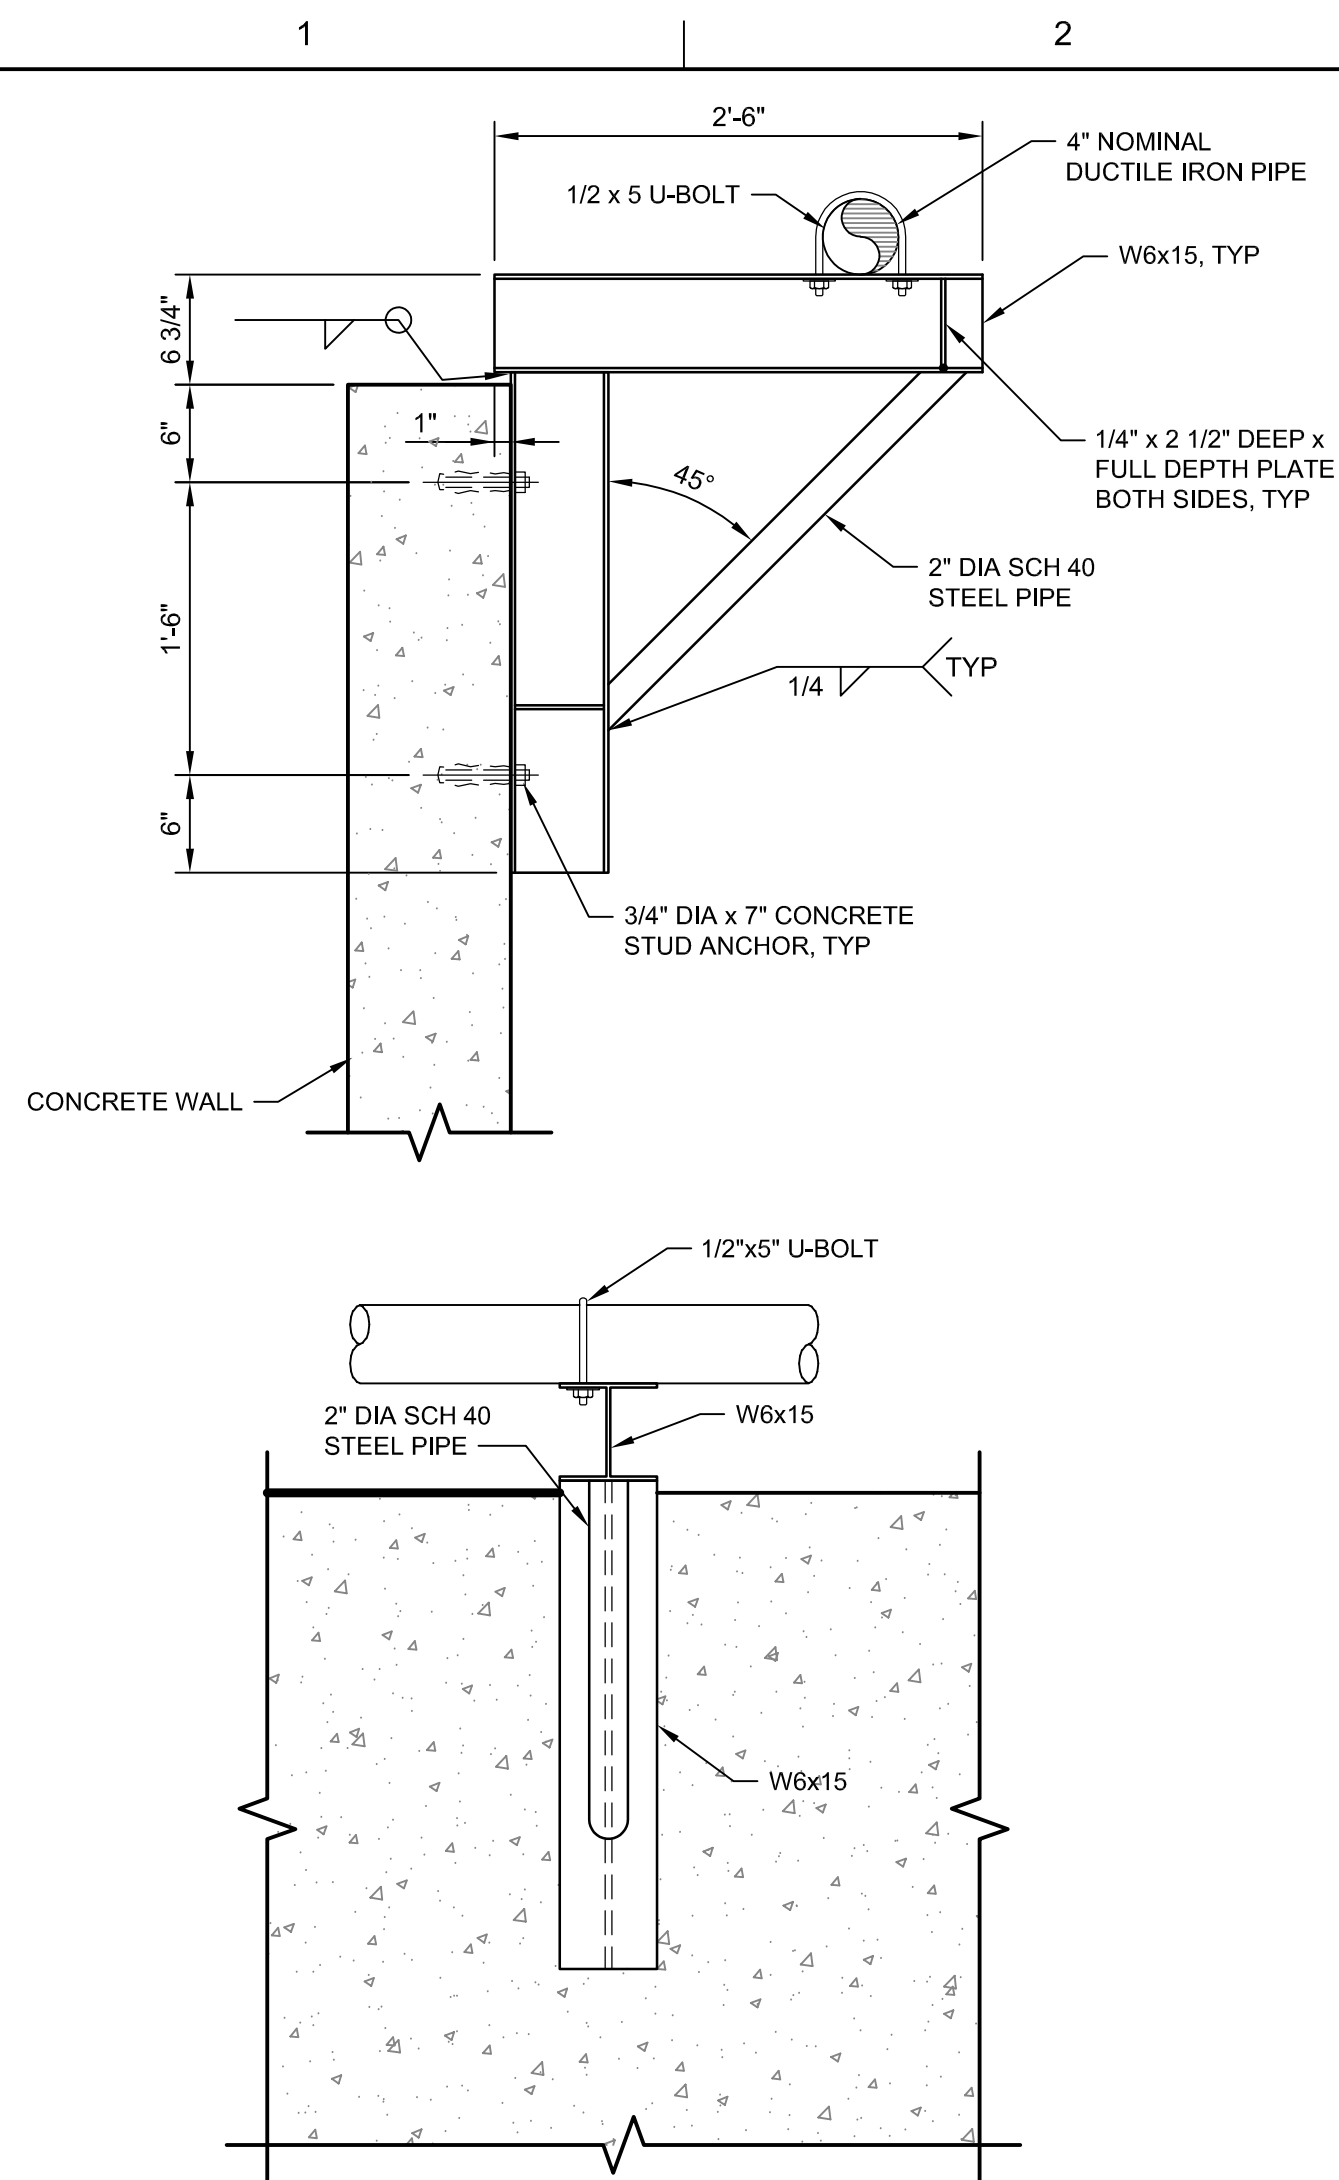


INLET DETAIL
NOT TO SCALE



16D101 16D401

[illegible]

PROJECT MANAGER	ERIC ORTON P.E.
DESIGN BY	EEO
DESIGN BY	
CHECKED BY	
DRAWN BY	ACB
PLOT DATE	May 18, 2023
PROJECT NUMBER	10176455

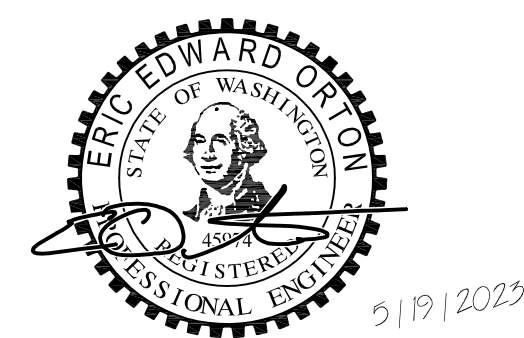


**KALAMA CREEK HATCHERY
PHASE 2**

**NATURAL RESOURCES DEPARTMENT
NISQUALLY INDIAN TRIBE**

EDA AWARD NUMBER 07-79-07880



POLLUTION ABATEMENT POND LOWER SITE

SECTIONS

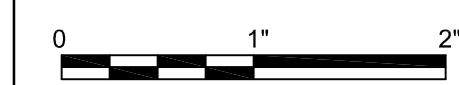


FILENAME	16D401.DWG
SCALE	AS NOTED

SHEET
16D401

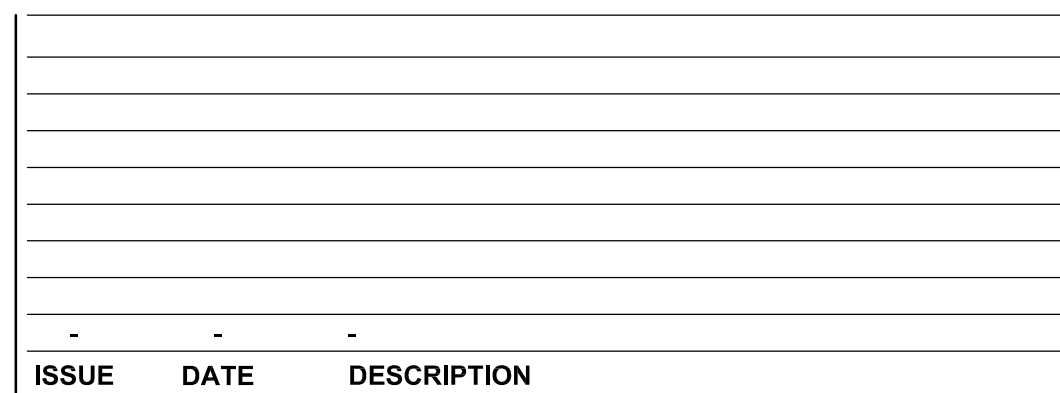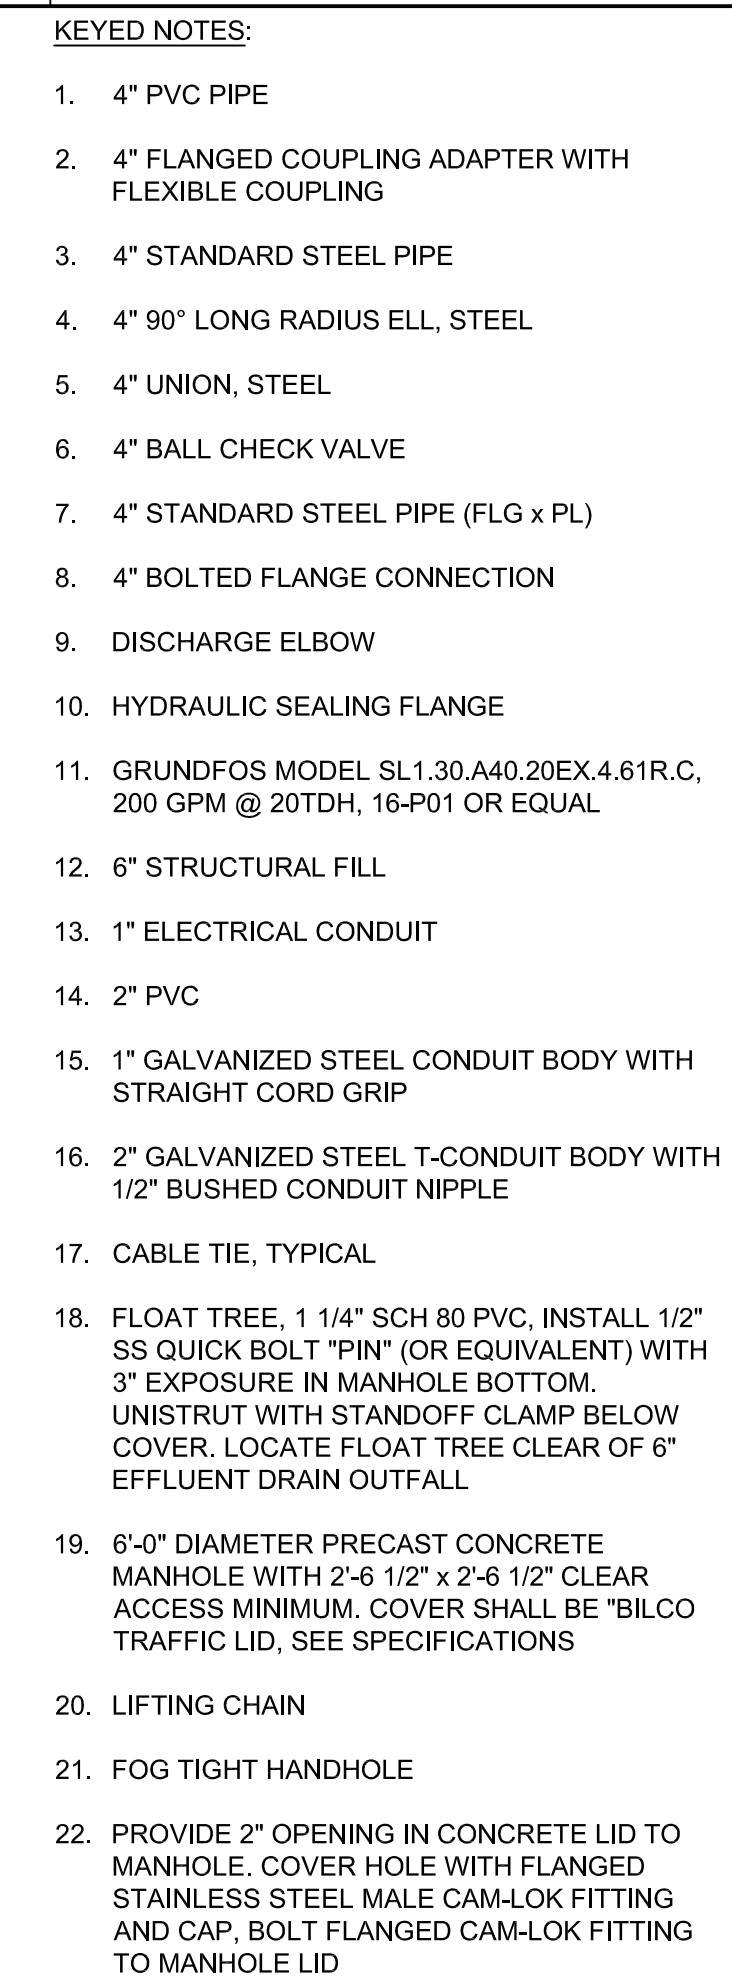


PROJECT MANAGER	ERIC ORTON	P.E.
DESIGN BY	EEO	
DESIGN BY		
CHECKED BY		
DRAWN BY	ACB	
PLOT DATE	May 18, 2023	
PROJECT NUMBER	10176455	

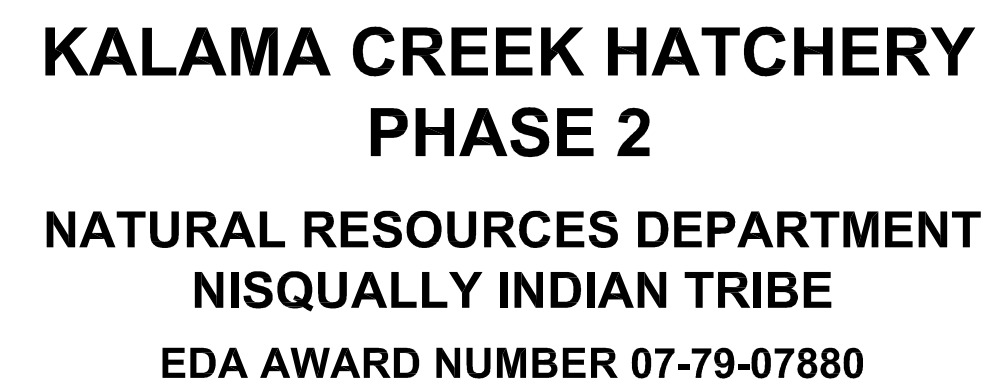

A horizontal scale bar with alternating black and white segments. It is labeled '0' at the left end and '1"' at the right end.

FILENAME	16D402.DWG
SCALE	AS NOTED

SHEET
16D402

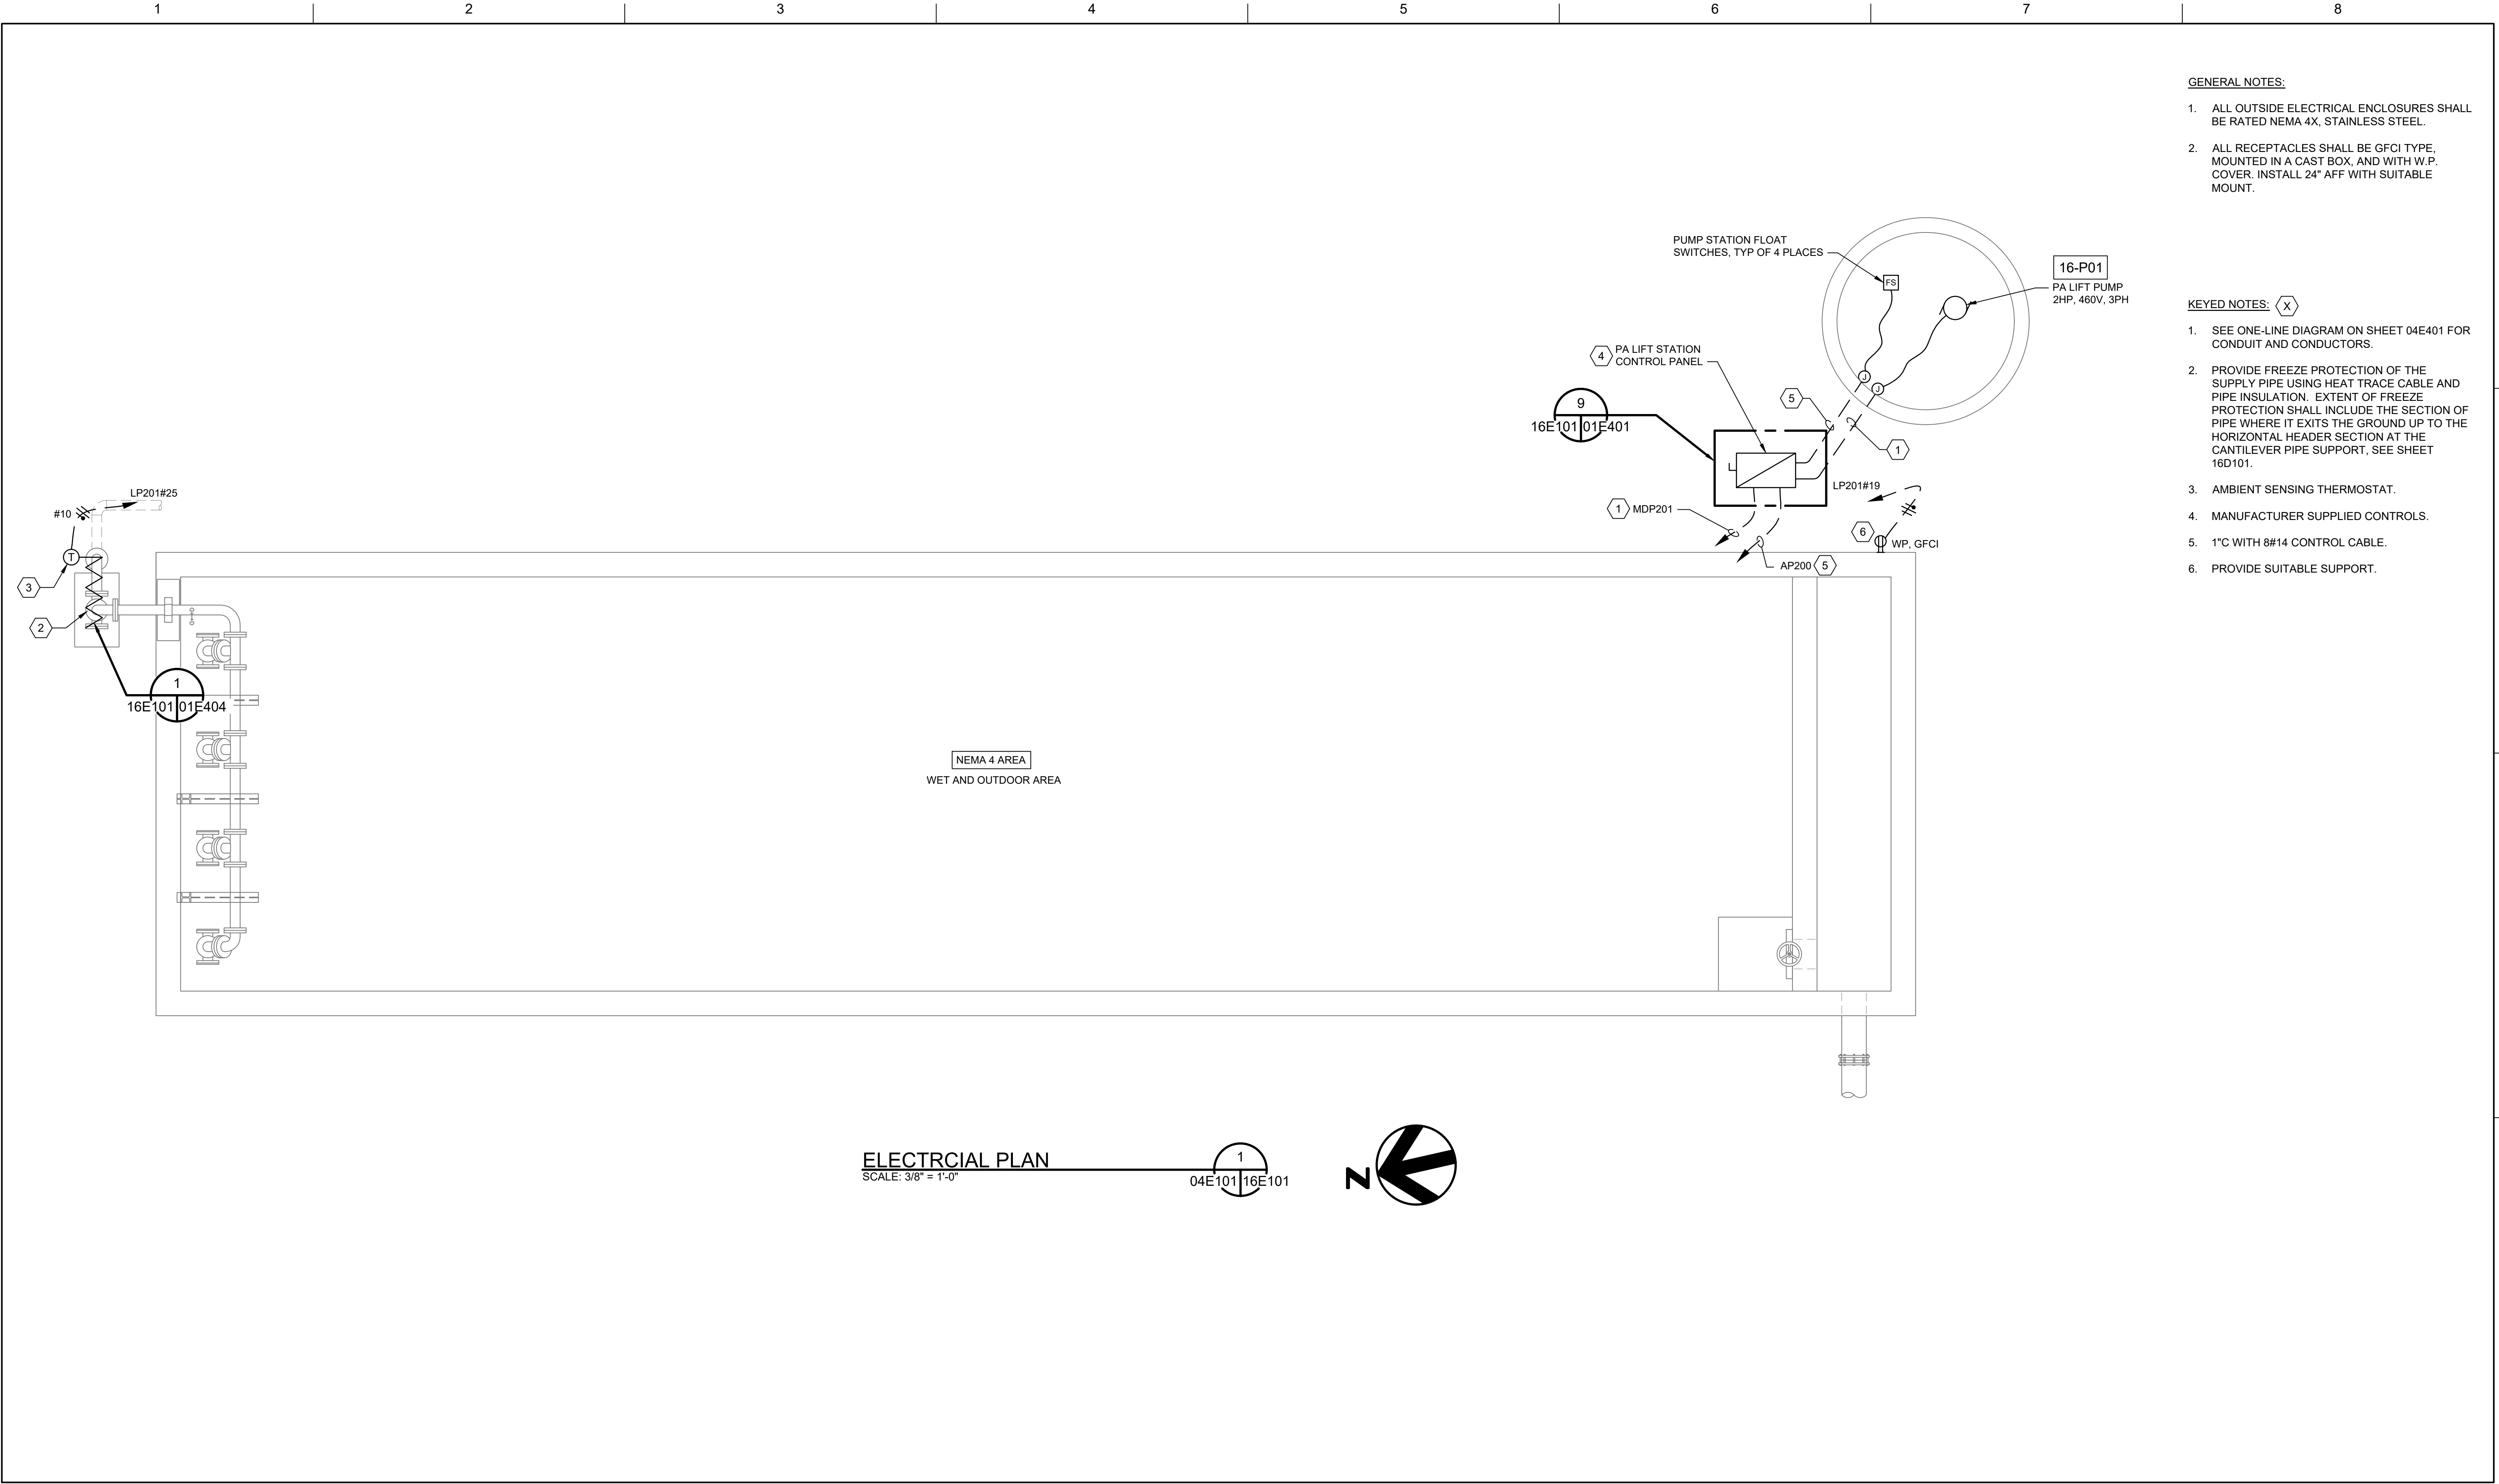

GENERAL NOTES:



1. ALL OUTSIDE ELECTRICAL ENCLOSURES SHALL BE RATED NEMA 4X, STAINLESS STEEL.
2. ALL RECEPTACLES SHALL BE GFCI TYPE, MOUNTED IN A CAST BOX, AND WITH W.P. COVER. INSTALL 24" AFF WITH SUITABLE MOUNT.

KEYED NOTES: (X)

1. SEE ONE-LINE DIAGRAM ON SHEET 04E401 FOR CONDUIT AND CONDUCTORS.
2. PROVIDE FREEZE PROTECTION OF THE SUPPLY PIPE USING HEAT TRACE CABLE AND PIPE INSULATION. EXTENT OF FREEZE PROTECTION SHALL INCLUDE THE SECTION OF PIPE WHERE IT EXITS THE GROUND UP TO THE HORIZONTAL HEADER SECTION AT THE CANTILEVER PIPE SUPPORT, SEE SHEET 16D101.
3. AMBIENT SENSING THERMOSTAT.
4. MANUFACTURER SUPPLIED CONTROLS.
5. 1" C WITH 8#14 CONTROL CABLE.
6. PROVIDE SUITABLE SUPPORT.

ELECTRICAL PLAN

SCALE: 3/8" = 1'-0"

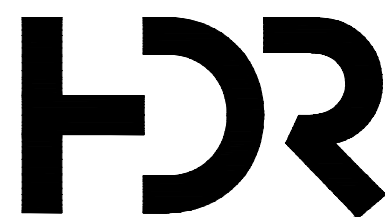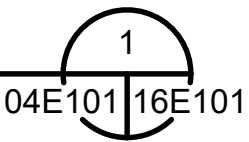


ISSUE	DATE	DESCRIPTION

PROJECT MANAGER	ERIC ORTON P.E.
DESIGN BY	DB
DESIGN BY	
CHECKED BY	TM
DRAWN BY	AB
PLOT DATE	May 18, 2023
PROJECT NUMBER	10176455



**KALAMA CREEK HATCHERY
PHASE 2**
**NATURAL RESOURCES DEPARTMENT
NISQUALLY INDIAN TRIBE**
EDA AWARD NUMBER 07-79-07880

**POLLUTION ABATEMENT POND
LOWER SITE**
ELECTRICAL PLAN

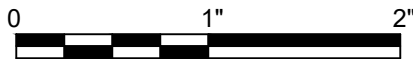

FILENAME	16E101.DWG
SCALE	AS NOTED

SHEET
16E101